


PROJECT	DESIGNATION NO.
1902834	1902834
CONTRACT	BRIDGE FILE
B-42844	ALLEN 358

INDIANA DEPARTMENT OF TRANSPORTATION

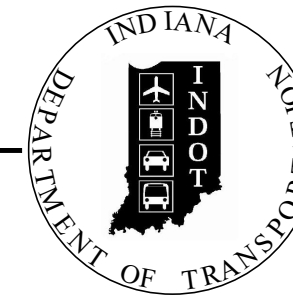

TRAFFIC DATA	BLUFFTON ROAD	BROADWAY	VESEY AVENUE	OAKDALE DRIVE
A.A.D.T. (2025)	28,600 V.P.D.	20,500 V.P.D.	250 V.P.D.	840 V.P.D.
A.A.D.T. (2045)	34,900 V.P.D.	25,015 V.P.D.	305 V.P.D.	1,025 V.P.D.
D.H.V. (2045)	3,490 V.P.H.	2,502 V.P.H.	31 V.P.H.	103 V.P.H.
DIRECTIONAL DISTRIBUTION	50 %	50 %	50 %	100 %
TRUCKS	698 V.P.D. A.A.D.T. 70 V.P.H. D.H.V.	500 V.P.D. A.A.D.T. 50 V.P.H. D.H.V.	3 V.P.D. A.A.D.T. 1 V.P.H. D.H.V.	10 V.P.D. A.A.D.T. 1 V.P.H. D.H.V.
DESIGN DATA	BLUFFTON ROAD	BROADWAY	VESEY AVENUE	OAKDALE DRIVE
DESIGN SPEED	35 MPH	30 MPH	30 MPH	30 MPH
PROJECT DESIGN CRITERIA	3R (Non-Freeway)	3R (Non-Freeway)	3R (Non-Freeway)	3R (Non-Freeway)
FUNCTIONAL CLASSIFICATION	Minor Arterial	Minor Arterial	Local Street	Local Street
RURAL/URBAN	Urban (Built-Up)	Urban (Built-Up)	Urban (Built-Up)	Urban (Built-Up)
TERRAIN	Level	Level	Level	Level
ACCESS CONTROL	None	None	None	None


STRUCTURE INFORMATION				
STRUCTURE	TYPE	SPAN AND SKEW	OVER	STATION
ALLEN COUNTY BRIDGE 358	CONTINUOUS COMPOSITE TYPE III PRESTRESSED CONCRETE I-BEAM	5 SPAN @ 65'-0", 65'-0", 65'-0", 70'-0" & 65'-0" SKEW: NONE	ST. MARY'S RIVER	47+48.10 "B"

BRIDGE REHABILITATION PLANS FOR SPANS OVER 20 FEET

ON
BLUFFTON ROAD OVER
ST MARY'S RIVER

PROJECT NO. 1902834 P.E.
1902834 R/W
1902834 CONST.

SUPER STRUCTURE REPLACEMENT OF STRUCTURE 02-00358 (ALLEN COUNTY BR. #358),
CARRYING BLUFFTON ROAD OVER ST MARY'S RIVER, LOCATED IN
SECTION 15, T30N, R12E, WAYNE TOWNSHIP,
ALLEN COUNTY, INDIANA.

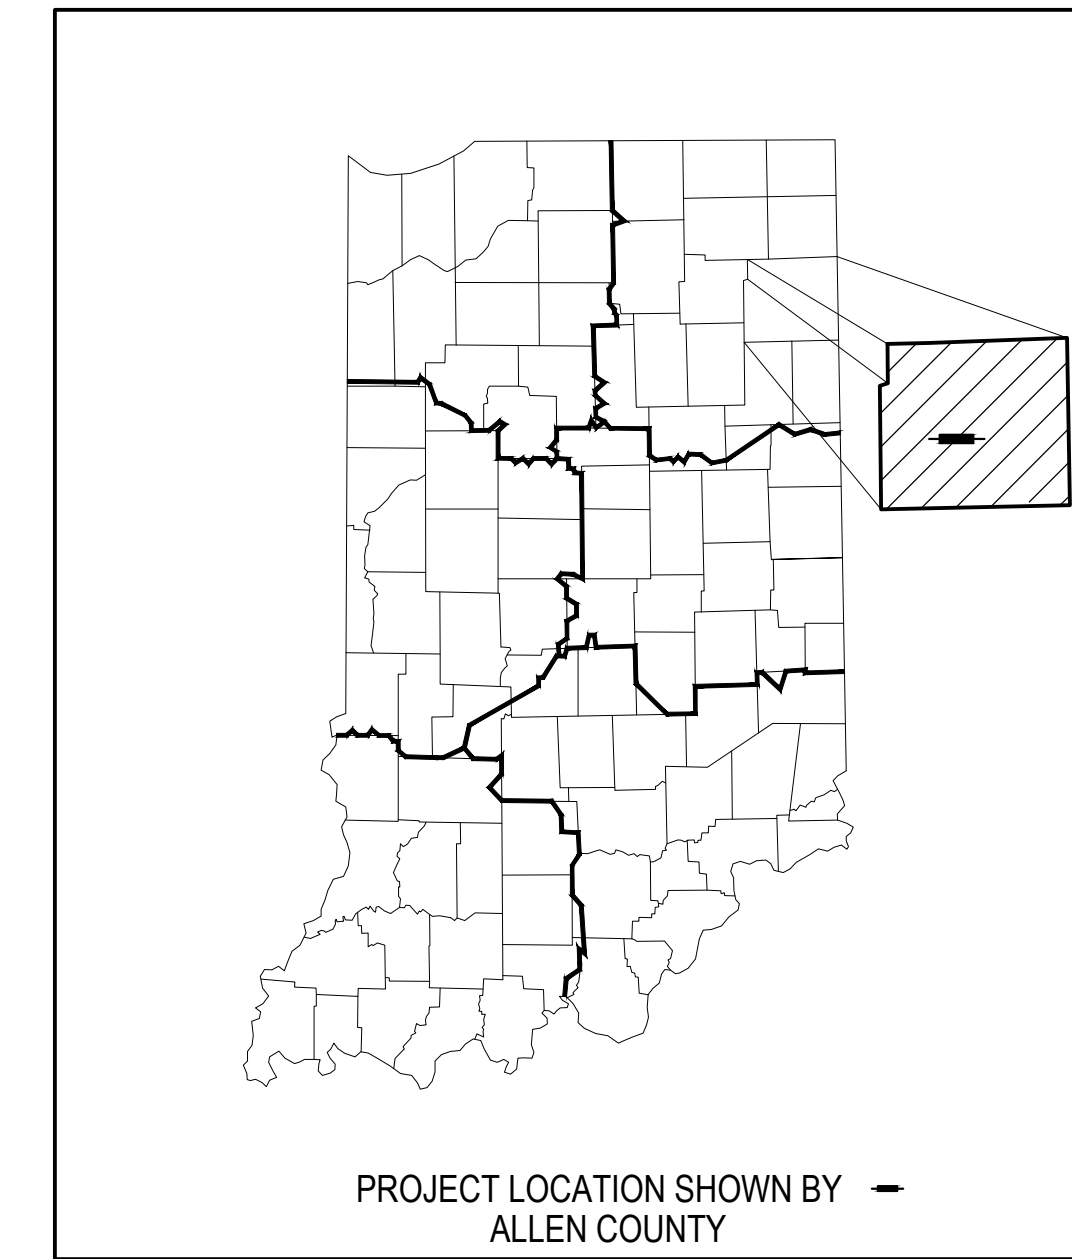

LATITUDE: 41°03'07.51" N LONGITUDE: 85°09'24.49" W

BRIDGE LENGTH = 0.063 mi.
ROAD LENGTH = 0.096 mi.
TOTAL LENGTH = 0.159 mi.
MAX. GRADE = +2.73%

HUC: 041000040606


APPROVED BY: _____ DATE: _____

PATRICK ZAHARAKO, PE, MBA - CITY OF FORT WAYNE ENGINEER
& EMPLOYEE IN RESPONSIBLE CHARGE (ERC)

APPROVED BY
CITY OF FORT WAYNE BOARD OF PUBLIC WORKS

ATTEST _____ DATE _____

RECOMMENDED FOR APPROVAL _____ DATE _____

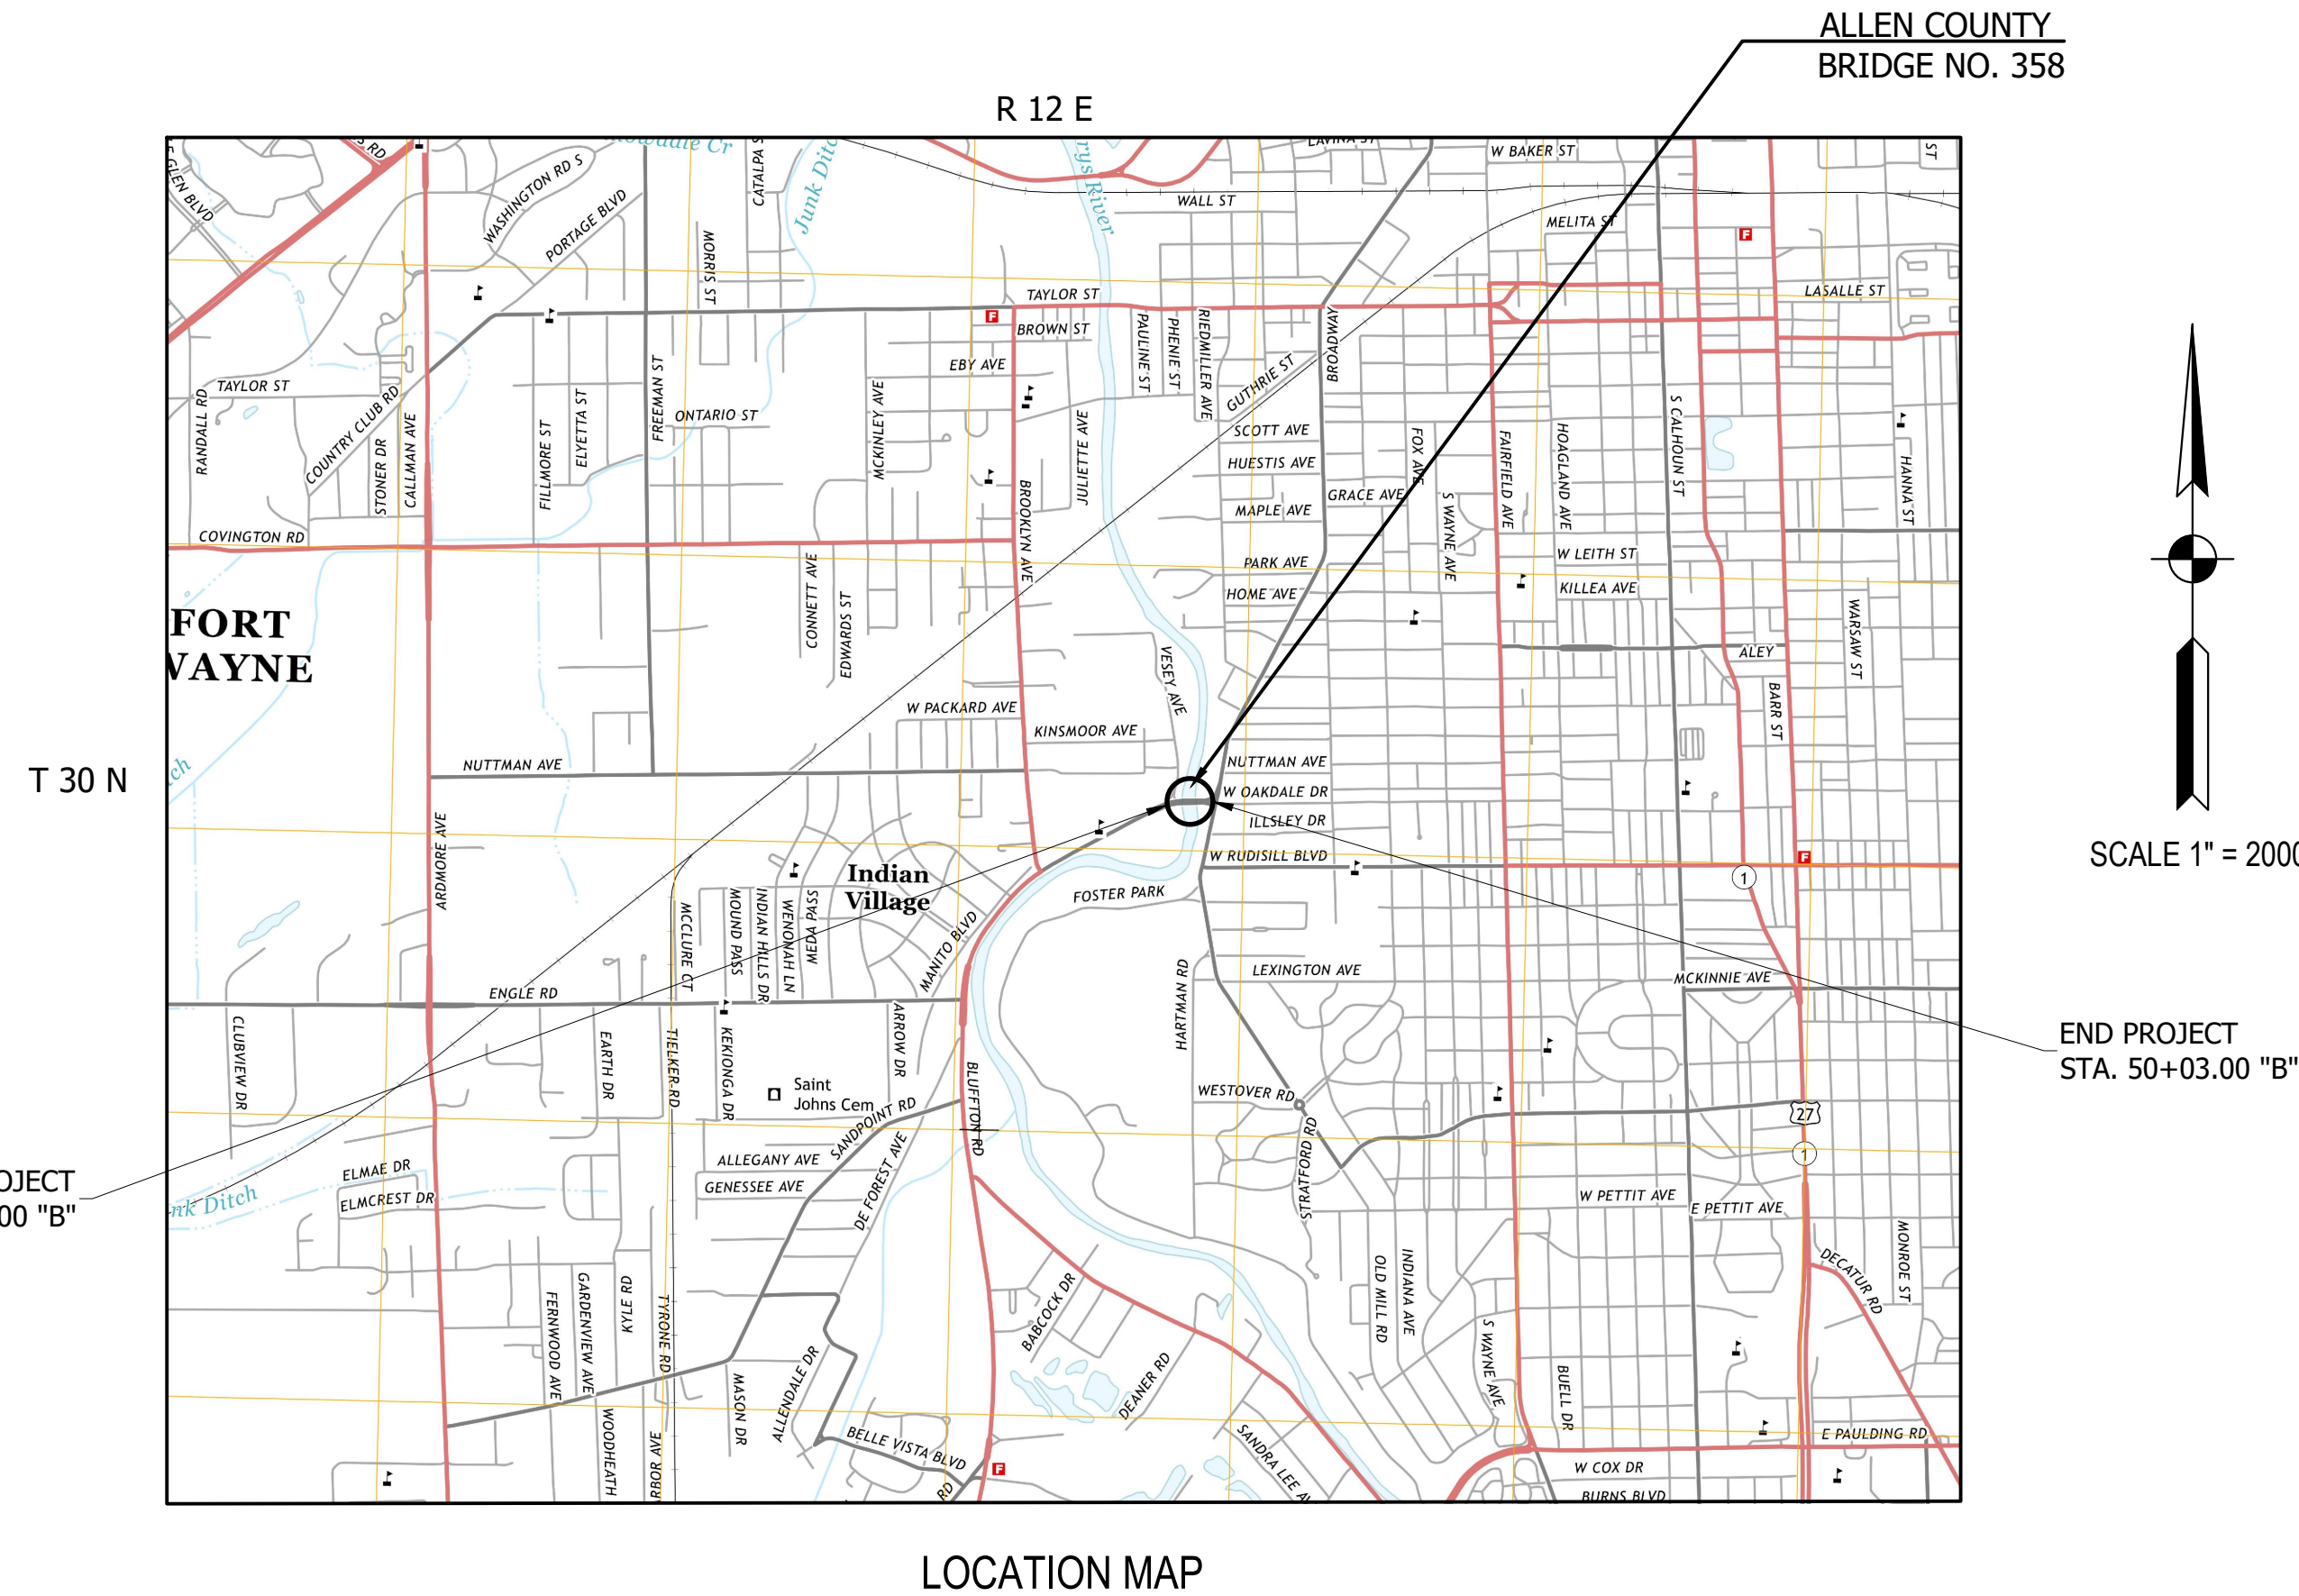

INDIANA DEPARTMENT OF TRANSPORTATION
STANDARD SPECIFICATIONS DATED 2022
TO BE USED WITH THESE PLANS



NOT FOR
CONSTRUCTION

PLANS PREPARED BY:	USI Consultants, Inc.	317-544-4996
		PHONE NUMBER
CERTIFIED BY:	_____	DATE
APPROVED FOR LETTING:	_____	DATE
INDIANA DEPARTMENT OF TRANSPORTATION		

BRIDGE FILE	
ALLEN 358	
DESIGNATION NO.	
1902834	
SHEETS	
1	of 63
CONTRACT	
B-42844	
PROJECT NO.	
1902834	

UTILITIES

AEP - DISTRIBUTION

110 E. Wayne Street
Fort Wayne, IN 46802
Contact: Trevor Stanley
PH: (260) 408-3707
Cell: (260) 205-0063
Email: twstanley@aep.com

AEP - TRANSMISSION

8600 Smiths Mill Road
New Albany, OH 43054
Contact: Joshua Adams
PH: (614) 933-2297
Email: tl_publicprojects@aep.com

FRONTIER

8001 West Jefferson Blvd.
Fort Wayne, IN 46804
Contact: Phil Ramos
PH: (260) 461-2761
Email: philip.ramos@ftr.com

KEPS TECHNOLOGIES

1800 North Grand River Ave.
Lansing, MI 48906
Contact: Susan Steadman
PH: (517) 999-3291
Email: steadman.susan@acd.net
Contact: Phil Brown
PH: (517) 999-3213
Email: brown.phil@acd.net

COMCAST

720 Taylor Street
Fort Wayne, IN 46802
Contact: Doug Fishburn
PH: (260) 410-3504
Email: william_fishburn@cable.comcast.com

CITY OF FORT WAYNE

1 East Main Street
Fort Wayne, IN 46802-1804
Contact: Kristen Buell
Email: kristen.buell@cityoffortwayne.org

ZAYO

722 South High School Road
Indianapolis, IN 46214
Contact: Mark Zoltek
Email: mark.zoltek@zayo.com

NIPSCO - GAS

1501 Hale Avenue
Fort Wayne, IN 46802
Contact: Venessa Rivera
Email: vrivera@nisource.com



**1-800-382-5544
CALL BEFORE YOU DIG**

CAUTION !!

THE LOCATIONS OF ALL EXISTING UNDERGROUND UTILITIES SHOWN ON THIS PLAN ARE BASED UPON ABOVE GROUND EVIDENCE (including, but not limited to, manholes, inlets, valves, and marks made upon the ground by others) AND ARE SPECULATIVE IN NATURE. THERE MAY ALSO BE OTHER EXISTING UNDERGROUND UTILITIES FOR WHICH THERE IS NO ABOVE GROUND EVIDENCE OR FOR WHICH NO ABOVE GROUND EVIDENCE WAS OBSERVED. THE EXACT LOCATIONS OF SAID EXISTING UNDERGROUND UTILITIES SHALL BE VERIFIED BY THE CONTRACTOR PRIOR TO ANY AND ALL CONSTRUCTION.

INDEX

SHEET NO.	DESCRIPTION
1	TITLE SHEET
2	INDEX
3	TYPICAL CROSS SECTIONS
4-5	LOCATION CONTROL ROUTE SURVEY
6-11	MAINTENANCE OF TRAFFIC
12	BLUFFTON ROAD AND VESEY AVE. DETOUR ROUTE
13	PEDESTRIAN DETOUR ROUTE
14	KAYAKER DETOUR ROUTE
15	PLAN AND PROFILE - LINE "B"
16	PLAN AND PROFILE - LINE "P"
17	SUPERELEVATION TRANSITION DIAGRAM
18-19	CONSTRUCTION DETAILS
20	INTERSECTION DETAILS
21-24	CURB RAMP DETAILS
25-26	PAVEMENT MARKINGS & SIGNING DETAILS
27	SIGNAL PLAN
28	LIGHTING PLAN
29-30	EROSION CONTROL DETAILS
31-33	SOIL BORINGS
34	LAYOUT - LINE "B"
35-36	GENERAL PLAN - EXISTING
37-38	GENERAL PLAN - PROPOSED
39-40	MISCELLANEOUS TABLES
41-63	CROSS SECTIONS

REVISIONS

SHEET NO.	DESCRIPTION


NOT FOR CONSTRUCTION

DESIGNED: BMA DRAWN: BDC
CHECKED: KAM CHECKED: BMA


**INDIANA
DEPARTMENT OF TRANSPORTATION**

INDEX


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NONE	ALLEN 358
VERTICAL SCALE	DESIGNATION
NONE	1902834
SURVEY BOOK	SHEETS
---	2 of 63
CONTRACT	PROJECT
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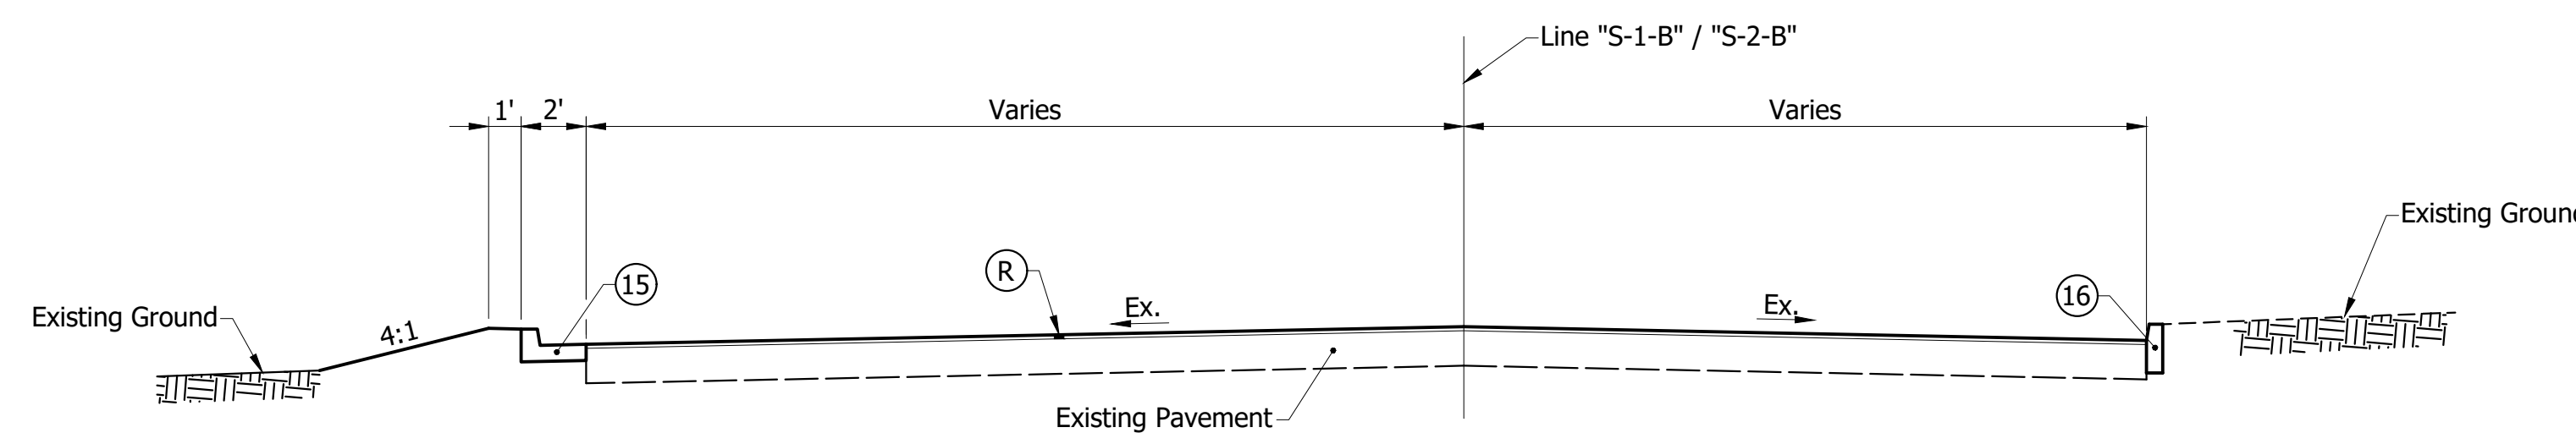
TANGENT SECTION
Sta. 41+65.00 to Sta. 42+25.00 "B"

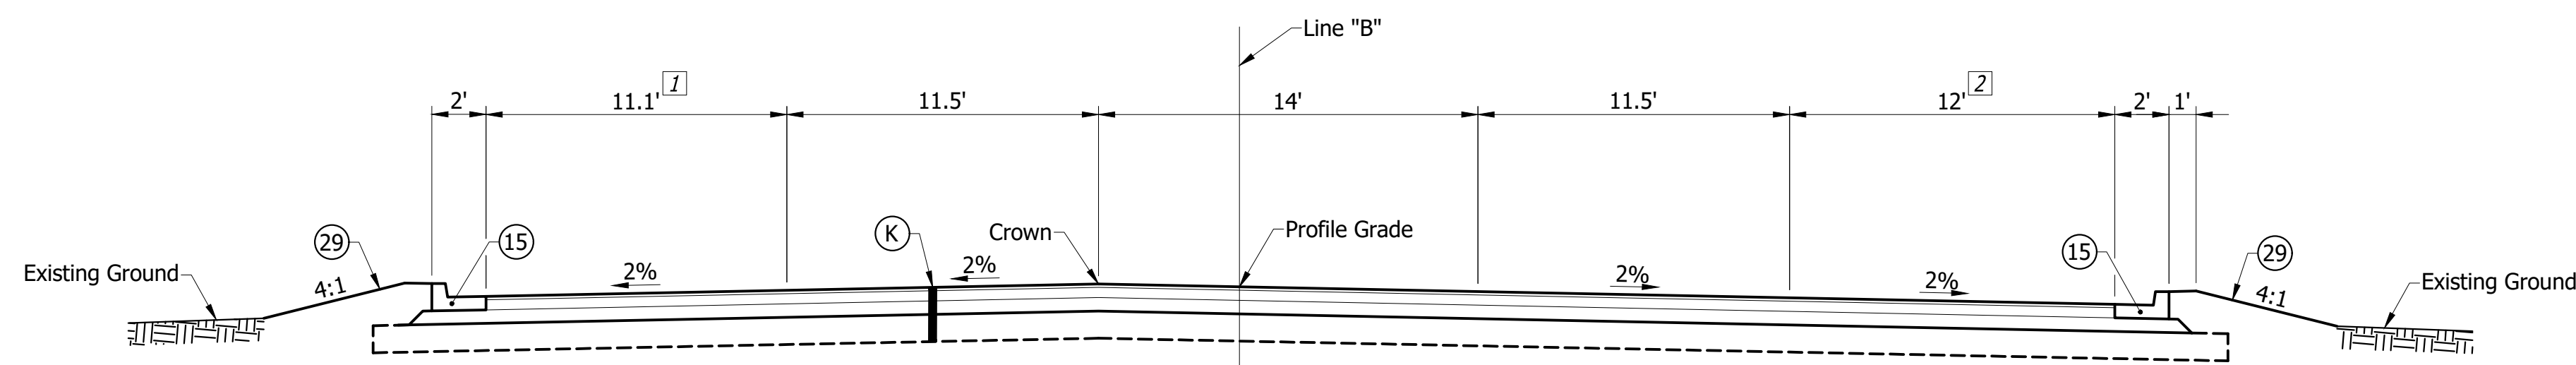


SUPERELEVATED SECTION
Sta. 42+25.00 to Sta. 45+54.73 "B"

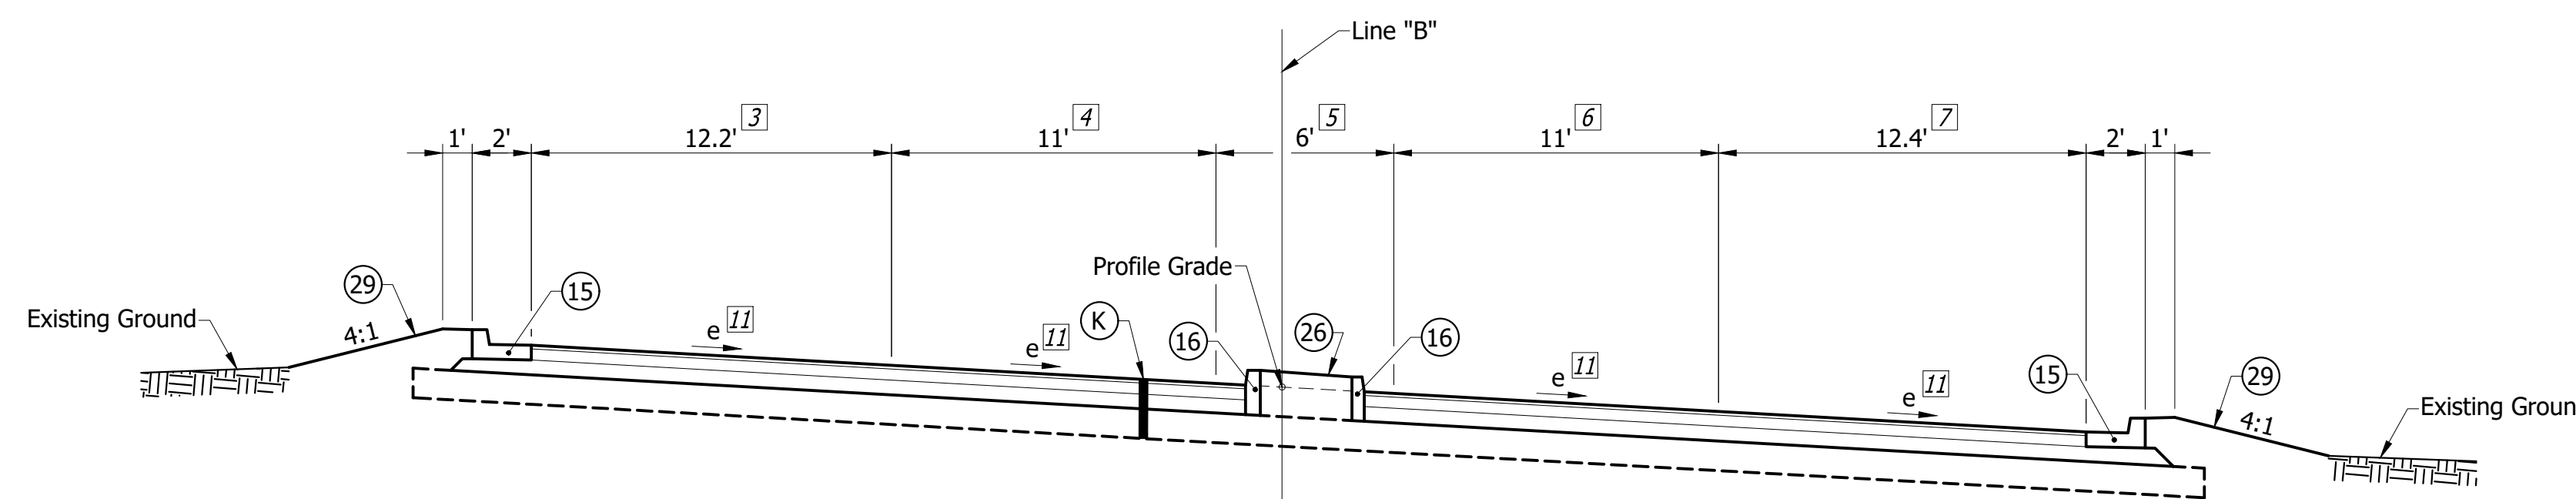


TANGENT SECTION
Sta. 10+30.11 to Sta. 11+56.23 "S-3-B"

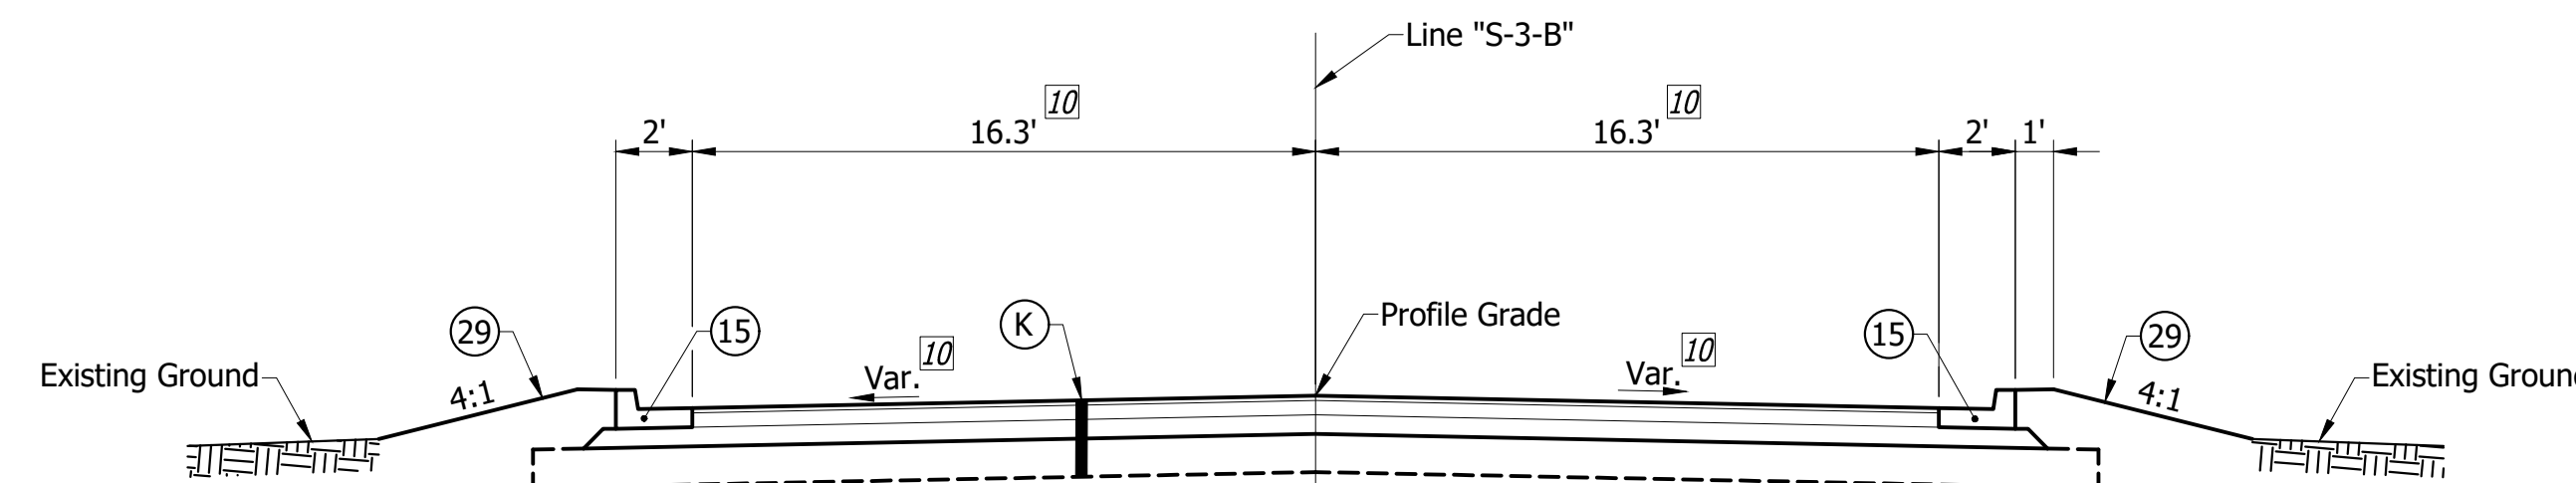

TANGENT SECTION
Sta. 8+71.04 to Sta. 10+00.00 "S-1-B"
Sta. 10+00.00 to Sta. 10+87.86 "S-2-B"

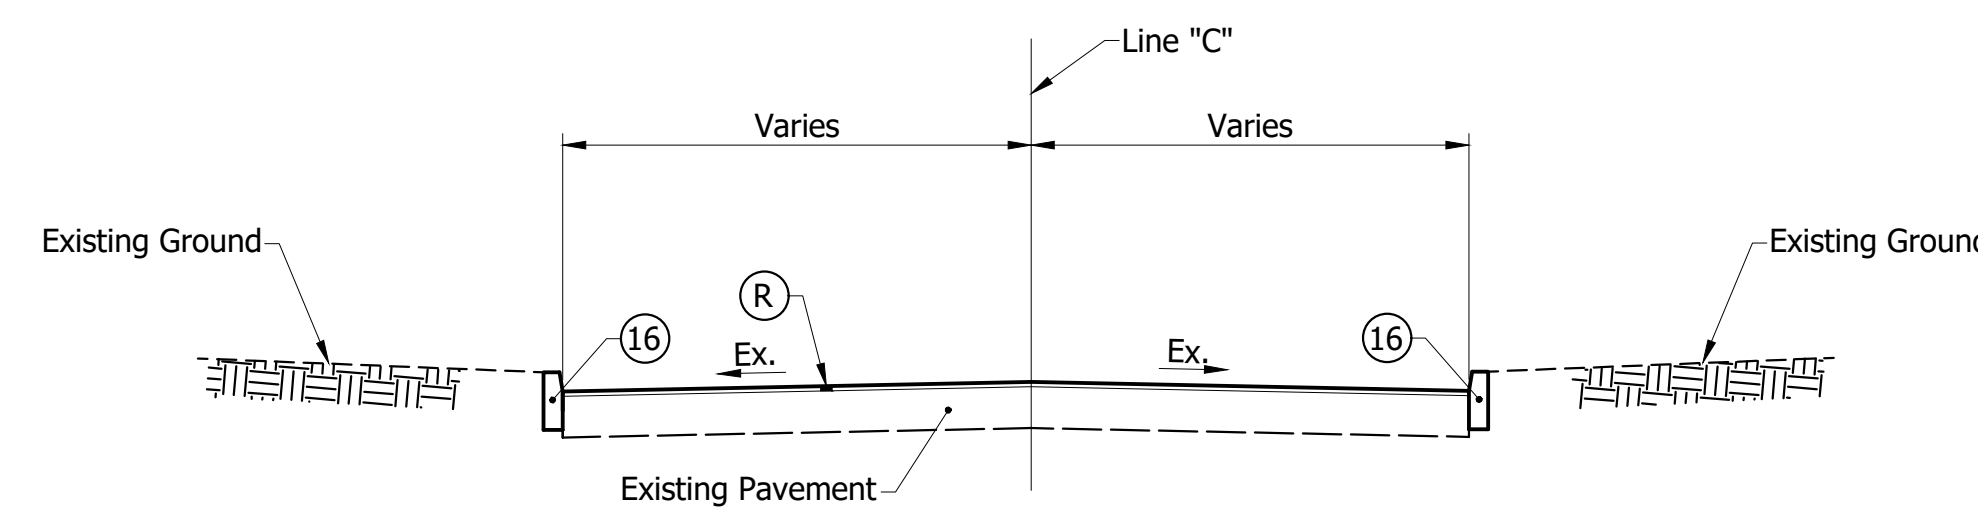

TANGENT SECTION
Sta. 10+00.00 to Sta. 10+56.00 "C"

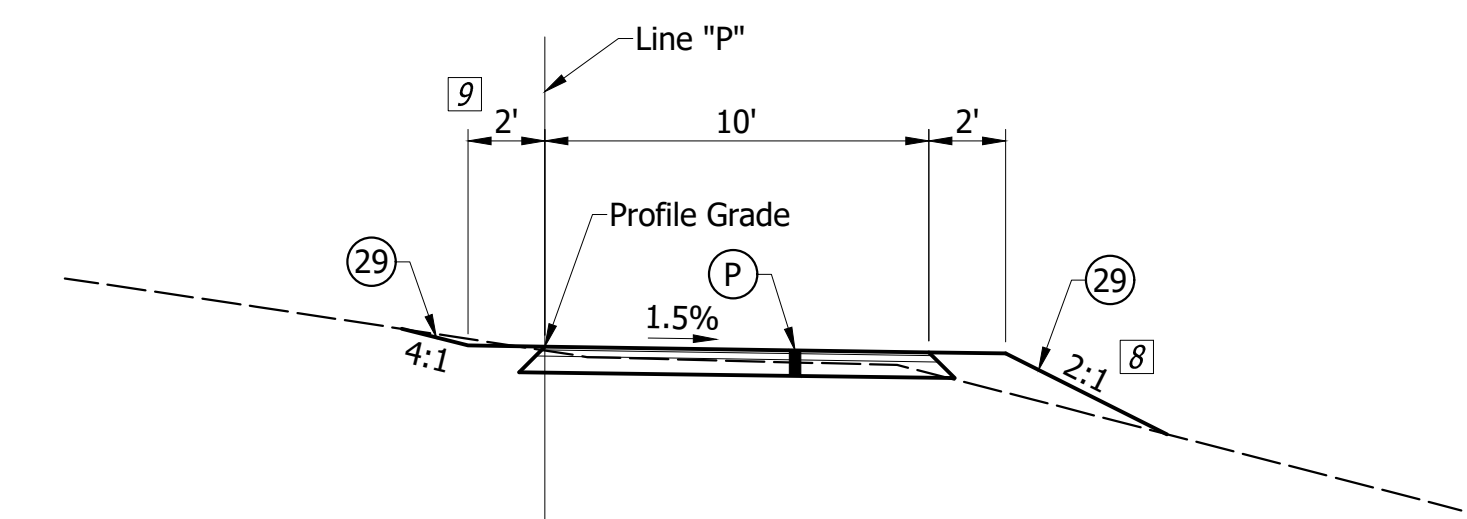

MULTI-USE PATH SECTION
Sta. 0+00 to Sta. 4+07 "P"

LEGEND

- (K) Full Depth Pavement
165#/Syd QC/QA HMA, 3, 64, Surface, 9.5 mm on
495#/Syd QC/QA HMA, 3, 64, Intermediate, 19.0 mm on
660#/Syd QC/QA HMA, 3, 64, Base, 25.0 mm on
Subgrade Treatment Type "IV" on
Geotextile for Subgrade, Type 2B
- (R) HMA Resurfacing
165#/Syd QC/QA-HMA, 3, 64, Surface 9.5 mm on
1 1/2" Surface Milling of Existing HMA Pavement
- (P) HMA Multi-Use Path
110#/Syd Surface, 9.5 mm Type A on
220#/Syd Intermediate, 19.0 mm Type A on
6" Compacted Aggregate Base No. 53
- (F) Concrete Sidewalk
- (15) Concrete Curb and Gutter, Type II-B
- (16) Concrete Curb Type III
- (26) Sodding, Nursery
- (29) Seeding, U

NOTES:

- [1] Width varies from xx.x' @ Sta. xx to xx.x' @ Sta.
- [2] Width varies from xx.x' @ Sta. xx to xx.x' @ Sta.
- [3] Width varies from xx.x' @ Sta. xx to xx.x' @ Sta.
- [4] Width varies from xx.x' @ Sta. xx to xx.x' @ Sta.
- [5] Width varies from xx.x' @ Sta. xx to xx.x' @ Sta.
- [6] Width varies from xx.x' @ Sta. xx to xx.x' @ Sta.
- [7] Slope varies from x @ Sta. xx to x @ Sta.
- [8] Slope varies from x @ Sta. xx to x @ Sta.
- [9] Width varies from xx.x' @ Sta. xx to xx.x' @ Sta.
- [10] Width and slope varies, See Intersection Details, Sheet No.
- [11] See Superelevation Diagram for Slope and Transitions, Sheet No.


NOT FOR CONSTRUCTION

DESIGNED: BMA DRAWN: CNC
CHECKED: KAM CHECKED: BMA

INDIANA
DEPARTMENT OF TRANSPORTATION

TYPICAL CROSS SECTIONS
LINE "B" / "S-1,2,3,-B" / "C" / "P"

HORIZONTAL SCALE	BRIDGE FILE
1" = 5'	ALLEN 358
VERTICAL SCALE	DESIGNATION
1" = 5'	1902834
SURVEY BOOK	SHEETS
---	3 of 63
CONTRACT	PROJECT
B-42844	1902834

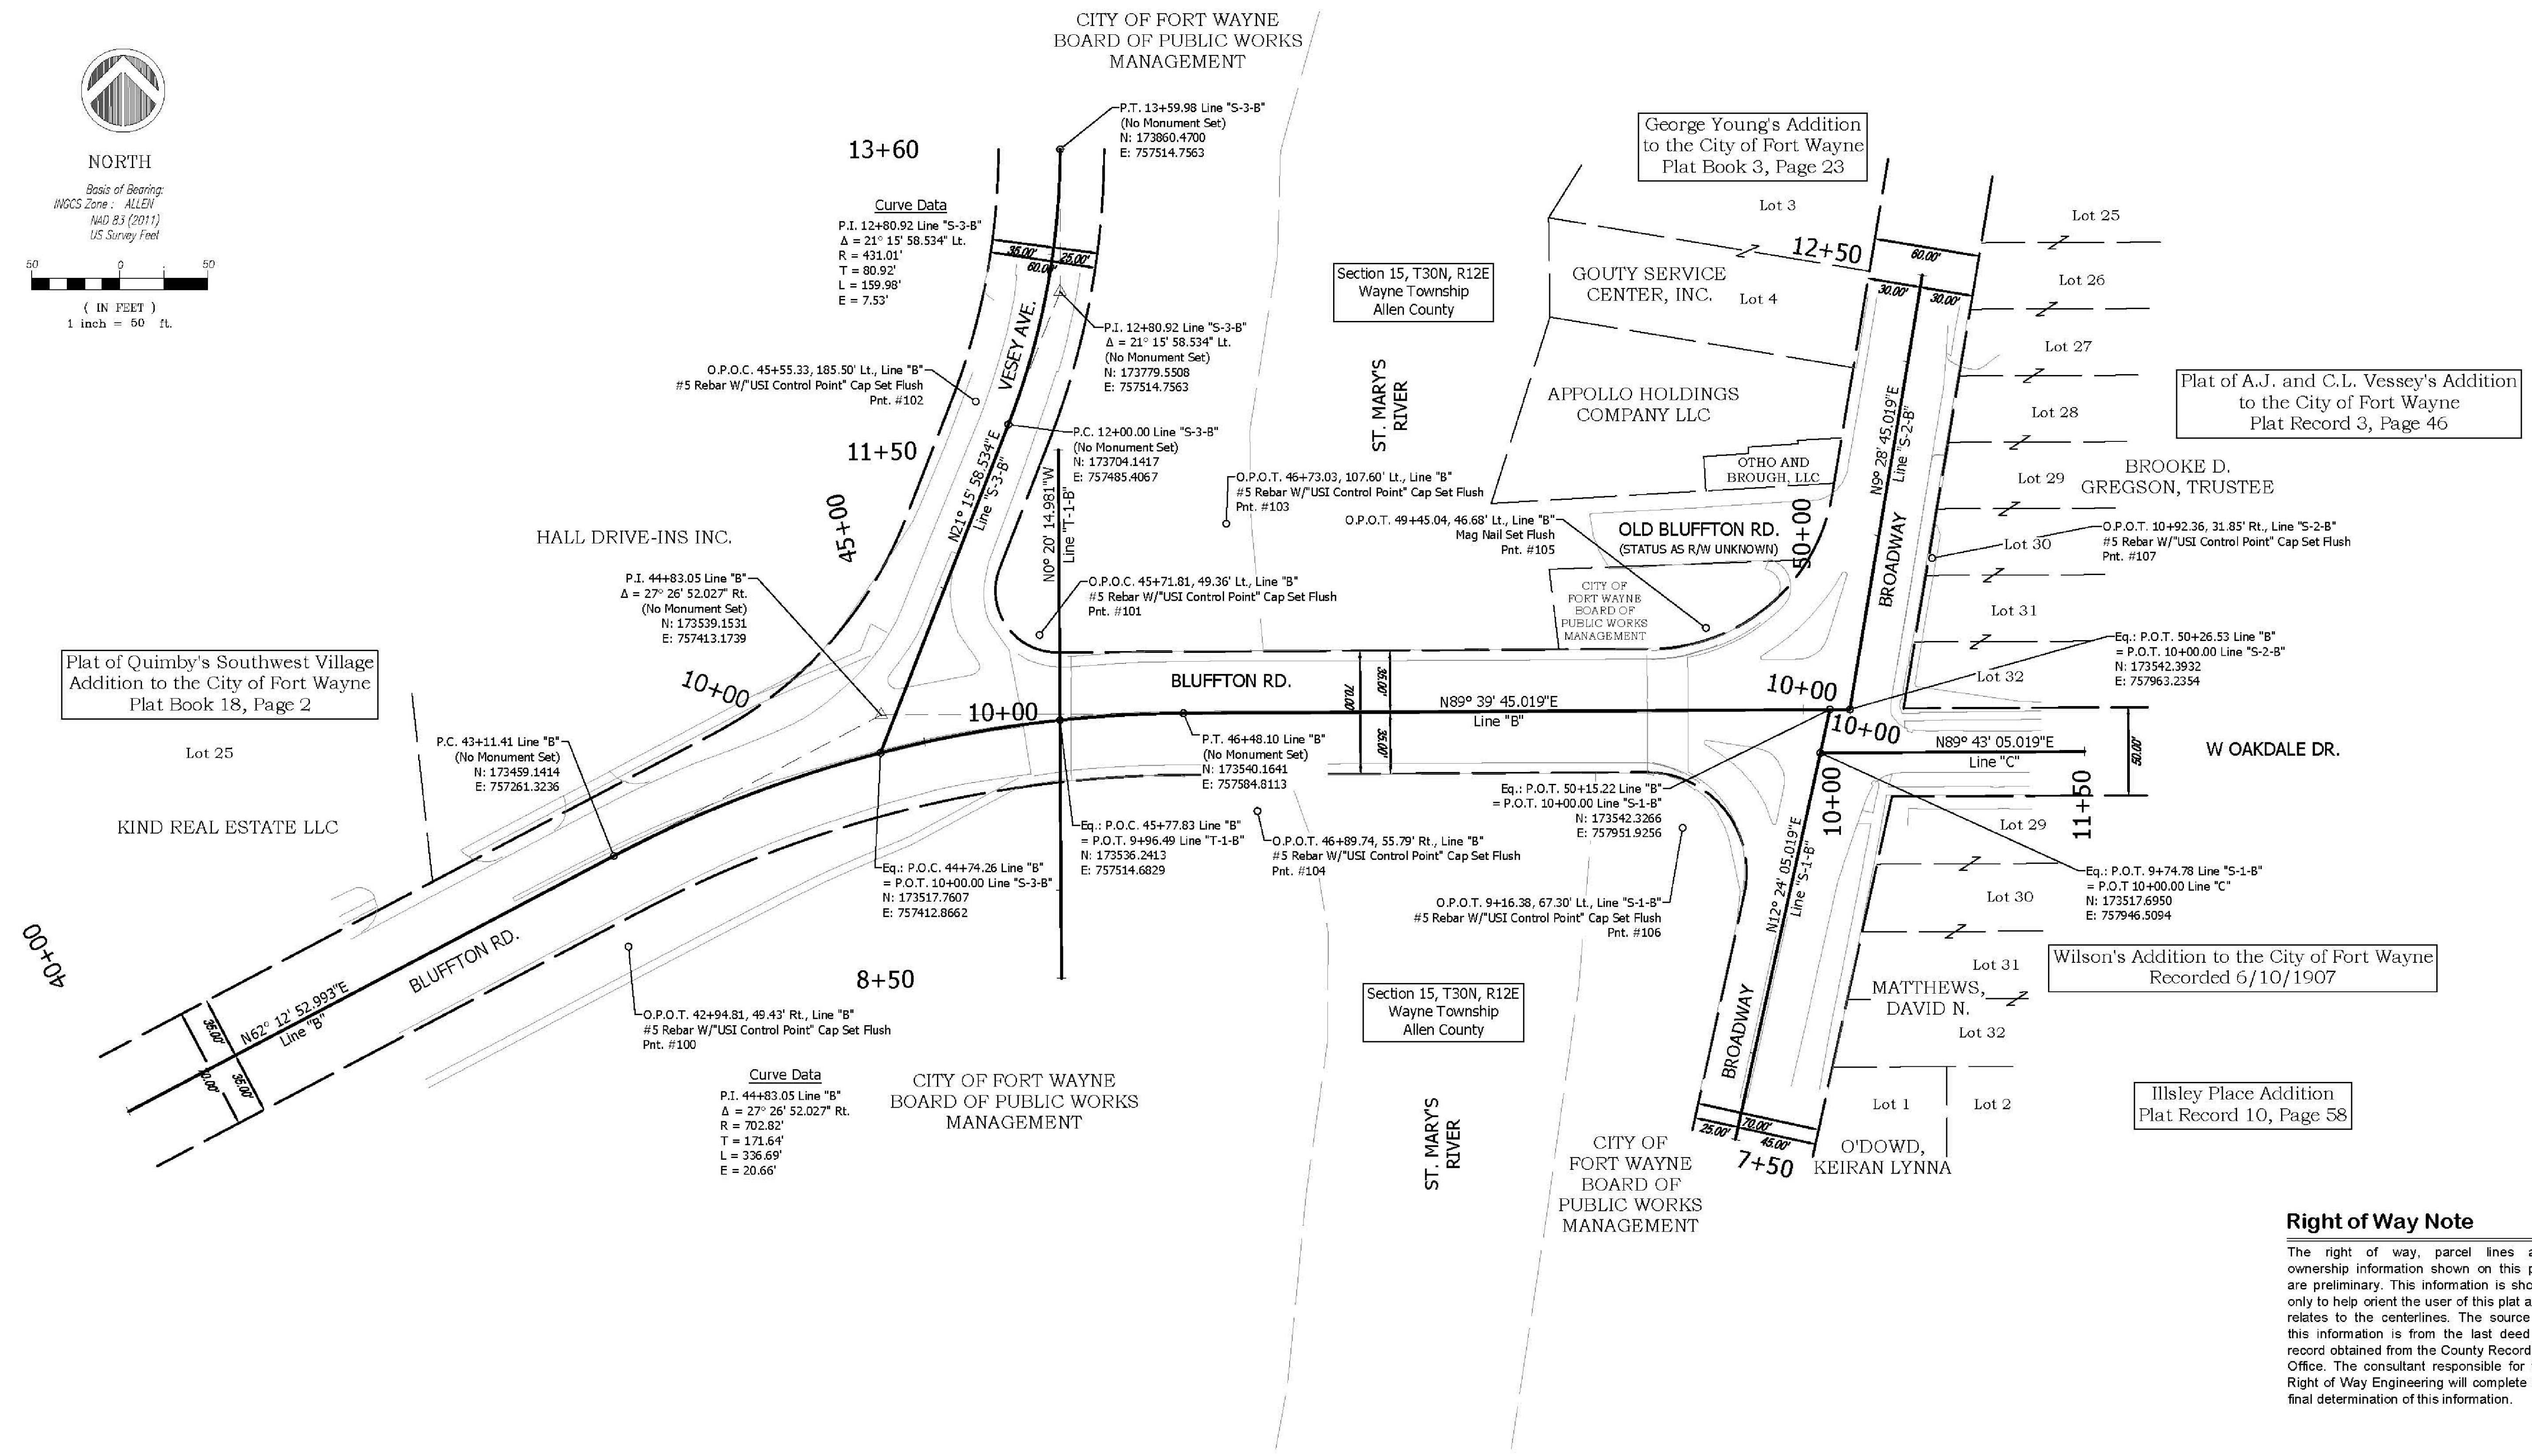

Right of Way Note
 The right of way, parcel lines and ownership information shown on this plat are preliminary. This information is shown only to help orient the user of this plat as it relates to the centerlines. The source of this information is from the last deed of record obtained from the County Recorder's Office. The consultant responsible for the Right of Way Engineering will complete the final determination of this information.

SURVEY STARTED		2021042002 RECORDED: 06/24/2021 02:26:52 PM ANITA MATHER ALLEN COUNTY RECORDER FORT WAYNE, IN	SURVEYOR STATEMENT			AFFIRMATION STATEMENT			HORIZONTAL SCALE		BRIDGE FILE	
01/29/2021			This survey, to the best of my knowledge and belief, is executed according to the provisions of Title 865 IAC 1-12-20 through 1-12-26 regarding Route Surveys, except that any data shown regarding the location or description of the existing parcels is not a part of this survey.			I affirm, under the penalties for perjury, that I have taken reasonable care to redact each Social Security number in this document, unless required by law. By: Mark A. Schepers			1" = 50'		ALLEN 358	
SURVEY COMPLETED						RECOMMENDED FOR APPROVAL AND PREPARED BY:			COUNTY		DESIGNATION	
03/29/2021						SIGNATURE: <i>Mark A. Schepers</i> DATE: 06/18/2021			ALLEN		1902834	
ROUTE PLAT SHEETS						INDIANAPOLIS, IN 46216		SURVEY BOOK		PLAN SHEETS		
1 OF 2						PH. 317.544.4996		4		OF 63		
						FAX 317.544.4997		CONTRACT		PROJECT		
								B-42844		1902834		


USI #2019-0009

BLUFFTON ROAD OVER SAINT MARY'S RIVER
 BRIDGE REPLACEMENT

LOCATION CONTROL ROUTE SURVEY

S:\2019\Proj\2019-0009 Fort Wayne Br 358\Plans\Bridge Plans\2019-0009 Location Control Route Survey.dwg, 3/14/2022 7:27:31 AM, PDF-36x24.pc3

Control Point References

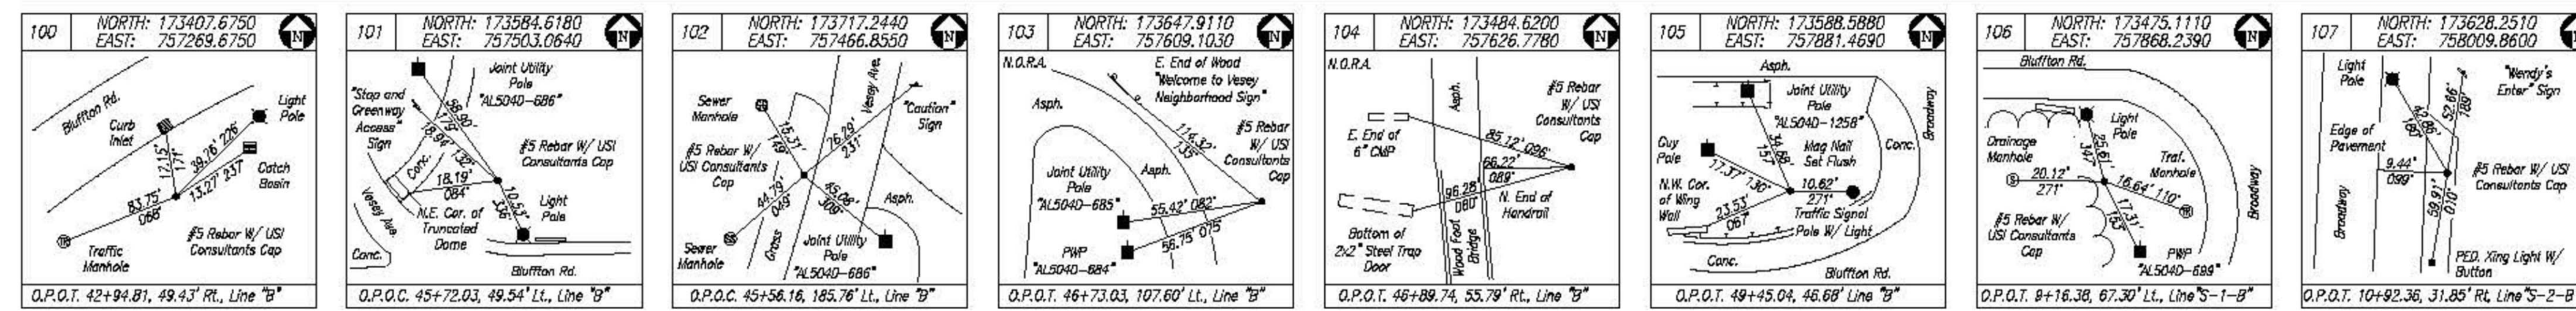

Point Data Table

Point #	Station	Type	INGCS Northing	INGCS Easting	Latitude	Longitude
100	O.P.O.T. 42+94.81, 49.43' RL, Line "B"	#5 Rebar W/ USI Consultants Cap	173407.8750	757289.6750	41°03'08.1747"	-85°09'30.2518"
101	O.P.O.C. 45+72.03, 48.54' LL, Line "B"	#5 Rebar W/ USI Consultants Cap	173594.6180	757503.0640	41°03'07.9258"	-85°09'30.2086"
102	O.P.O.C. 45+58.16, 185.76' LL, Line "B"	#5 Rebar W/ USI Consultants Cap	173717.2440	767488.8550	41°03'08.2857"	-85°09'30.8833"
103	O.P.O.T. 46+73.03, 107.80' LL, Line "B"	#5 Rebar W/ USI Consultants Cap	173847.9110	757602.1030	41°03'08.5024"	-85°09'28.8259"
104	O.P.O.T. 46+89.74, 55.79' RL, Line "B"	#5 Rebar W/ USI Consultants Cap	173494.6200	757626.7780	41°03'08.9383"	-85°09'28.5823"
105	O.P.O.T. 49+45.04, 49.88' Line "B"	Mag Nail Set Flush	173688.5880	757881.4690	41°03'07.9688"	-85°09'25.2898"
106	O.P.O.T. 8+16.38, 67.30' LL, Line "S-1-B"	#5 Rebar W/ USI Consultants Cap	173475.1110	757868.2390	41°03'08.0483"	-85°09'25.4407"
107	O.P.O.T. 10+82.36, 31.85' RL, Line "S-2-B"	#5 Rebar W/ USI Consultants Cap	173628.2510	768006.0600	41°03'08.3630"	-85°09'23.6947"

Vicinity Map (N.T.S.)



Surveyor's Report

Located in Section 15, Township 30 North, Range 12 East, in Wayne Township, in Allen County.

The purpose of this survey is to collect data for the preparation of construction and right of way plans. This is not a property retracement survey. Any apparent property, subdivision, or easement lines or corners are based on the last deeds of record obtained from the County Recorder's Office. These lines in no way represent property, subdivision, or easement lines that could be determined from a retracement property survey. They are preliminary and should not be used to represent a retracement property survey. No monuments were set to represent the same. In addition, any monuments depicted on this plat indicated as being found or set should be used only for the above stated purpose.

Field measurements for this survey were in accordance with the specifications outlined in IAC 865-1-14. Measurements are shown to the nearest 0.01 feet, coordinates to the nearest 0.0001 feet, and the bearings to the 0.001 seconds, not to indicate the precision of the work, but to allow for closure and adjustment by others if desired. Units are US Survey Feet unless otherwise noted.

Horizontal Control

The horizontal control for this project is based on the Indiana Geospatial Coordinate System (INGCS), Allen Zone, North American Datum of 1983 (2011) EPOCH 2010.0, US Survey Feet. Said system was ascertained by Real Time Kinematic (RTK) GPS observations from Trimble's VRS NOW Continuously Operating Reference System (www.vrsnow.us). This system will govern the project for design, right of way computations and layout. Geometric datum and map projection parameters for this INGCS Zone are as follows:

Coordinate System : Indiana Geospatial Coordinate System
 Zone : Allen
 Datum : NAD 83 (2011) EPOCH 2010.0
 Ellipsoid Name : GRS 80
 Geoid Model : Geoid18

Zone Parameters
 Latitude of Grid Origin : 40°54'00"N
 Longitude of Grid Origin : 85°03'00"W
 Central Meridian S.F. : 1.000031
 False northing offset : 118110
 False easting offset : 787400

The Trimble VRS NOW's RTK Systems continuously operating reference stations (CORS) were used to measure dual RTK vectors on all control points and section corners. These dual vectors were compared and adjusted using Trimble Business Center software.

Reference Monumentation:

Control Points - See references and Point Data Table - Estimated relative positional accuracy of these points due to random errors in the measurement or staking of these monuments is +/- 0.10 feet.

Section Corners - No section corner ties were found at the Allen County Surveyor's Office, no relevant section corner monuments were found as part of this survey.

Alignments:

The following Alignments were taken from plan reference 1 below, and were established based on location of bridge piers:

- Line "B" from Sta. 46+48.10 onwards
- Line "T-1-B"
- Line "S-1-B"
- Line "S-2-B"
- Line "C"

The following Alignments were placed based on field locations of existing conditions and Aerial photography:

- Line "B" from Station 40+00 to Station 46+48.10 and Line "S-3-B"

Reference Plan:

- 1) "Bridge Plans for Spans over 20 Feet on Bluffton Road, over St. Mary's River, Allen County, Indiana" Project Number BRM-F080 dated 8/14/1985.

Reference Plats:

- 1) Wilson's Addition to the City of Fort Wayne, Recorded in Allen County Recorder's Office on 06/10/1907.
- 2) Plat of A.J. and C.L. Vessey's Addition to the City of Fort Wayne, on file in Allen County Recorder's Office as Plat Record 3, Page 46.
- 3) George Young's Addition to the City of Fort Wayne, on file in Allen County Recorder's Office in Plat Book 3, Page 23.
- 4) Plat of Quimby's Southwest Village Addition to the City of Fort Wayne on file in Allen County Recorder's Office in Plat Record 18, Page 2.
- 5) Relocation of Vesey Ave. Recorded in Allen County Recorder's Office as Plat Record 18, Page 28.

Right of Way:

No Right of Way grants were discovered, and no Right of Way was shown or referenced on Plan Reference 1. Plats 1-4 did not show Right of Way, with the exception of W Oakdale Dr. (F. K.A. Dayton Ave). Oakdale Drive is shown as 50' R/W per plat, and R/W width for Vesey, Broadway and Bluffton Road are shown per the City of Fort Wayne Street Engineering GIS.

Plat Record 5 shows a relocation of Vesey Avenue from around 1948, however the Plat does not reflect the current Alignment of Vesey, and therefore was not used in the preparation of this plat. The status of "Old Bluffton Road" is not known.

The right of way, parcel lines and ownership information shown on this plat are preliminary. This information is shown only to help orient the user of this plat as it relates to the centerlines. The source of this information is from the last deed of record obtained from the County Recorder's Office as well as the above-mentioned plans. The consultant responsible for the Right of Way Engineering will complete the final determination of this information.

SURVEY STARTED		01/29/2021	
SURVEY COMPLETED		03/29/2021	
ROUTE PLAT SHEETS		2	CF 2

2021042002
 RECORDED: 06/24/2021 02:26:52 PM
 ANITA MATHER
 ALLEN COUNTY RECORDER
 FORT WAYNE, IN

SURVEYOR STATEMENT

This survey, to the best of my knowledge and belief, is executed according to the provisions of Title 865 IAC 1-12-20 through 1-12-26 regarding Route Surveys, except that any data shown regarding the location or description of the existing parcels is not a part of this survey.



AFFIRMATION STATEMENT

I affirm, under the penalties for perjury, that I have taken reasonable care to redact each Social Security number in this document, unless required by law. By: Mark A. Schepers

RECOMMENDED FOR APPROVAL AND PREPARED BY:

SIGNATURE: *Mark A. Schepers* 06/18/2021
 DATE: MARK A. SCHEPERS, PS




8415 East 56th St.
 Indianapolis, IN 46216
 PH. 317.544.4996
 FAX 317.544.4997

BLUFFTON ROAD OVER SAINT MARY'S RIVER
 BRIDGE REPLACEMENT

LOCATION CONTROL ROUTE SURVEY


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COUNTRY		DESIGNATION	
ALLEN		1902834	
SURVEY BOOK		PLAN SHEETS	
		5	OF 63
CONTRACT		PROJECT	
B-42844		1902834	

USI #2019-0009

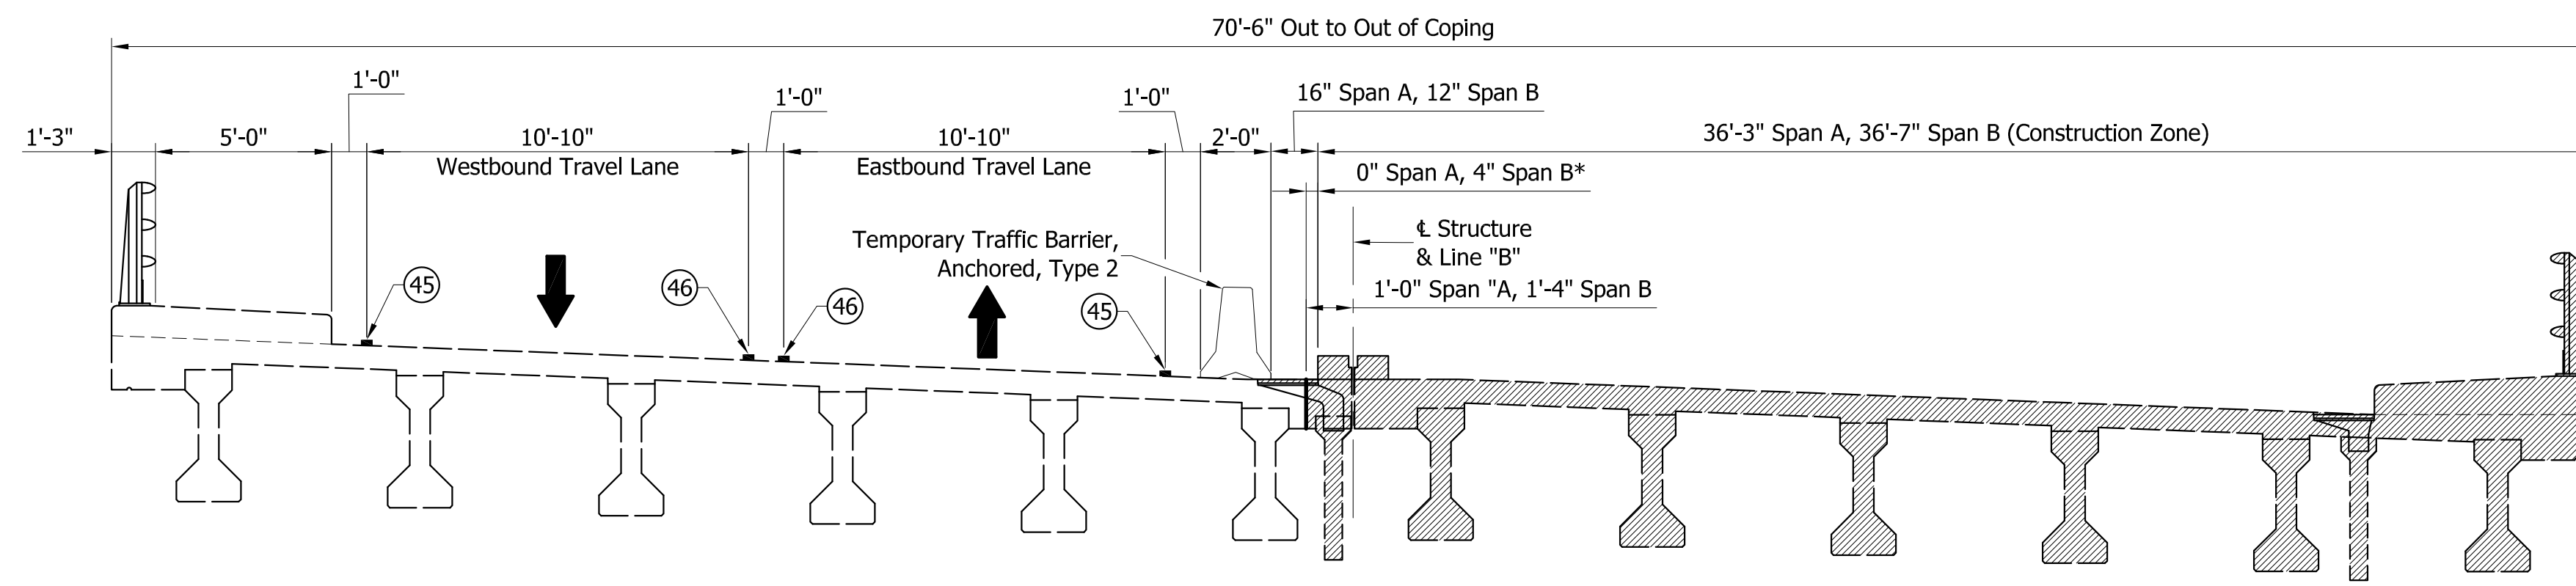

**PHASE I - MAINTENANCE OF TRAFFIC
SUPERELEVATED SPANS "A" and "B"**

Scale: 1/4"=1'-0"

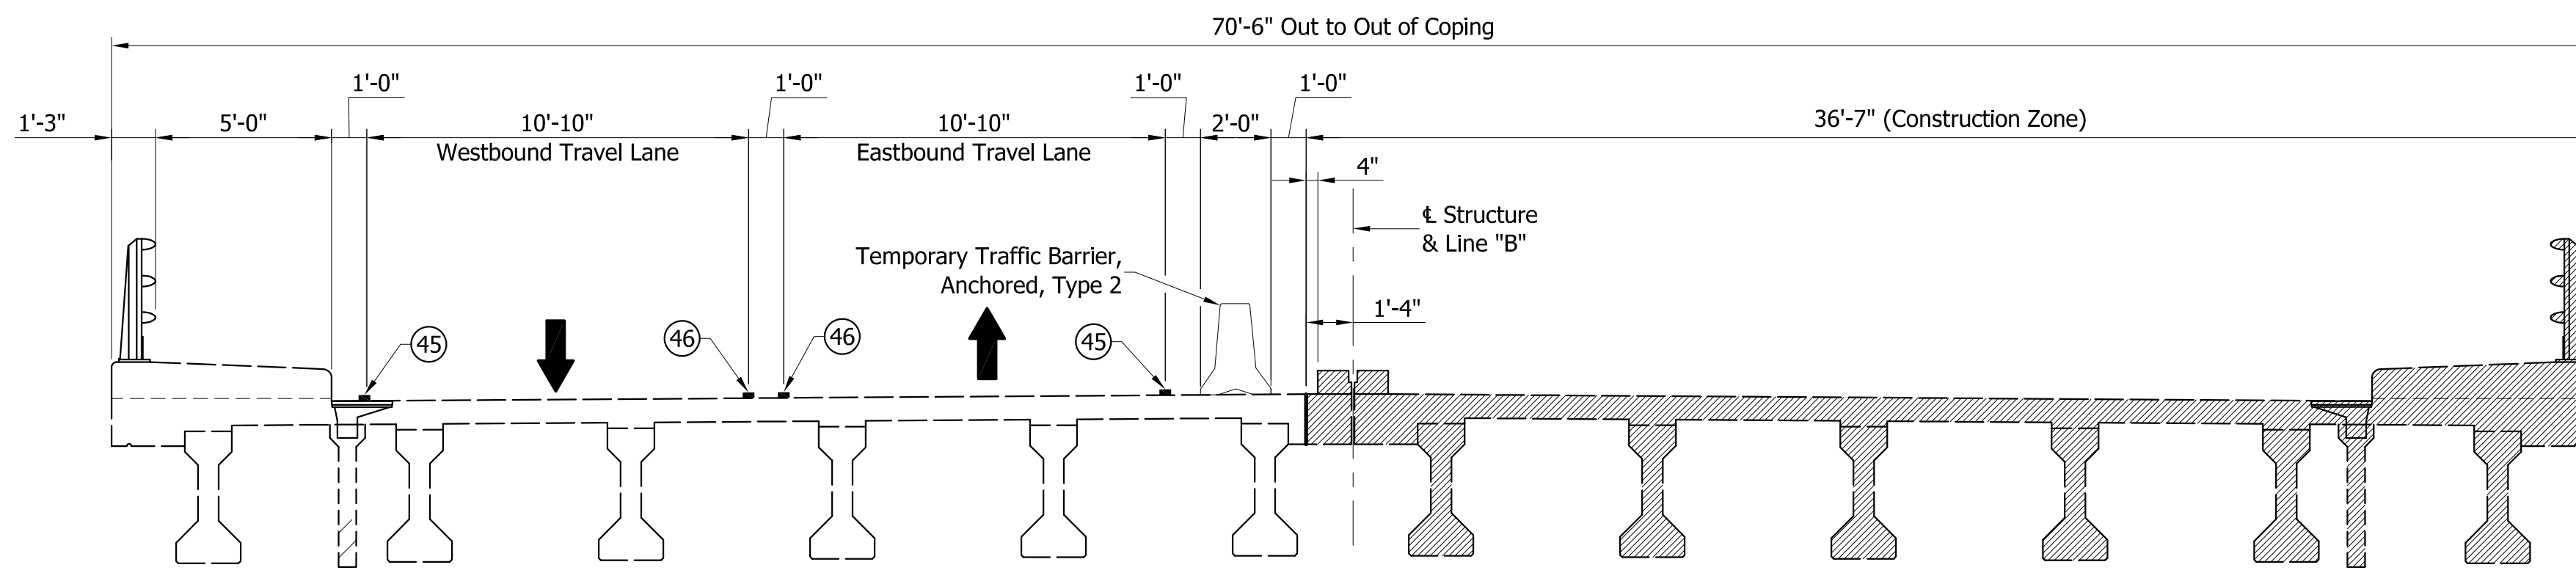

**PHASE I - MAINTENANCE OF TRAFFIC
CROWNED SPANS "C", "D" & "E"**

Scale: 1/4"=1'-0"

PHASE 1 CONSTRUCTION SEQUENCE

1. Place temporary pavement markings as shown on plans for Phase I utilizing flaggers as necessary. Existing pavement markings that conflict with Maintenance of traffic scheme shall be removed. See INDOT Std. Dwg. E 801-TCFO-02 for additional flagging operation information.
2. Move and bag signal heads at the intersection of Bluffton Road and Broadway to match traffic scheme.
3. Bag or remove existing aerial signs for eastbound traffic on Bluffton Road. Bag or remove existing aerial signs at the intersection of Bluffton Road and Broadway to match new Maintenance of traffic scheme.
4. Place temporary traffic barrier as shown on plans, using westbound lanes for eastbound and westbound traffic. Commence Phase I Construction.
5. For additional Traffic Control General Notes see INDOT Std. Dwg. E 801-TCLG-01.
6. For plan layout see Sheet No. 7.
7. For temporary anchored barrier details, see INDOT Std. Dwg. E 801-TCCB-05 and E 801-TCCB-06.

*Note: Per original plans, Span A the distance from the raised median to the top flange of Beam 6 is approximately 1 inch. Do not cut beam flange during Phase I.

Note to Reviewer:
Signalization Notes and Signal Phase Diagrams will be completed in Stage 3 Plans

CONSTRUCTION ZONE DESIGN SPEED: 35 MPH

LEGEND	(45) Temporary Pavement Marking, Removable, 4", Solid White	TT Type III-A or Type III-B Barricade (as noted on plans)	Temp. Concrete Barrier, Anchored, Type 2
	(46) Temporary Pavement Marking, Removable, 4", Solid Yellow	TT Construction Sign (A, B, or C)	Temp. Concrete Barrier, Type 2 (as noted on plans)
	(47) Temporary Transverse Pavement Marking, Removable, 24", Solid White	● Standard Drum	Temporary Energy Absorbing Terminal, CZ, TL-2
	(48) Temporary Pavement Marking, Removable, 4", Dashed White	Phase Construction	Dynamic Message Sign
✕✕ Lane Line Removal	⇒ Indicates Traffic Flow	MS	Flashing Arrow Board



NOT FOR CONSTRUCTION

DESIGNED: BMA	DRAWN: BDC
CHECKED: KAM	CHECKED: BMA

**INDIANA
DEPARTMENT OF TRANSPORTATION**


**MAINTENANCE OF TRAFFIC
PHASE I**

HORIZONTAL SCALE AS NOTED	BRIDGE FILE ALLEN 358
VERTICAL SCALE AS NOTED	DESIGNATION 1902834
SURVEY BOOK ---	SHEETS 6 of 63
CONTRACT B-42844	PROJECT 1902834

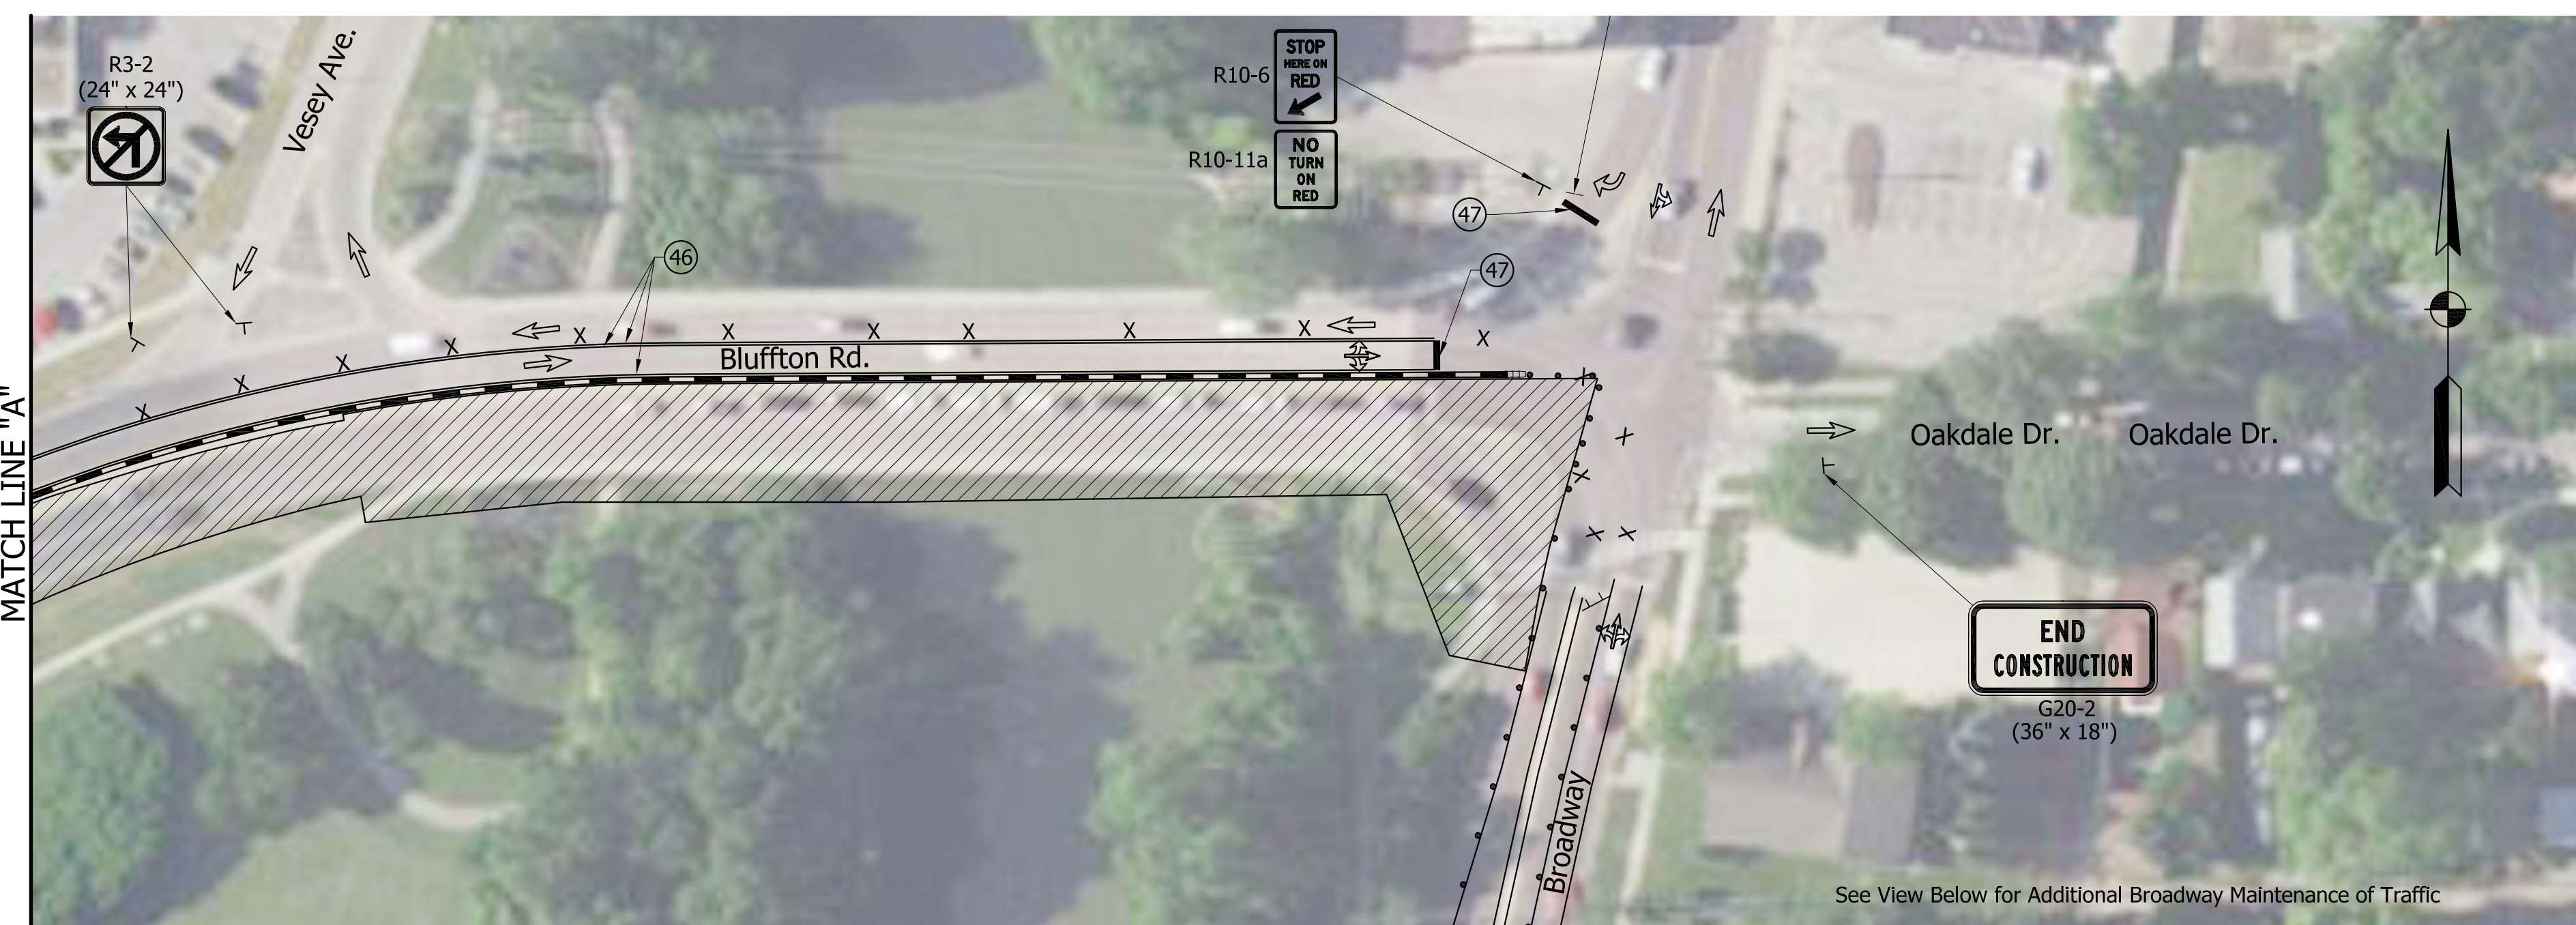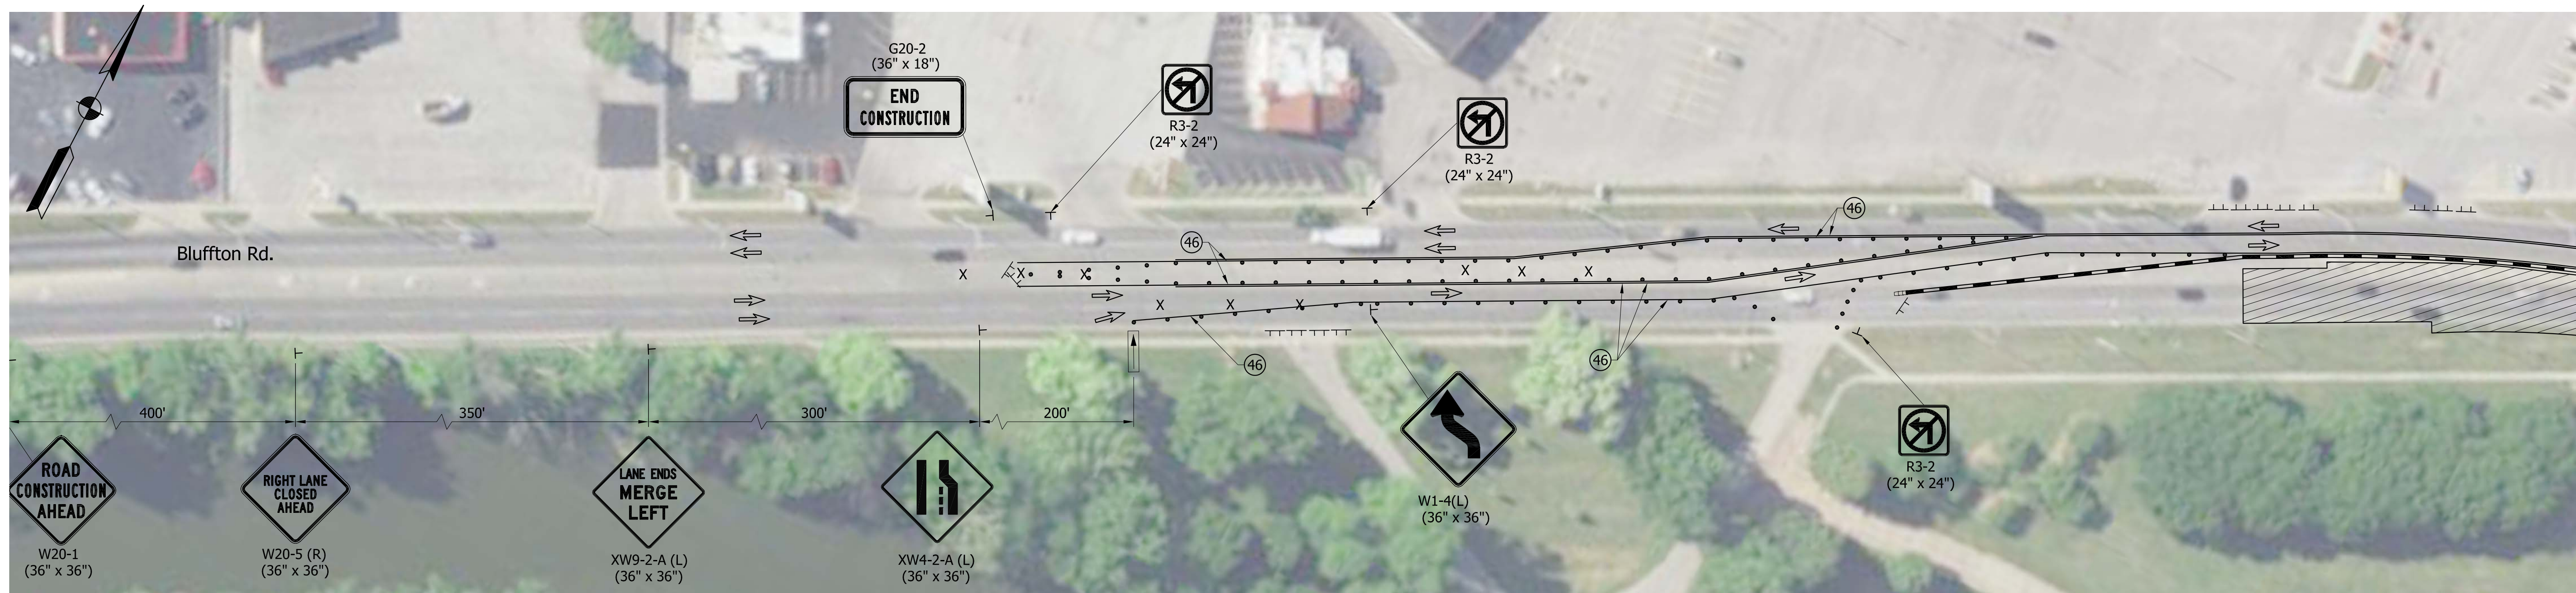

- NOTES:**
1. Access to all drives to be maintained during all phases of construction.
 2. Existing conflicting pavement markings to be removed within project limits.
 3. For Phase I Construction sequence see Sheet No. 6.
 4. Additional signing details and additional Phase I information see Sheet No. 6.
 5. Use in conjunction with Pedestrian Detour Sheet No. 13, and Kayaker Detour Sheet No. 14.
 6. Barrels, etc. in Broadway intersection to be positioned as shown during milling and resurfacing operations. They shall be pulled back to the CZ, TL-2 otherwise to allow for truck turning movements in intersection.

CONSTRUCTION ZONE DESIGN SPEED: 35 MPH

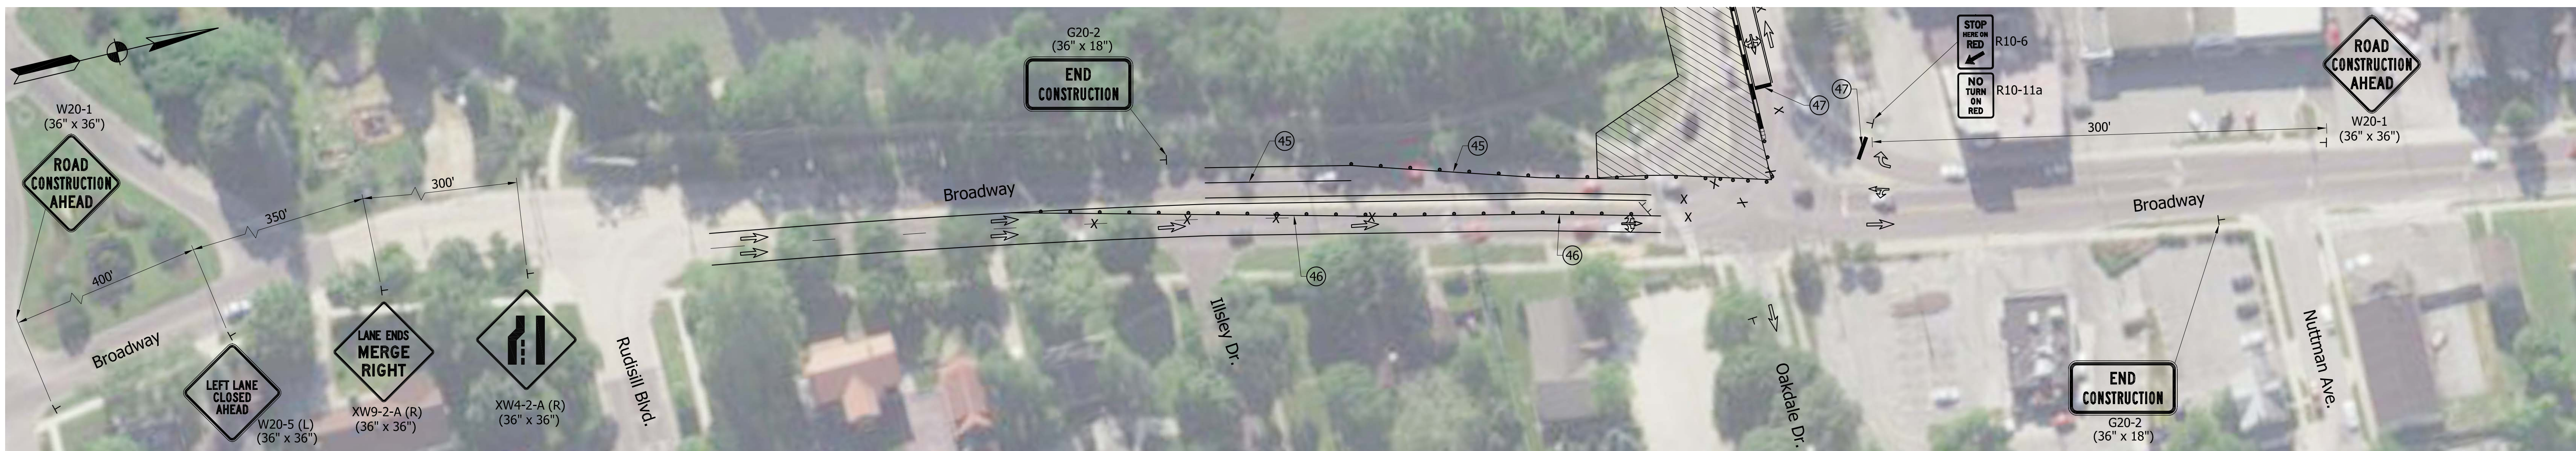

LEGEND	(45)	Temporary Pavement Marking, Removable, 4", Solid White	TT	Type III-A or Type III-B Barricade (as noted on plans)	—	Temp. Concrete Barrier, Anchored, Type 2
	(46)	Temporary Pavement Marking, Removable, 4", Solid Yellow	TT	Construction Sign (A, B, or C)	—	Temp. Concrete Barrier, Type 2 (as noted on plans)
	(47)	Temporary Transverse Pavement Marking, Removable, 24", Solid White	●	Standard Drum	—	Temporary Energy Absorbing Terminal, CZ, TL-2
	(48)	Temporary Pavement Marking, Removable, 4", Dashed White	▨	Phase Construction	MS	Dynamic Message Sign
— X —	Lane Line Removal	⇒	Indicates Traffic Flow	↔	Flashing Arrow Board	

NOT FOR CONSTRUCTION

DESIGNED: BMA	DRAWN: BDC
CHECKED: KAM	CHECKED: BMA

INDIANA
DEPARTMENT OF TRANSPORTATION


MAINTENANCE OF TRAFFIC
PHASE I

HORIZONTAL SCALE	BRIDGE FILE
1" = 50'	ALLEN 358
VERTICAL SCALE	DESIGNATION
N/A	1902834
SURVEY BOOK	SHEETS
---	7 of 63
CONTRACT	PROJECT
B-42844	1902834

PHASE II CONSTRUCTION SEQUENCE


1. Place temporary pavement markings as shown on plans for Phase II utilizing flaggers as necessary. Existing pavement markings that conflict with Maintenance of traffic scheme shall be removed. See INDOT Std. Dwg. E 801-TCCO-02 for additional flagging operation information.
2. Move and bag signal heads at the intersection of Bluffton Road and Broadway to match traffic scheme.
3. Bag or remove existing aerial signs for eastbound traffic on Bluffton Road. Bag or remove existing aerial signs at the intersection of Bluffton Road and Broadway to match new Maintenance of traffic scheme.
4. Place temporary traffic barrier as shown on plans, using eastbound lanes for eastbound and westbound traffic. Commence Phase II Construction.
5. For plan layout see Sheet No. 9.
6. For additional Traffic Control General Notes see INDOT Std. Dwg. E 801-TCLG-01.
7. For temporary anchored barrier details, see INDOT Std. Dwg. E 801-TCCB-05 and E 801-TCCB-06.

Note to Reviewer:
Signalization Notes and Signal Phase Diagrams will be completed in Stage 3 Plans

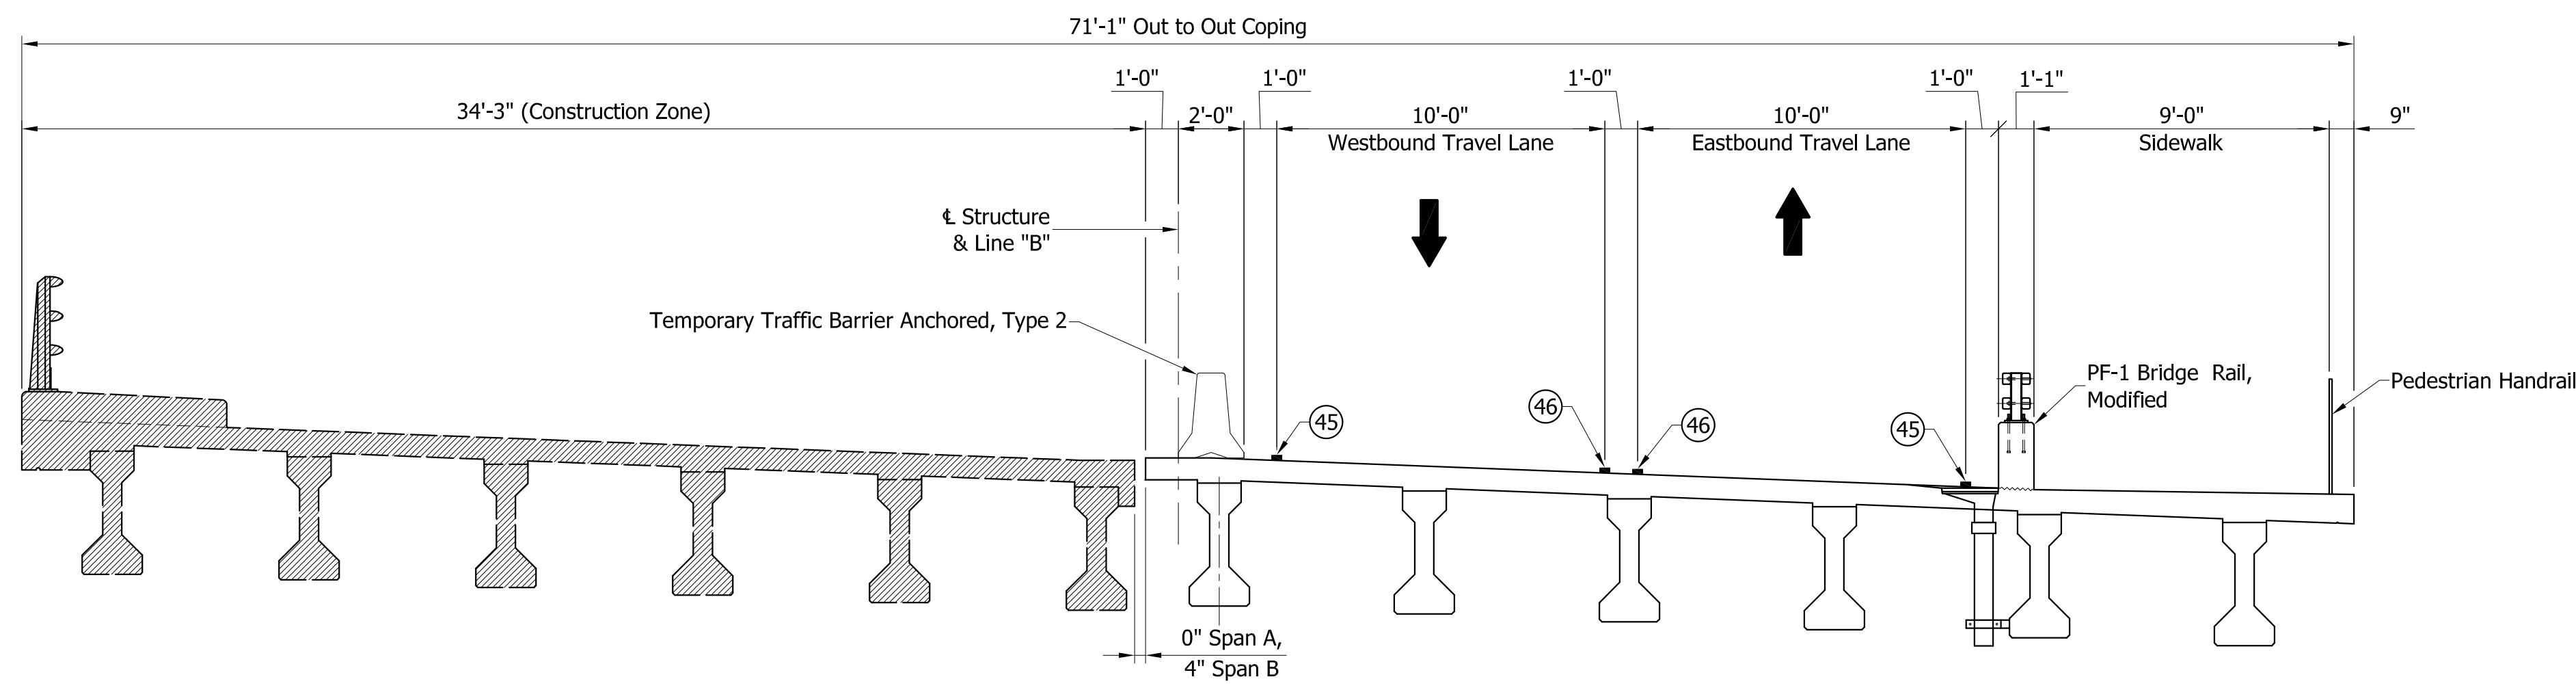

**PHASE II - MAINTENANCE OF TRAFFIC
SUPERELEVATED SPANS "A" and "B"**

Scale: 1/4"=1'-0"

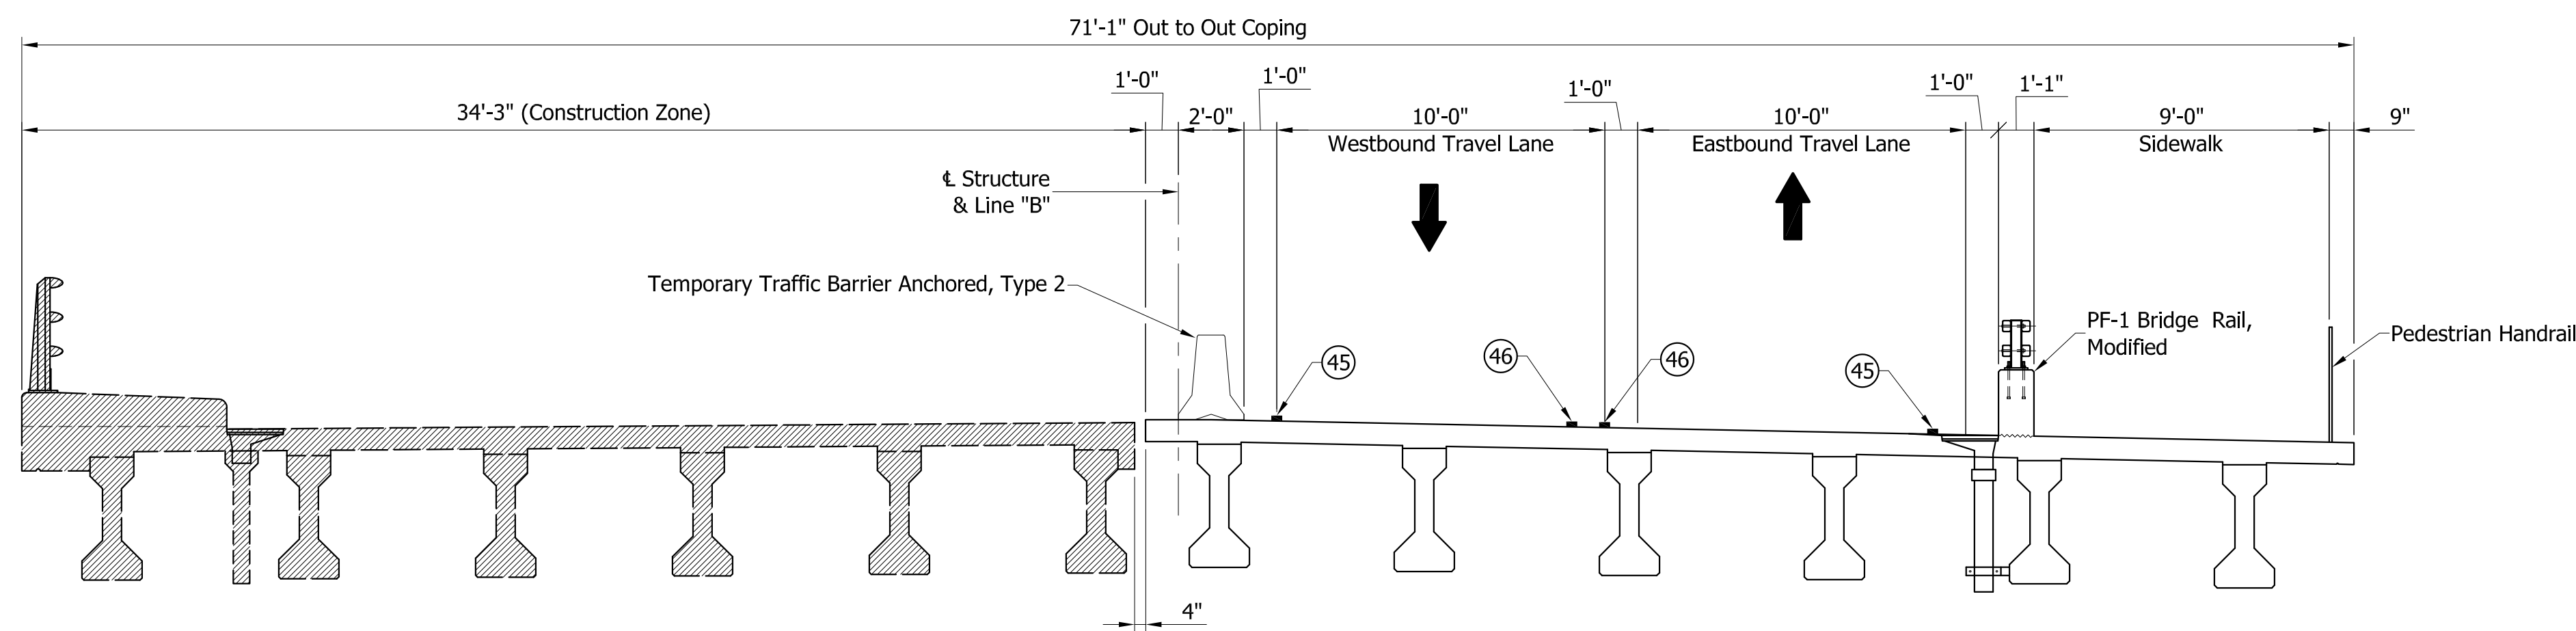

**PHASE II - MAINTENANCE OF TRAFFIC
CROWNED SPANS "C", "D" & "E"**

Scale: 1/4"=1'-0"

CONSTRUCTION ZONE DESIGN SPEED: 35 MPH

LEGEND	(45) Temporary Pavement Marking, Removable, 4", Solid White	TT Type III-A or Type III-B Barricade (as noted on plans)	Temp. Concrete Barrier, Anchored, Type 2
	(46) Temporary Pavement Marking, Removable, 4", Solid Yellow	TT Construction Sign (A, B, or C)	Temp. Concrete Barrier, Type 2 (as noted on plans)
	(47) Temporary Transverse Pavement Marking, Removable, 24", Solid White	● Standard Drum	Temporary Energy Absorbing Terminal, CZ, TL-2
	(48) Temporary Pavement Marking, Removable, 4", Dashed White	Phase Construction	MS Dynamic Message Sign
✕✕ Lane Line Removal	Indicates Traffic Flow	Flashing Arrow Board	




NOT FOR CONSTRUCTION

DESIGNED: BMA	DRAWN: BDC
CHECKED: KAM	CHECKED: BMA

**INDIANA
DEPARTMENT OF TRANSPORTATION**

**MAINTENANCE OF TRAFFIC
PHASE II**

HORIZONTAL SCALE AS NOTED	BRIDGE FILE ALLEN 358
VERTICAL SCALE AS NOTED	DESIGNATION 1902834
SURVEY BOOK ---	SHEETS 8 of 63
CONTRACT B-42844	PROJECT 1902834

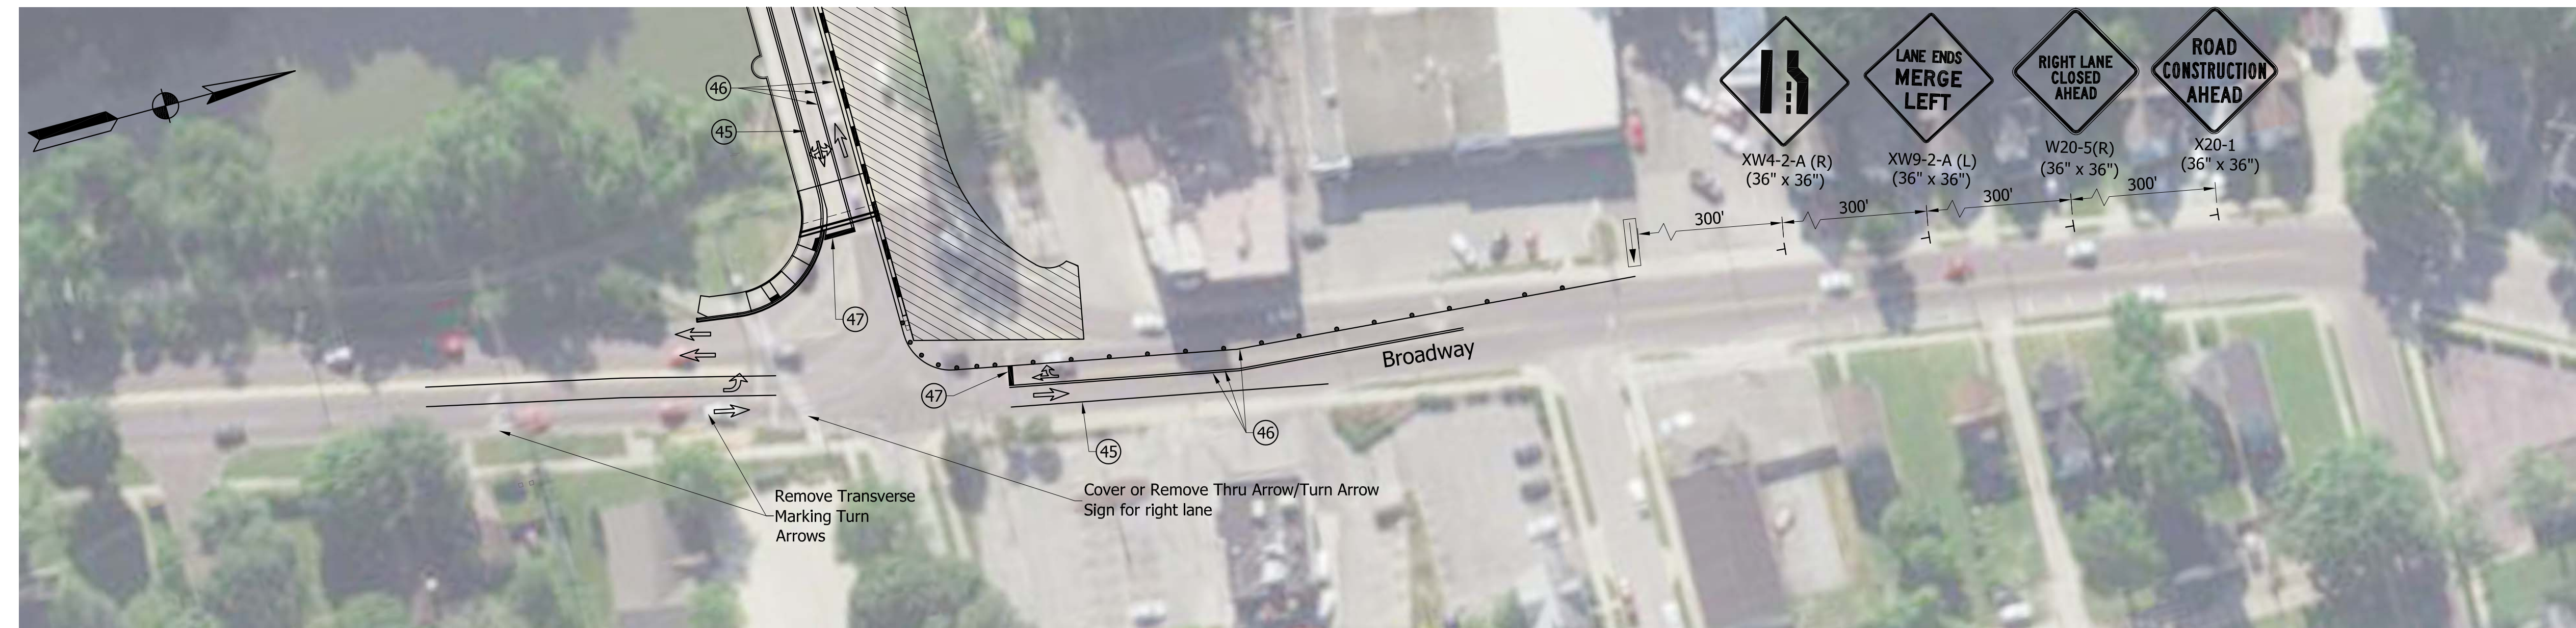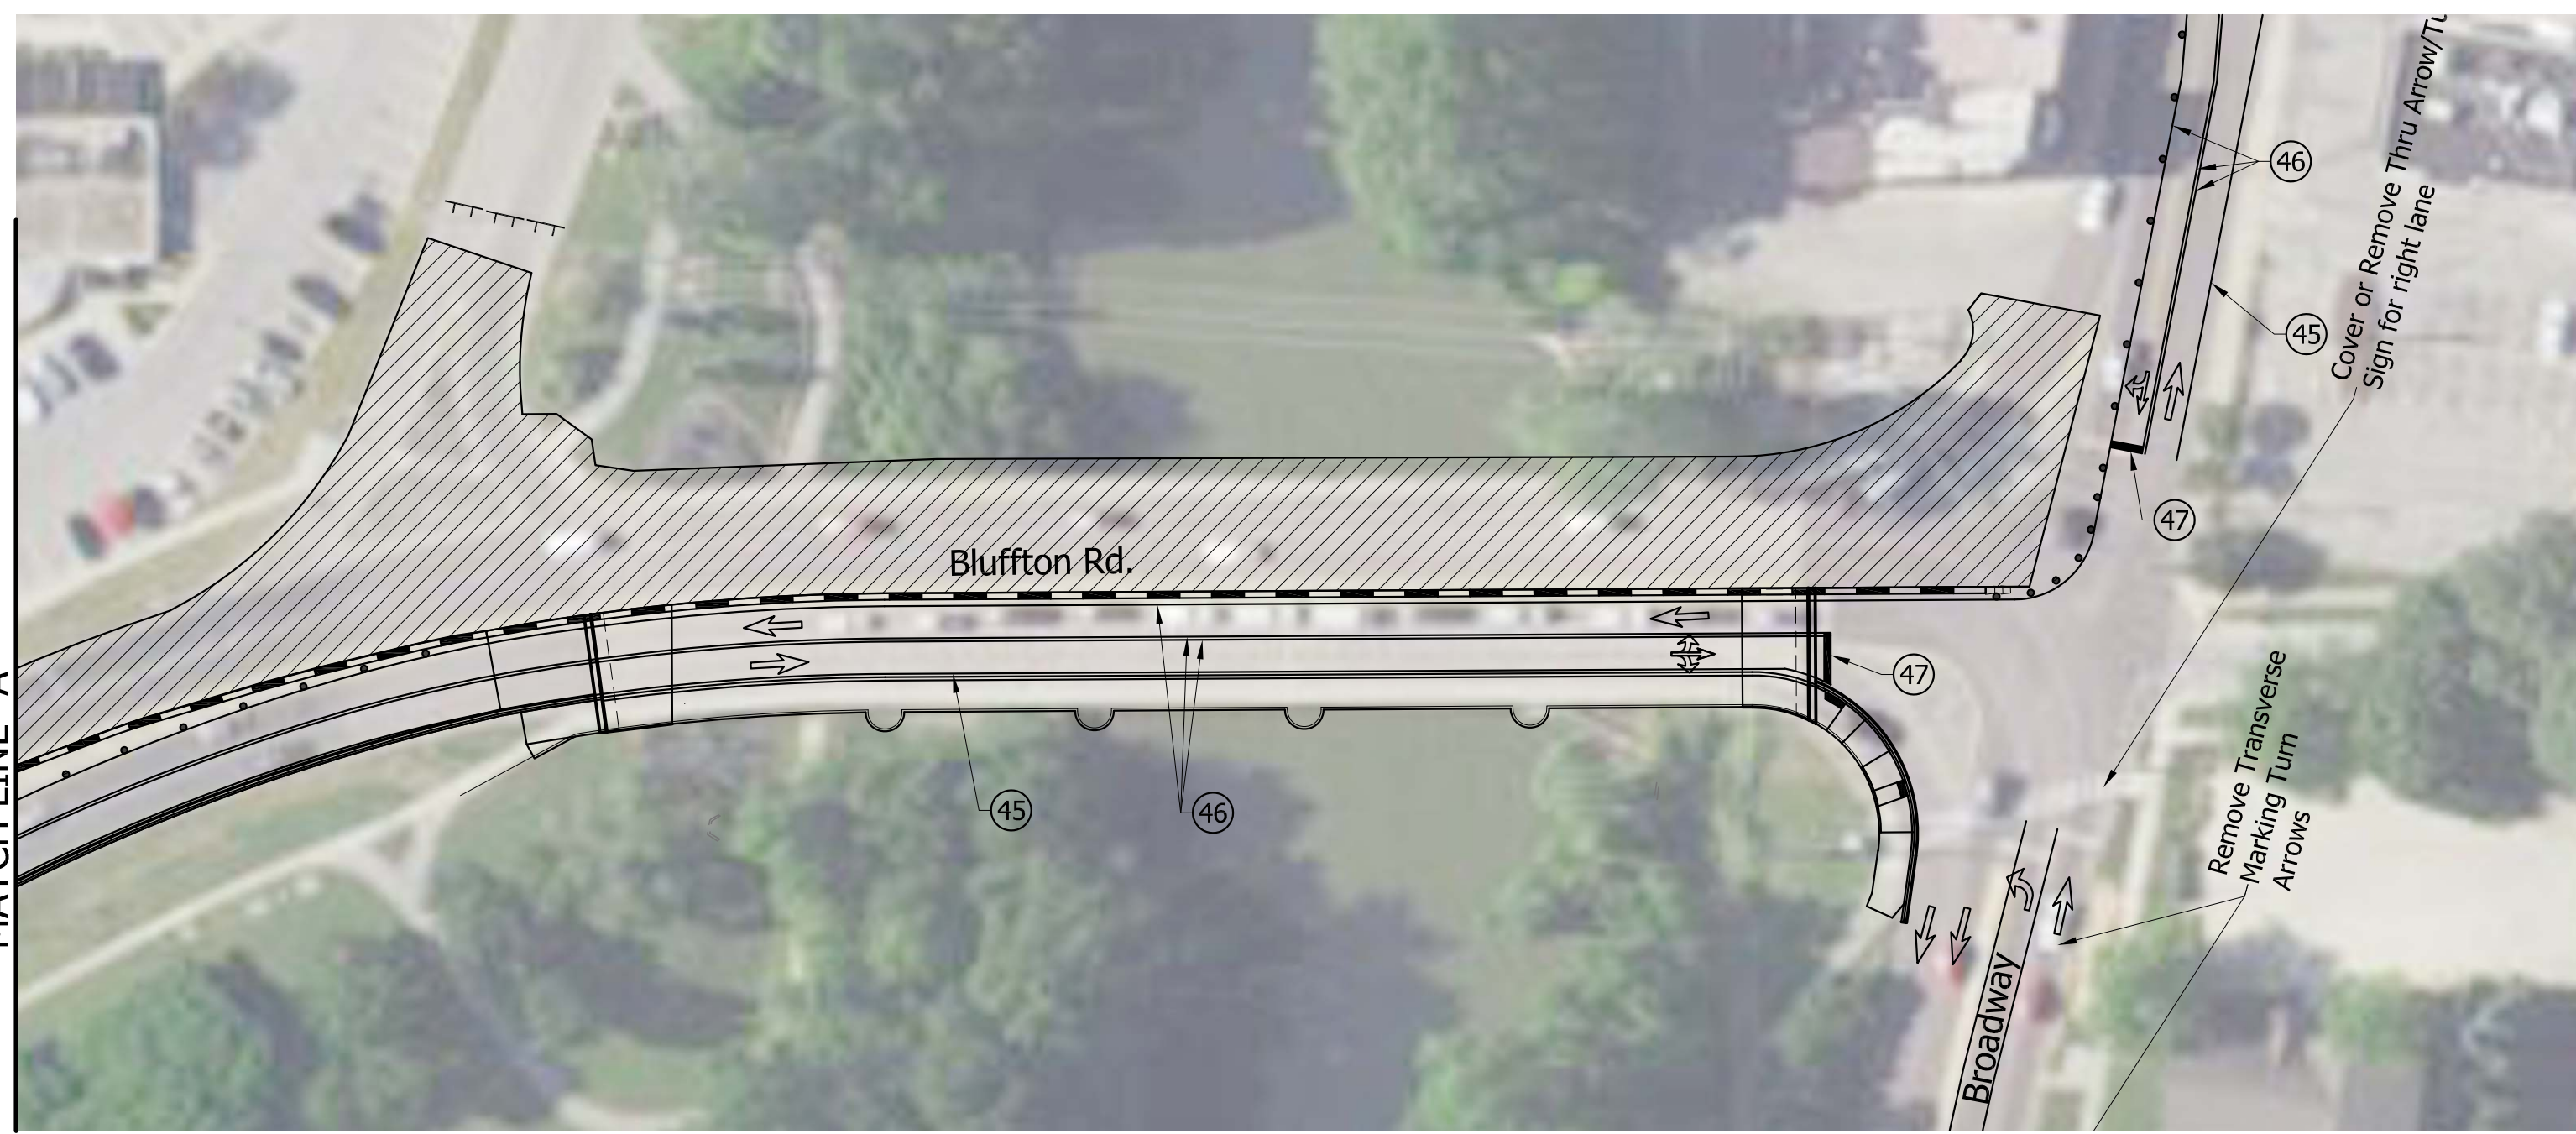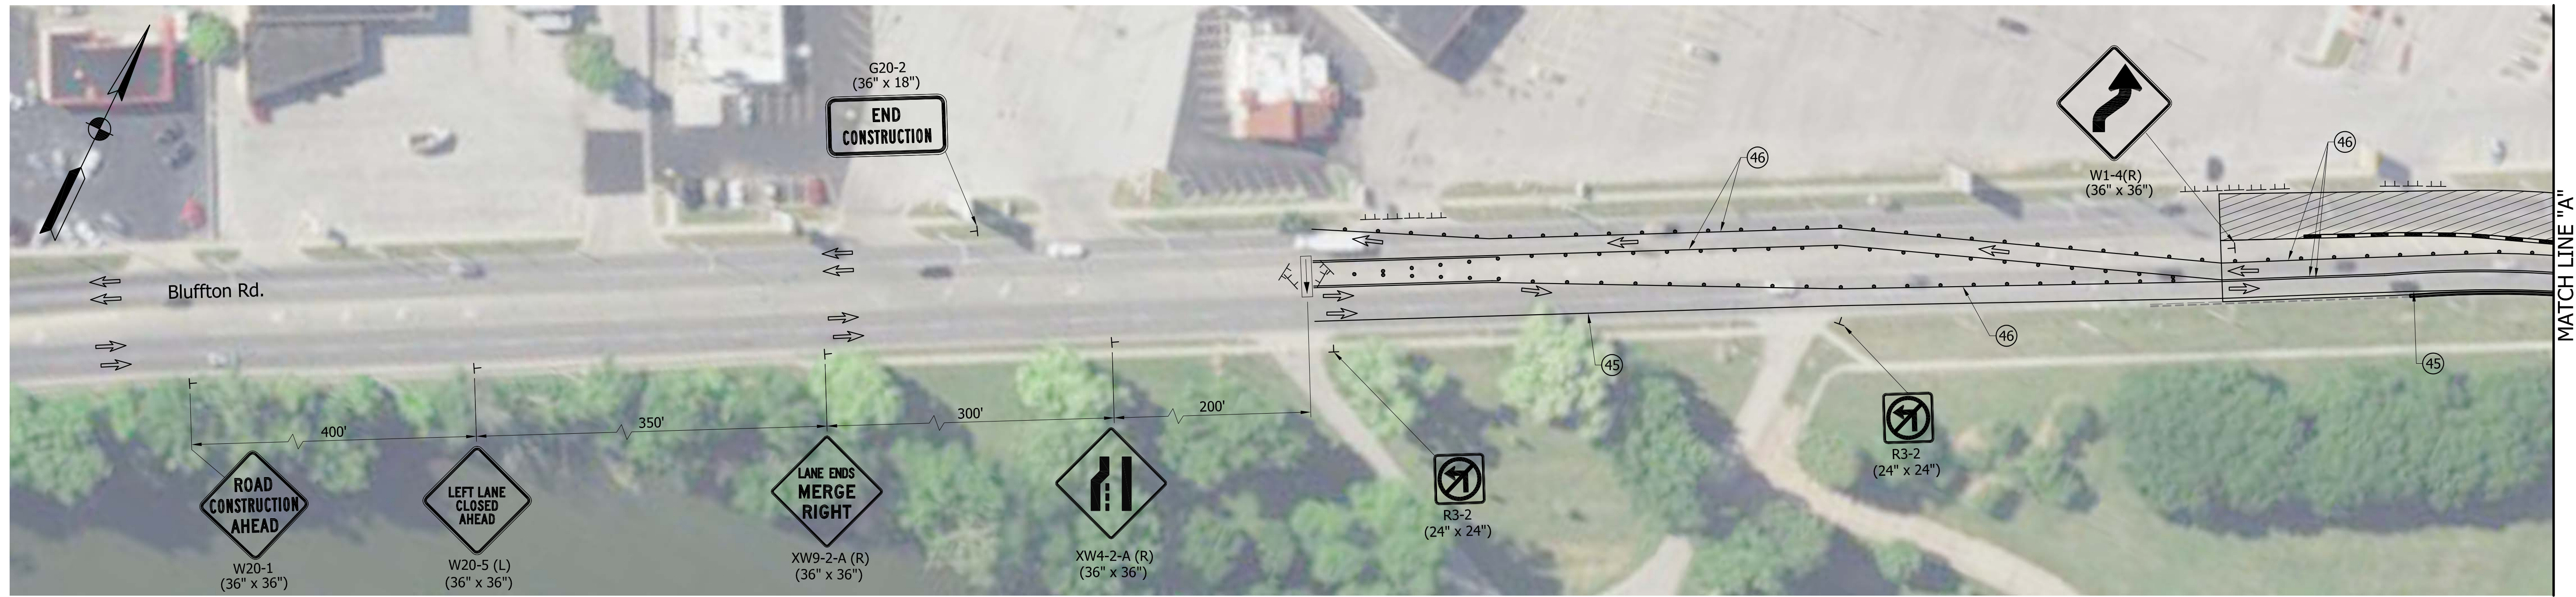

- NOTES:**
1. Access to all drives to be maintained during all phases of construction.
 2. Existing conflicting pavement markings to be removed within project limits.
 3. For Phase II Construction sequence see Sheet No. x.
 4. For additional Traffic Control General Notes see INDOT Std. Dwg. E 801-TCLG-01.
 5. Additional signing details and additional Phase II information see Sheet No. x.
 6. Use in conjunction with Pedestrian Detour Sheet No. x, Kayaker Detour Sheet No. x, and Bluffton Road and Vessey Ave Detour and Truck Route see Sheet No. x.

CONSTRUCTION ZONE DESIGN SPEED: 35 MPH

LEGEND	(45) Temporary Pavement Marking, Removable, 4", Solid White	— Type III-A or Type III-B Barricade (as noted on plans)	— Temp. Concrete Barrier, Anchored, Type 2
	(46) Temporary Pavement Marking, Removable, 4", Solid Yellow	TT Construction Sign (A, B, or C)	— Temp. Concrete Barrier, Type 2 (as noted on plans)
	(47) Temporary Transverse Pavement Marking, Removable, 24", Solid White	● Standard Drum	— Temporary Energy Absorbing Terminal, CZ, TL-2
	(48) Temporary Pavement Marking, Removable, 4", Dashed White	▨ Phase Construction	MS Dynamic Message Sign
✕✕ Lane Line Removal	➔ Indicates Traffic Flow	⚡ Flashing Arrow Board	

NOT FOR CONSTRUCTION

DESIGNED: BMA	DRAWN: BDC
CHECKED: KAM	CHECKED: BMA


INDIANA DEPARTMENT OF TRANSPORTATION

MAINTENANCE OF TRAFFIC PHASE II

HORIZONTAL SCALE 1" = 50'	BRIDGE FILE ALLEN 358
VERTICAL SCALE N/A	DESIGNATION 1902834
SURVEY BOOK ---	SHEETS 9 of 63
CONTRACT B-42844	PROJECT 1902834

PHASE 3 CONSTRUCTION SEQUENCE

1. Place temporary pavement markings as shown on plans for Phase III utilizing flaggers as necessary. Existing pavement markings that conflict with Maintenance of traffic scheme shall be removed. See INDOT Std. Dwg. E 801-TCFO-02 for additional flagging operation information.
2. Move and bag signal heads at the intersection of Bluffton Road and Broadway to match traffic scheme.
3. Bag or remove existing aerial signs for northbound traffic on Broadway to match new Maintenance of traffic scheme.
4. For additional Traffic Control General Notes see INDOT Std. Dwg. E 801-TCLG-01.
6. For plan layout see Sheet No. x.

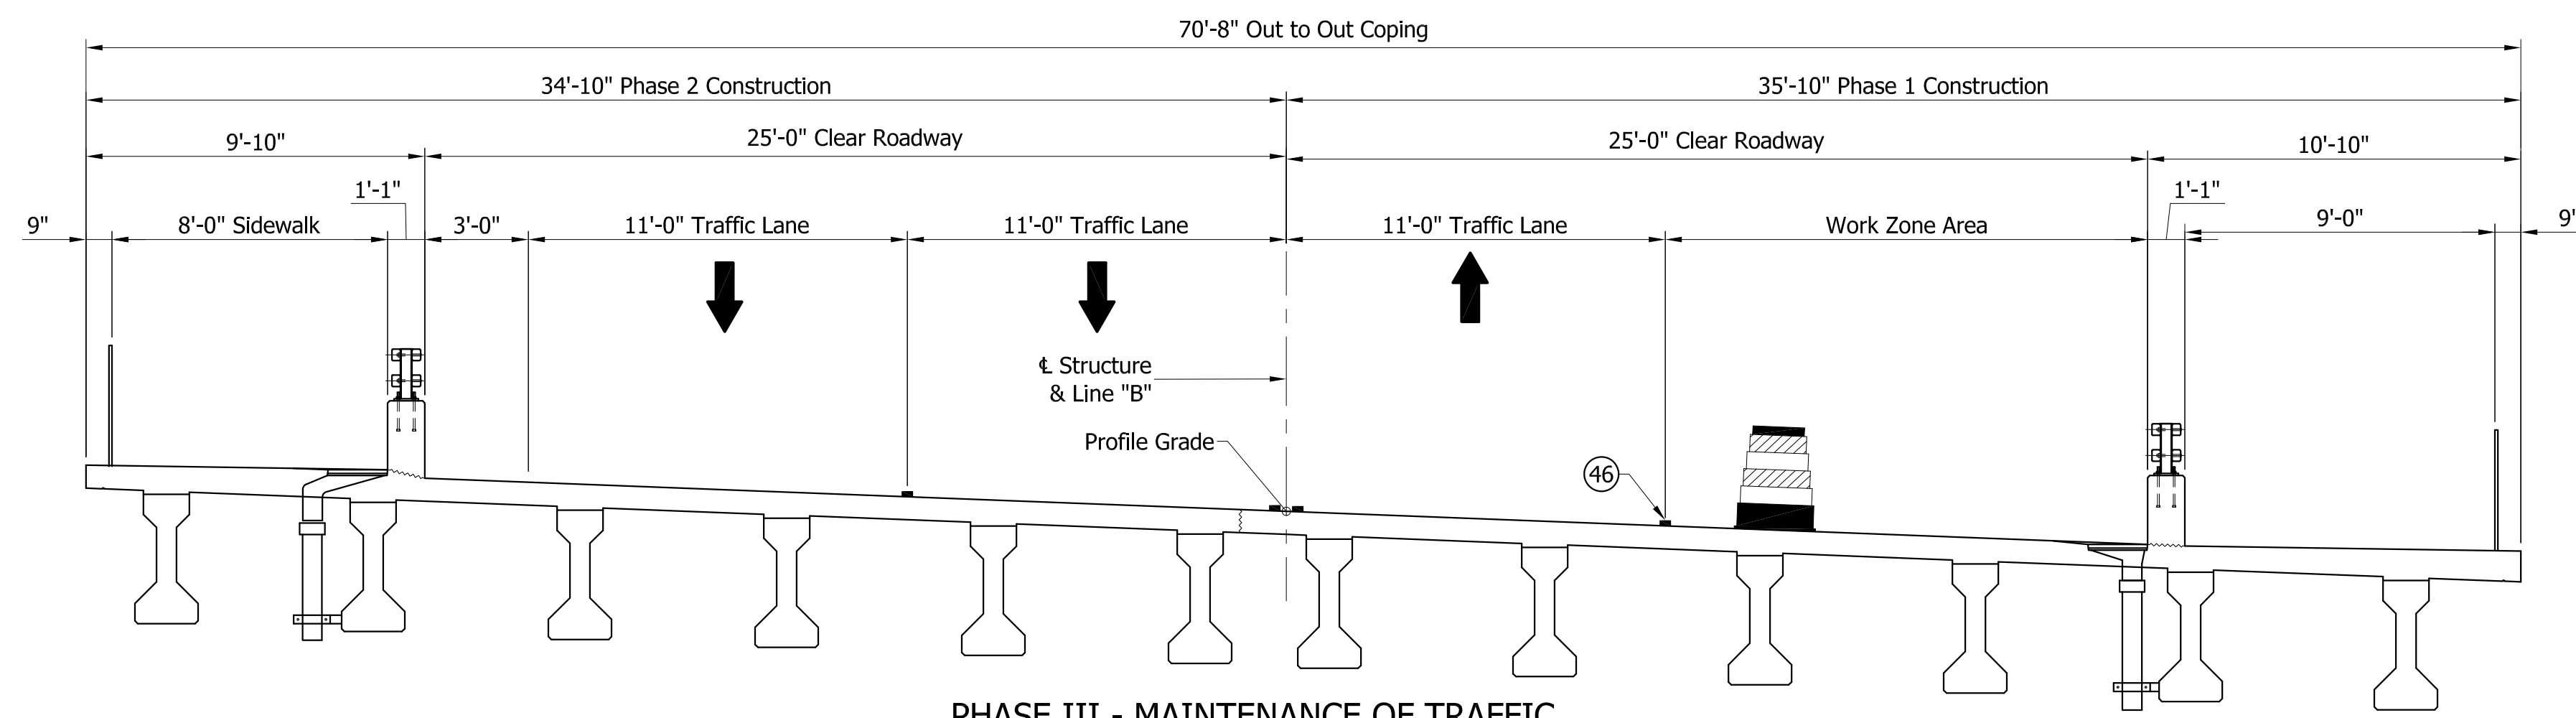

**PHASE III - MAINTENANCE OF TRAFFIC
SUPERELEVATED SPANS "A" and "B"**
Scale: 1/4"=1'-0"

Note to Reviewer:
Signalization Notes and Signal Phase Diagrams will be completed in Stage 3 Plans

CONSTRUCTION ZONE DESIGN SPEED: 35 MPH

LEGEND	(45) Temporary Pavement Marking, Removable, 4", Solid White	TT Construction Sign (A, B, or C)	Temp. Concrete Barrier, Anchored, Type 2
	(46) Temporary Pavement Marking, Removable, 4", Solid Yellow	• Standard Drum	Temp. Concrete Barrier, Type 2 (as noted on plans)
	(47) Temporary Transverse Pavement Marking, Removable, 24", Solid White	▨ Phase Construction	Temporary Energy Absorbing Terminal, CZ, TL-2
	(48) Temporary Pavement Marking, Removable, 4", Dashed White	⇒ Indicates Traffic Flow	MS Dynamic Message Sign
✕✕ Lane Line Removal		Flashing Arrow Board	


NOT FOR CONSTRUCTION

DESIGNED: BMA	DRAWN: BDC
CHECKED: KAM	CHECKED: BMA

**INDIANA
DEPARTMENT OF TRANSPORTATION**


**MAINTENANCE OF TRAFFIC
PHASE III**

HORIZONTAL SCALE AS NOTED	BRIDGE FILE ALLEN 358
VERTICAL SCALE AS NOTED	DESIGNATION 1902834
SURVEY BOOK ---	SHEETS 10 of 63
CONTRACT B-42844	PROJECT 1902834

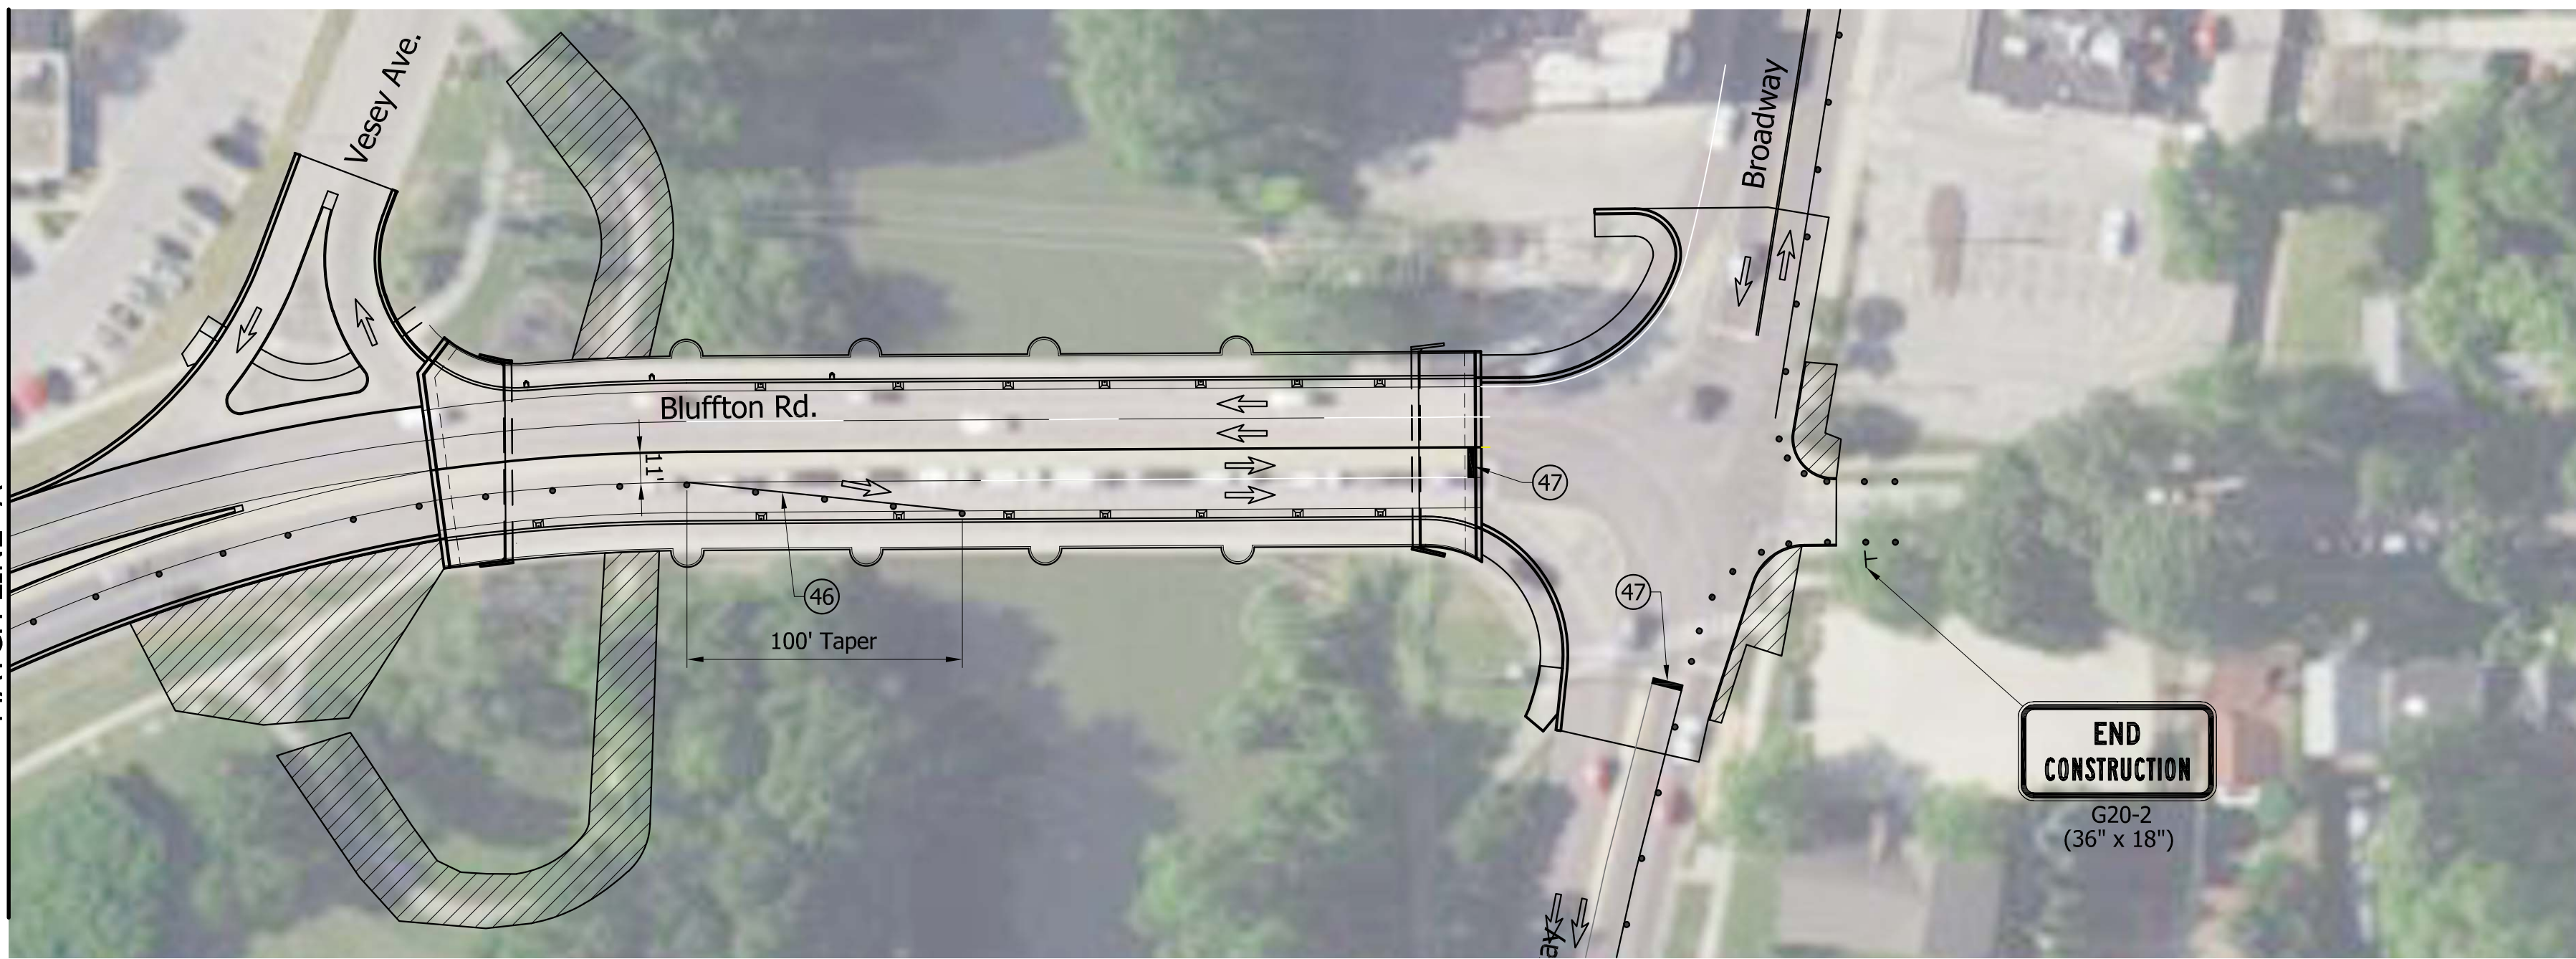

- NOTES:**
1. Access to all drives to be maintained during all phases of construction.
 2. Existing conflicting pavement markings to be removed within project limits.
 3. Intersection of Broadway and Bluffton Rd to be resurfaced after completion of new ADA ramps in NE and SE Quadrant of Broadway and Oakdale Dr. Resurface operation to be done under flagging operations. See INDOT Std. Dwg. E 801-TCFO-02 for additional flagging operation information.
 4. Additional signing details and additional Phase III information see Sheet No. 10.

CONSTRUCTION ZONE DESIGN SPEED: 35 MPH

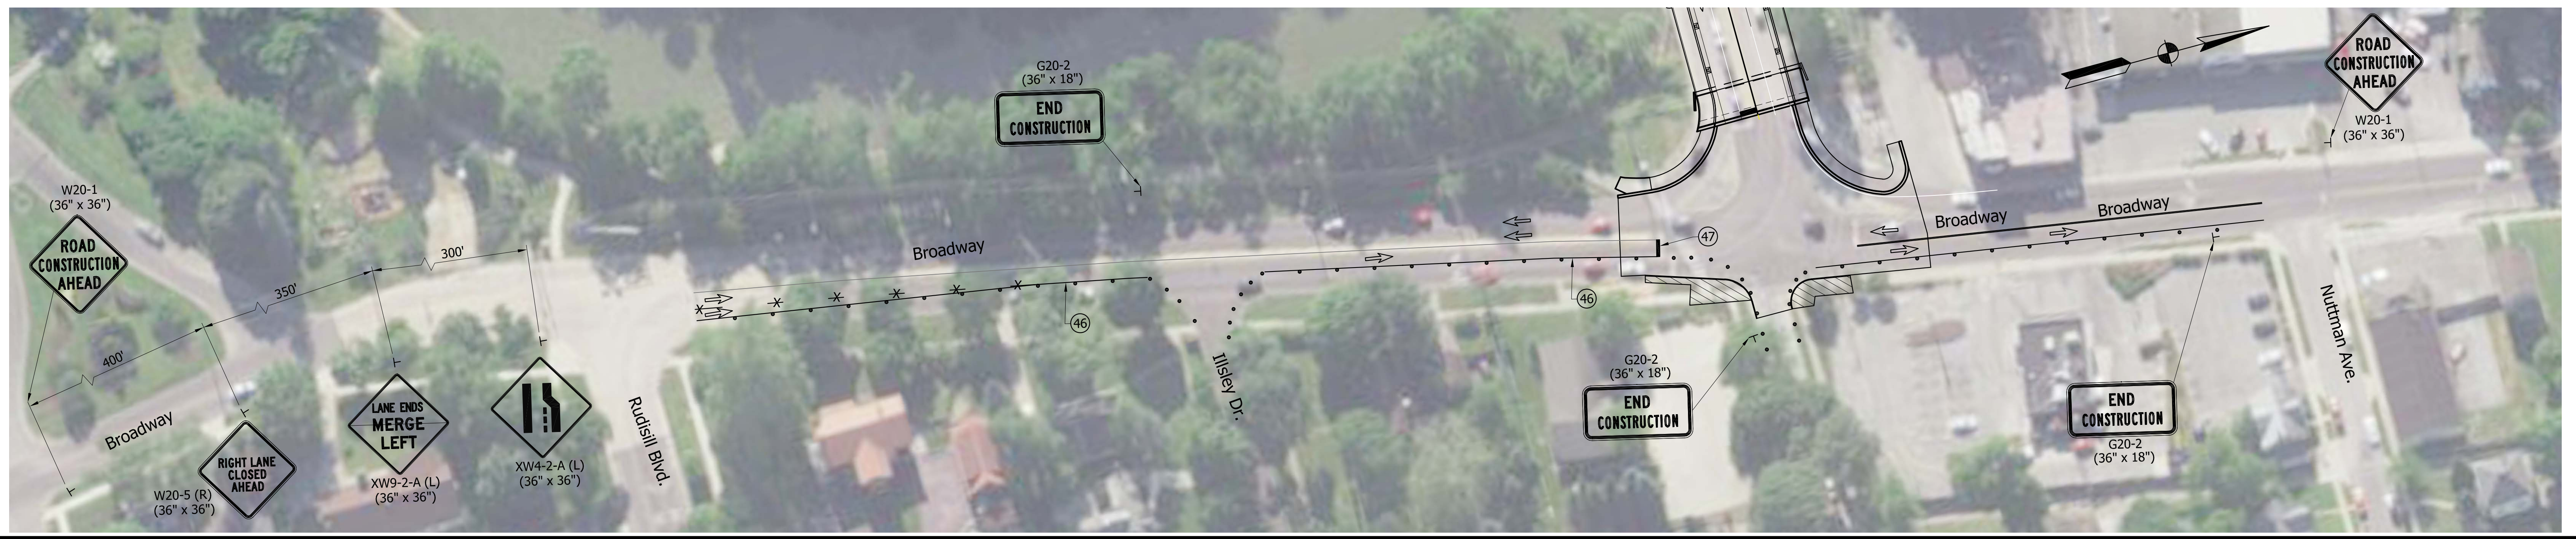

LEGEND	(45)	Temporary Pavement Marking, Removable, 4", Solid White	TT	Type III-A or Type III-B Barricade (as noted on plans)	Temp. Concrete Barrier, Anchored, Type 2
	(46)	Temporary Pavement Marking, Removable, 4", Solid Yellow	TT	Construction Sign (A, B, or C)	Temp. Concrete Barrier, Type 2 (as noted on plans)
	(47)	Temporary Transverse Pavement Marking, Removable, 24", Solid White	●	Standard Drum	Temporary Energy Absorbing Terminal, CZ, TL-2
	(48)	Temporary Pavement Marking, Removable, 4", Dashed White	▨	Phase Construction	Dynamic Message Sign
✕-✕	Lane Line Removal	⇒	Indicates Traffic Flow	MS	Flashing Arrow Board


NOT FOR CONSTRUCTION

DESIGNED: BMA DRAWN: BDC
 CHECKED: KAM CHECKED: BMA

INDIANA DEPARTMENT OF TRANSPORTATION

MAINTENANCE OF TRAFFIC PHASE III

HORIZONTAL SCALE	BRIDGE FILE
1" = 50'	ALLEN 358
VERTICAL SCALE	DESIGNATION
N/A	1902834
SURVEY BOOK	SHEETS
---	11 of 63
CONTRACT	PROJECT
B-42844	1902834

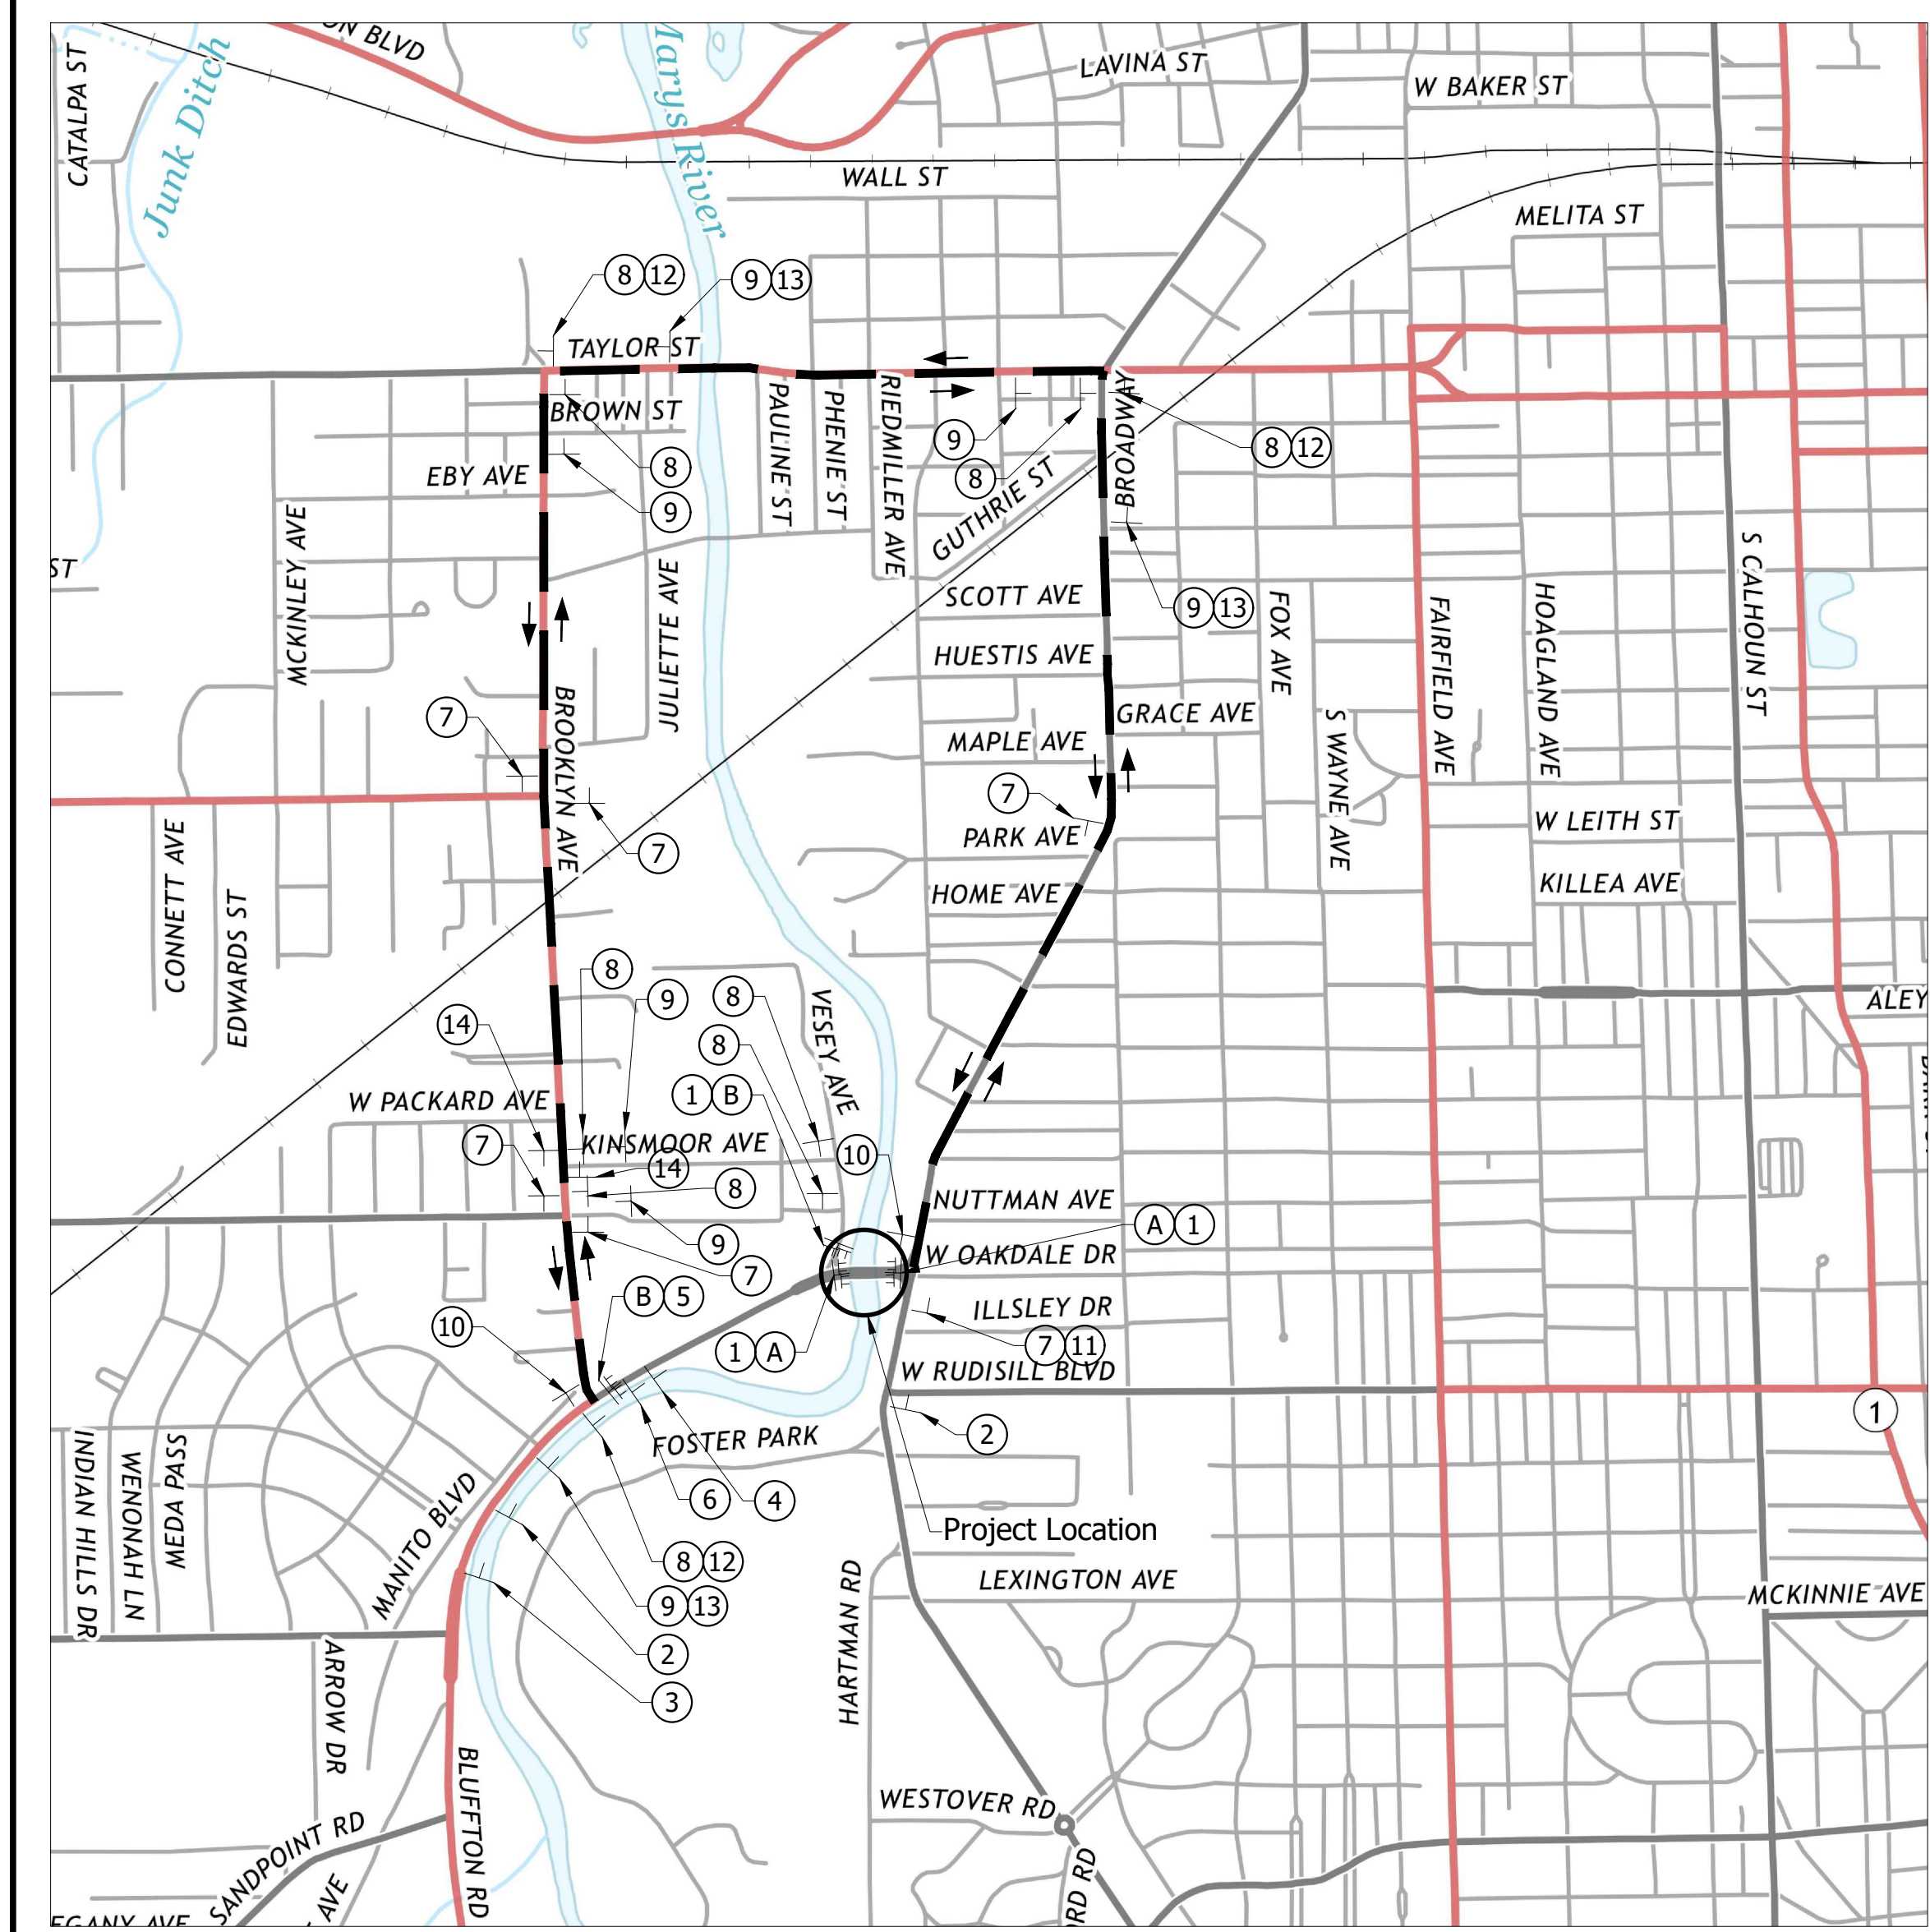

BLUFFTON ROAD AND VESEY AVE. DETOUR ROUTE AND TRUCK ROUTE
 PHASE II - BLUFFTON ROAD - 1 WEEK ROAD CLOSURE DETOUR
 PHASE II - VESEY AVENUE - ENTIRETY OF PHASE
 Scale: 1" = 1000'

LEGEND	DESCRIPTION	SIZE	TYPE	NO.
①	ROAD CLOSED	R11-2	Road Closure Assembly	3
②	DETOUR AHEAD	XW20-2	A	2
③	ROAD CLOSED AHEAD	XW20-3	A	1
④	ROAD CLOSED 1500'	XW20-3 (1500')	A	1
⑤	ROAD CLOSED TO THRU TRAFFIC	R11-4	Road Closure Assembly	1
⑥	ROAD CLOSED ON OR AFTER X / X / XX	XW20-6	A	3
⑦	DETOUR EAST WEST BLUFFTON ROAD	XM4-8 M3-2 or M3-4 M1-5 (BLUFFTON ROAD) M6-3	Detour Route Assembly	6
⑧	DETOUR EAST WEST BLUFFTON ROAD	XM4-8 M3-2 or M3-4 M1-5 (BLUFFTON ROAD) M6-1 (L or R)	Detour Route Assembly	9
⑨	DETOUR EAST WEST BLUFFTON ROAD	XM4-8 M3-2 or M3-4 M1-5 (BLUFFTON ROAD) M5-1 (L or R)	Detour Route Assembly	7
⑩	END DETOUR BLUFFTON ROAD	XM4-6 XM4-8 M1-5 (BLUFFTON ROAD) M5-1 (L or R) or M6-3	Detour Route Assembly	2
A	TYPE III-A BARRICADE		12'	336'
B	TYPE III-B BARRICADE		12'	48'

LEGEND	DESCRIPTION	SIZE	TYPE	NO.
⑪	DETOUR VESEY AVE	XM4-8 M1-5 (VESEY AVE.) M6-3	Detour Route Assembly	1
⑫	DETOUR VESEY AVE	XM4-8 M1-5 (VESEY AVE.) M6-1 (L or R)	Detour Route Assembly	3
⑬	DETOUR VESEY AVE	XM4-8 M1-5 (VESEY AVE.) M5-1 (L or R)	Detour Route Assembly	3
⑭	END DETOUR VESEY AVE	XM4-6 XM4-8 M1-5 (VESEY AVE.) M5-1 (L or R)	Detour Route Assembly	2

TYPE OF SIGN	QUANTITY	PAY ITEM
ROAD CLOSURE ASSEMBLY	4 Each	801-04308
DETOUR ROUTE ASSEMBLY	33 Each	801-06625
CONSTRUCTION SIGN TYPE A	5 Each	801-06640
BARRICADE, III-A	336 Lft.	801-07118
BARRICADE, III-B	48 Lft.	801-07119

LEGEND	DESCRIPTION
	Construction Sign (A, B, or C)
	Indicates Traffic Flow
	Type III-A or Type III-B Barricade (as noted on plans)

NOT FOR CONSTRUCTION

DESIGNED: BMA	DRAWN: BDC
CHECKED: KAM	CHECKED: BMA

INDIANA
 DEPARTMENT OF TRANSPORTATION
 BLUFFTON RD. & VESEY AVE.
 DETOUR ROUTE

HORIZONTAL SCALE	BRIDGE FILE
AS NOTED	ALLEN 358
VERTICAL SCALE	DESIGNATION
AS NOTED	1902834
SURVEY BOOK	SHEETS
---	12 of 63
CONTRACT	PROJECT
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



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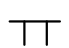


PEDESTRIAN DETOUR ROUTE PHASES I & III
Scale: 1" = 200'



PEDESTRIAN DETOUR ROUTE PHASE II
Scale: 1" = 200'

LEGEND	DESCRIPTION	SIZE	TYPE	NO. (PH I)	NO. (PH II)	
15		R9-9	24" X 12"	A	3	3
16		R9-11 (L or R)	24" X 12"	A	3	4
17		M4-9b (L or R)	24" X 12"	A	4	3
B	TYPE III-B BARRICADE		12'		48	48

TYPE OF SIGN	QUANTITY	PAY ITEM
CONSTRUCTION SIGN TYPE A	11 Each	801-06640
BARRICADE, III-B	48 Lt.	801-07119

LEGEND	DESCRIPTION
	Construction Sign (A, B, or C)
	Indicates Traffic Flow
	Type III-A or Type III-B Barricade (as noted on plans)


NOT FOR CONSTRUCTION

DESIGNED: BMA	DRAWN: BDC
CHECKED: KAM	CHECKED: BMA

INDIANA
DEPARTMENT OF TRANSPORTATION

PEDESTRIAN DETOUR ROUTE


HORIZONTAL SCALE	BRIDGE FILE
AS NOTED	ALLEN 358
VERTICAL SCALE	DESIGNATION
AS NOTED	1902834
SURVEY BOOK	SHEETS
---	13 of 63
CONTRACT	PROJECT
B-42844	1902834

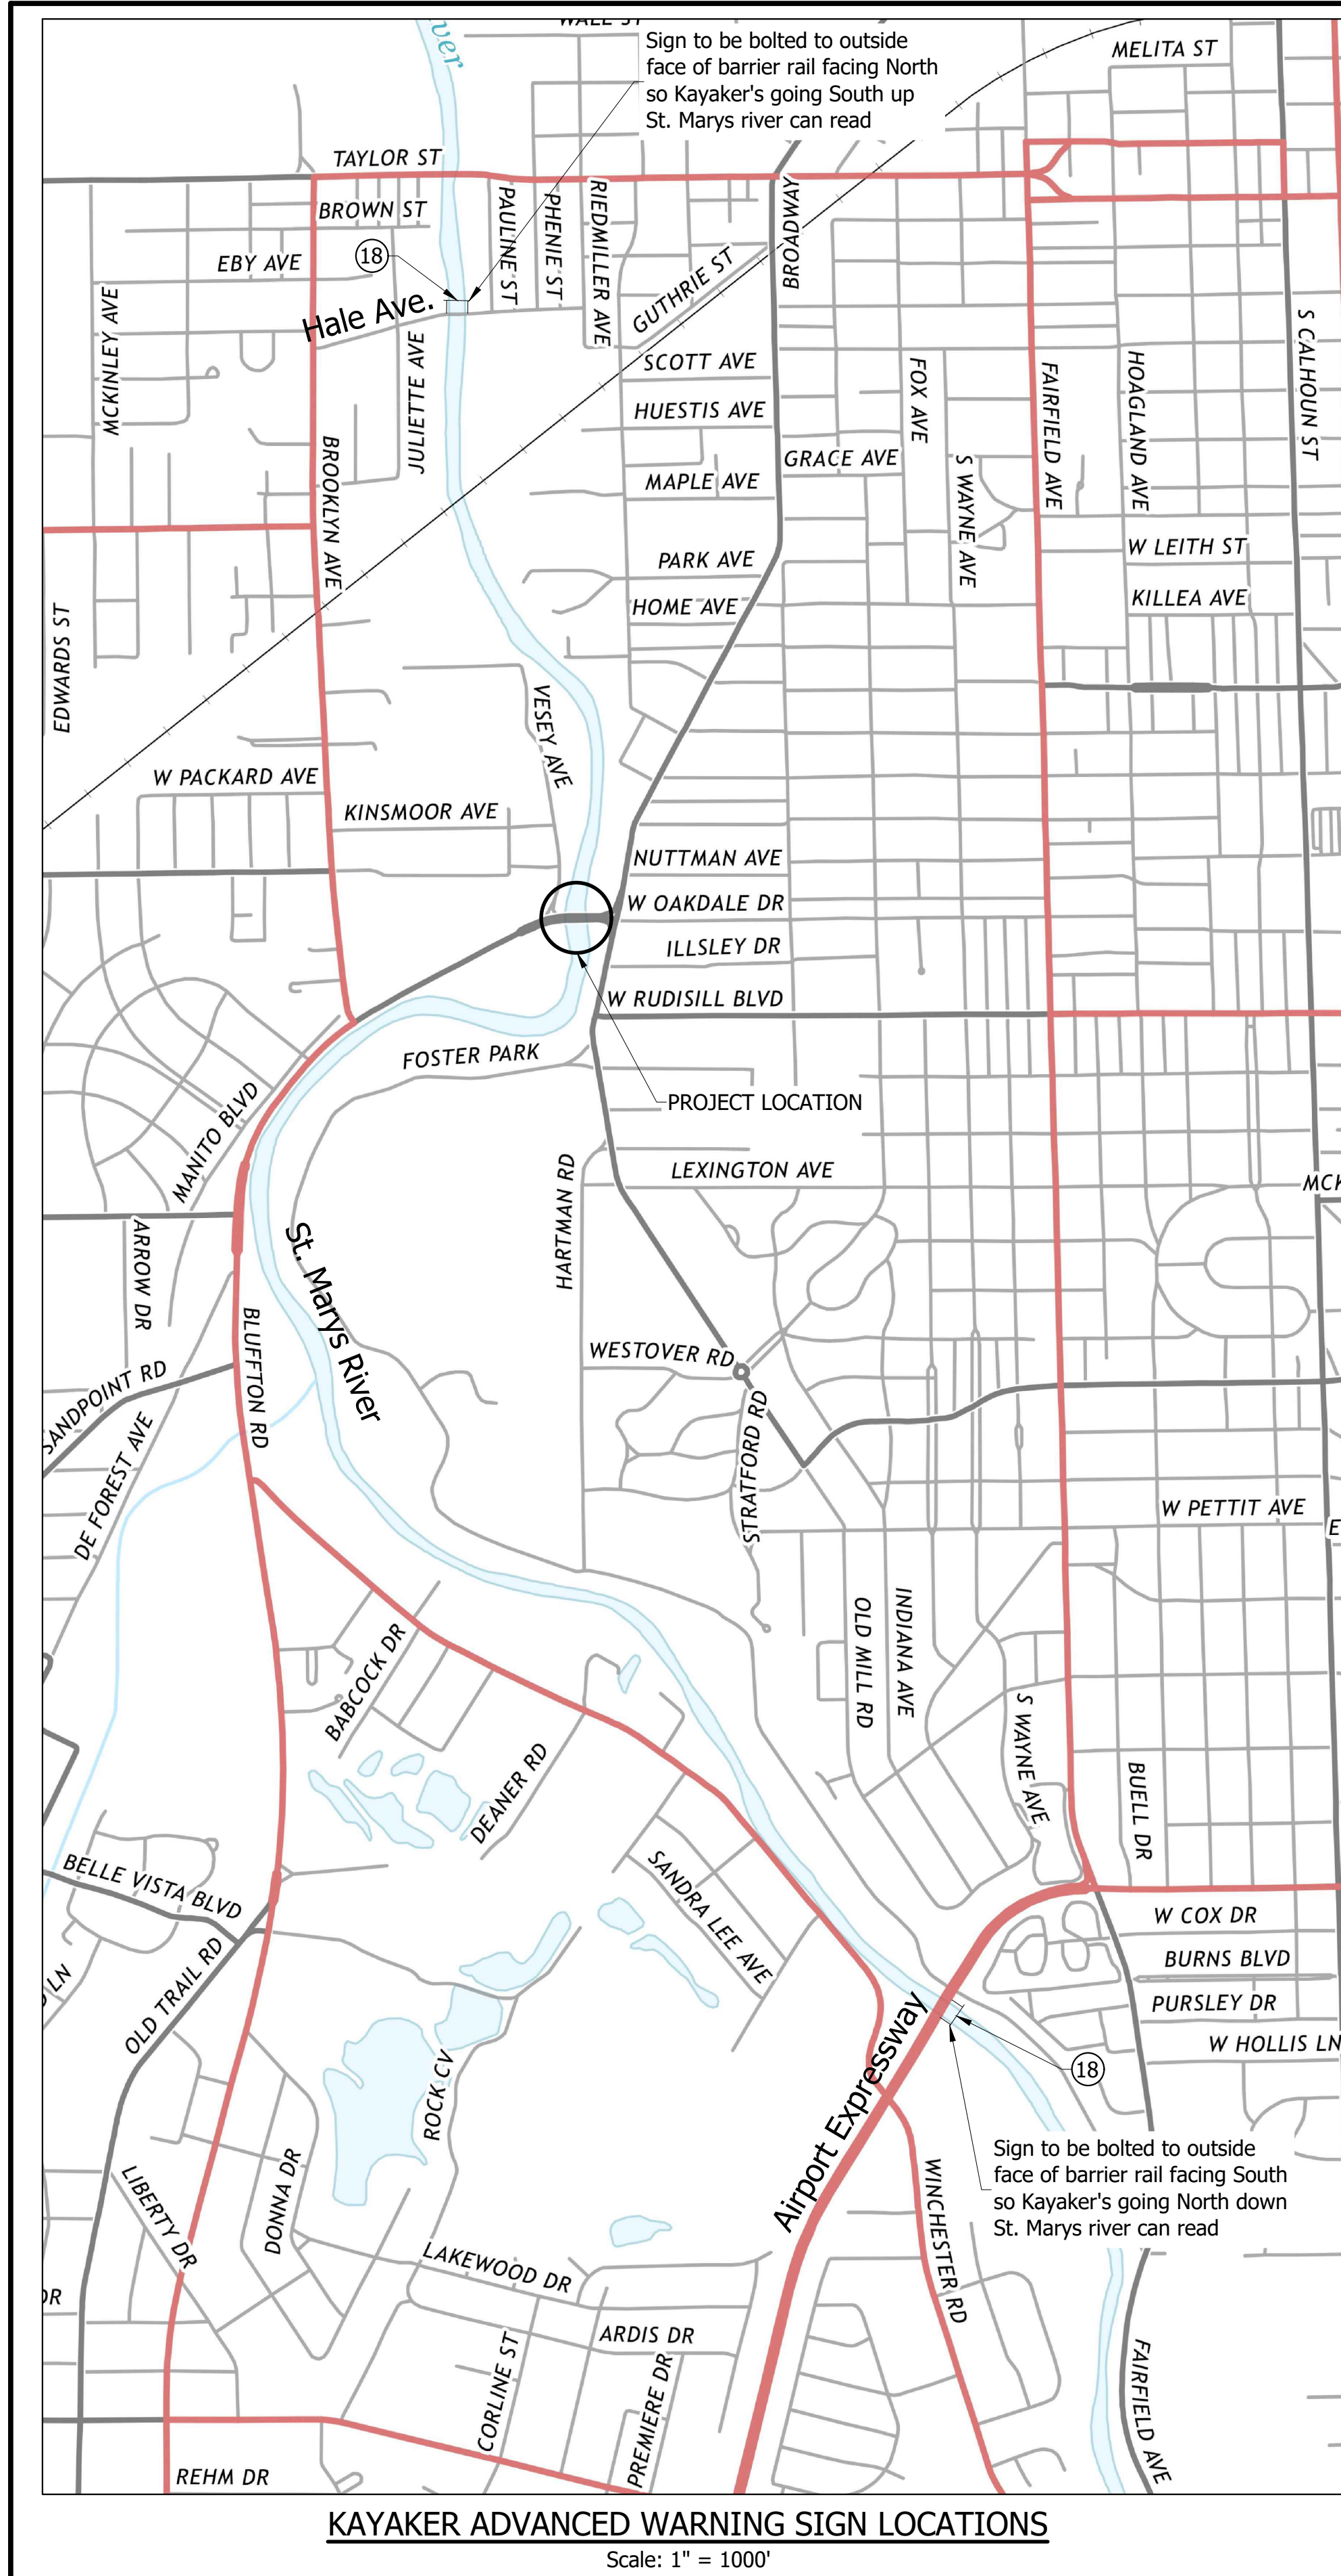

KAYAKER EXIT AND RE-ENTRY SIGNING
Scale: 1" = 200'

LEGEND	DESCRIPTION	SIZE	TYPE	QUANTITY	
(18)	CAUTION IN-CHANNEL RESTRICTIONS WORK AHEAD	C1	60" X 48"	C	2
(19)	KAYAKER EXIT HERE ➔	C2	48" X 24"	C	2
(20)	KAYAKER RE-ENTRY ➔	C3	48" X 24"	C	2
○	BUOY	○			48

TYPE OF SIGN	QUANTITY	PAY ITEM
CONSTRUCTION SIGN TYPE B	6 Each	801-06645
CONSTRUCTION SIGN TYPE C	4 Each	801-03290
BUOY	9 Each	

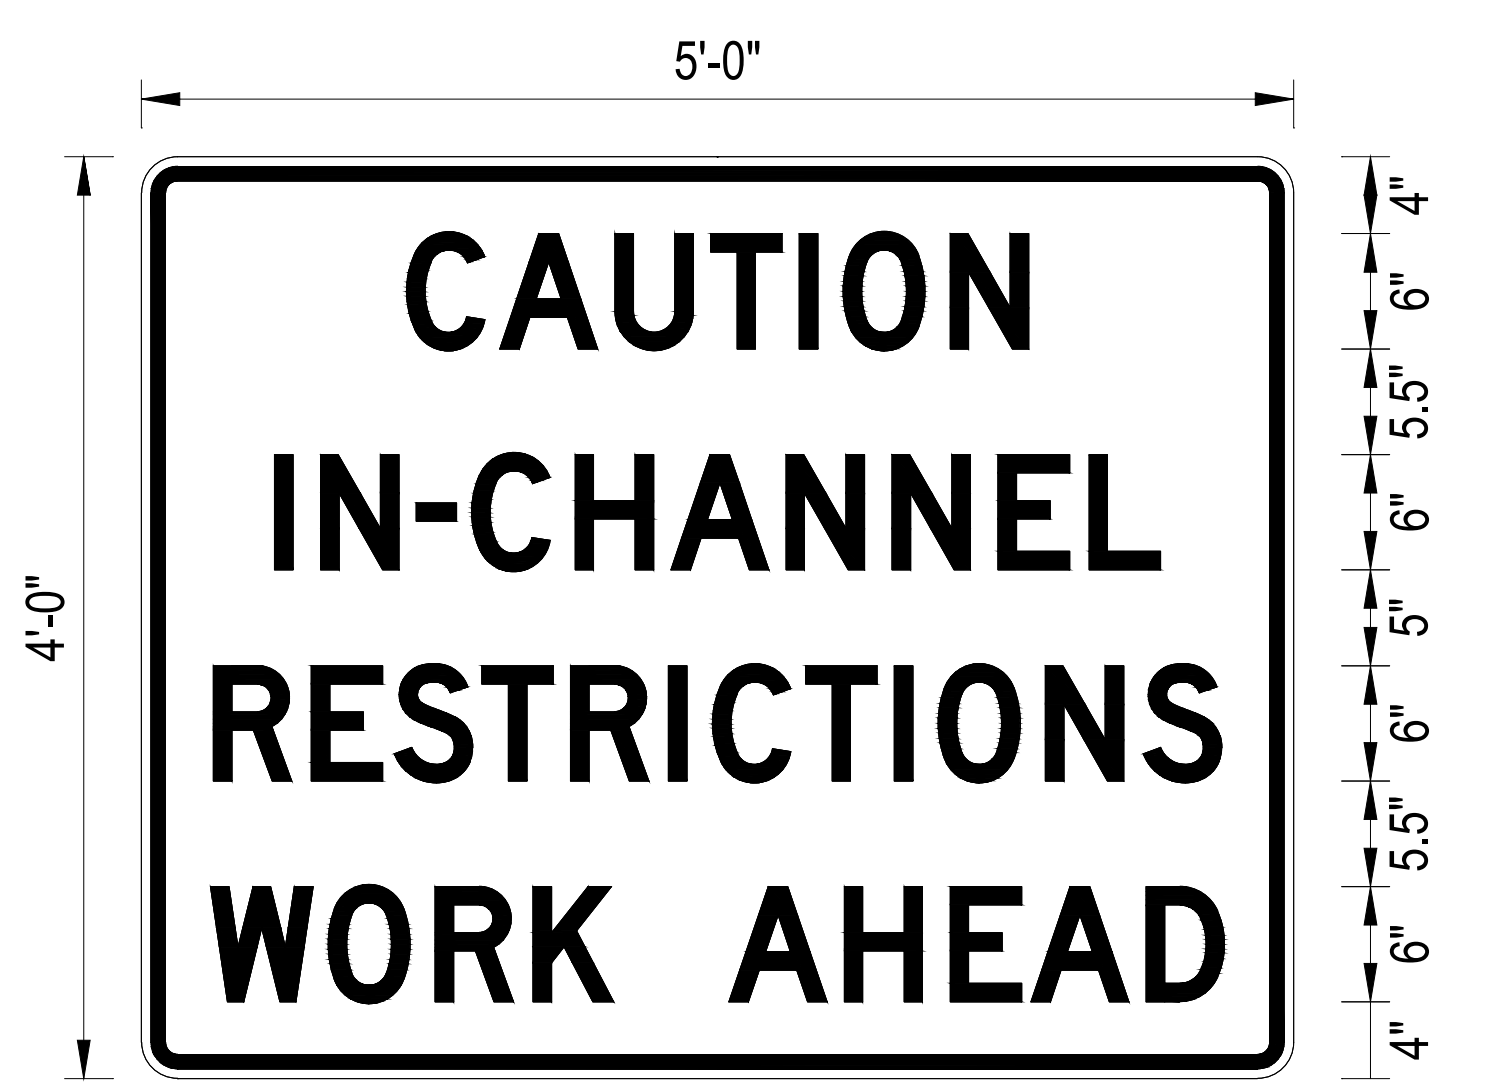

BORDER
R=1.38"
TH=0.75"
IN=0.5"

Panel Style: 54x36 Construction.ssi
M.U.T.C.D.: 2009 Edition
CONSTRUCTION SIGN C1



BORDER
R=1.38"
TH=0.75"
IN=0.5"

Panel Style: 54x36 Construction.ssi
M.U.T.C.D.: 2009 Edition
CONSTRUCTION SIGN C2



BORDER
R=1.38"
TH=0.75"
IN=0.5"

Panel Style: 54x36 Construction.ssi
M.U.T.C.D.: 2009 Edition
CONSTRUCTION SIGN C3



LEGEND	DESCRIPTION
TT	Construction Sign (A, B, or C)
➔	Indicates Traffic Flow
○	Buoy (Spa. @ 30' max. in waterway)

**NOT FOR
CONSTRUCTION**

DESIGNED: BMA	DRAWN: BDC
CHECKED: KAM	CHECKED: BMA

INDIANA DEPARTMENT OF TRANSPORTATION	
KAYAKER DETOUR ROUTE	

HORIZONTAL SCALE AS NOTED	BRIDGE FILE ALLEN 358
VERTICAL SCALE AS NOTED	DESIGNATION 1902834
SURVEY BOOK ----	SHEETS 14 of 63
CONTRACT B-42844	PROJECT 1902834

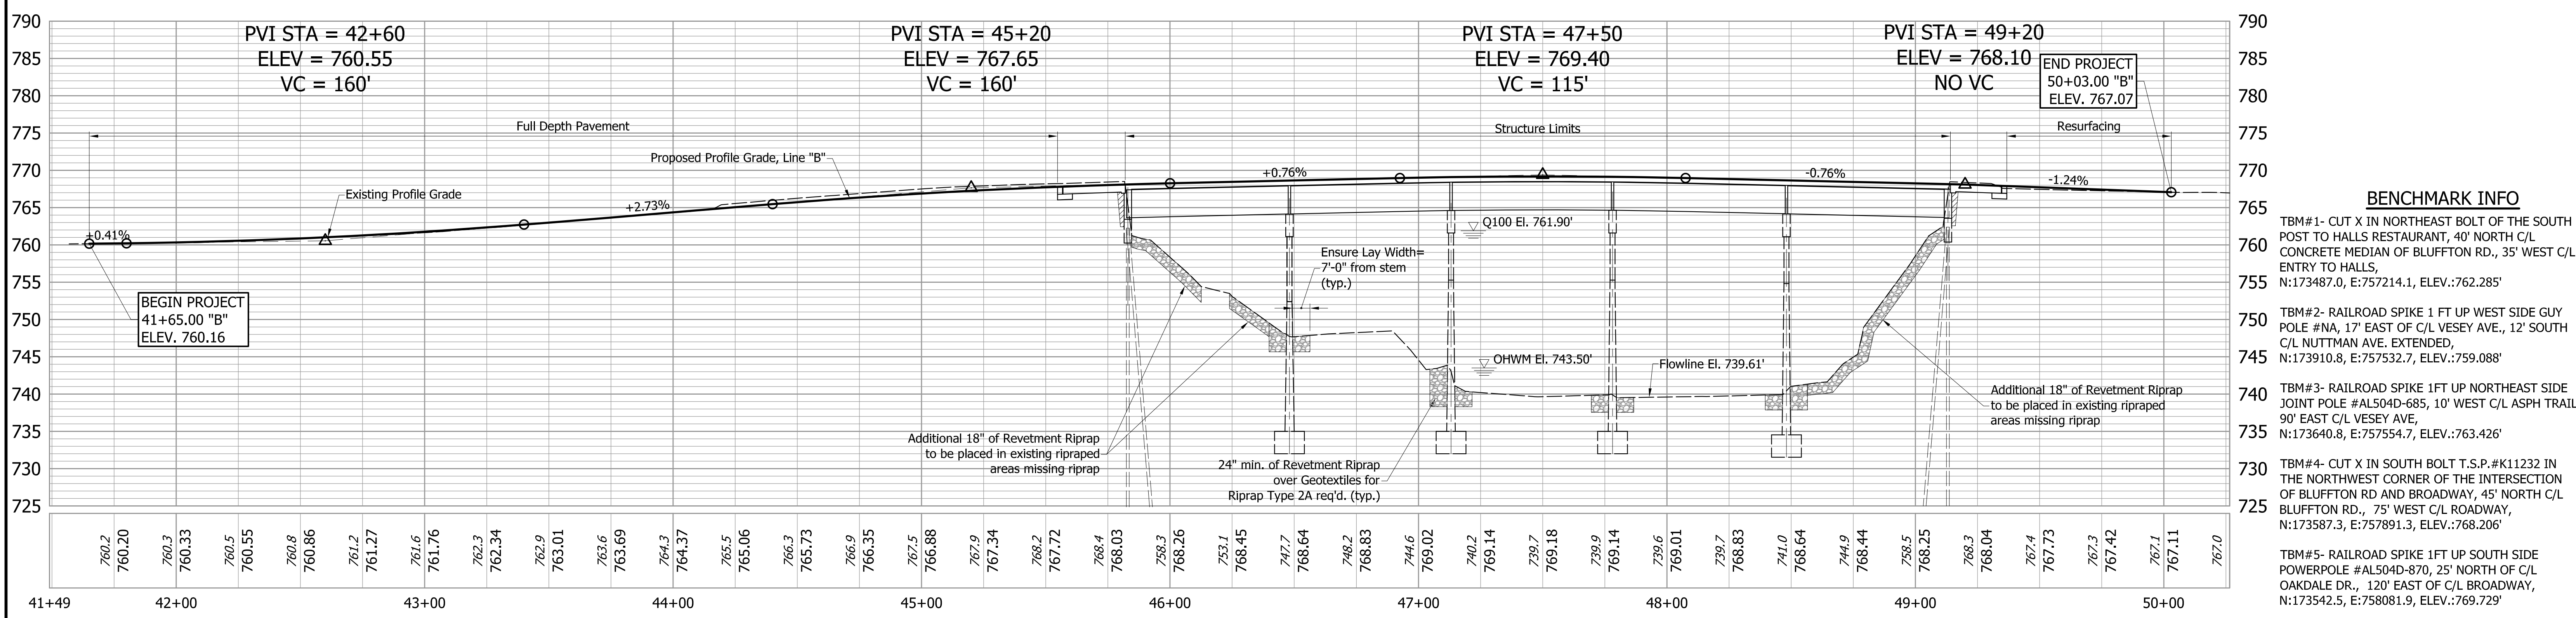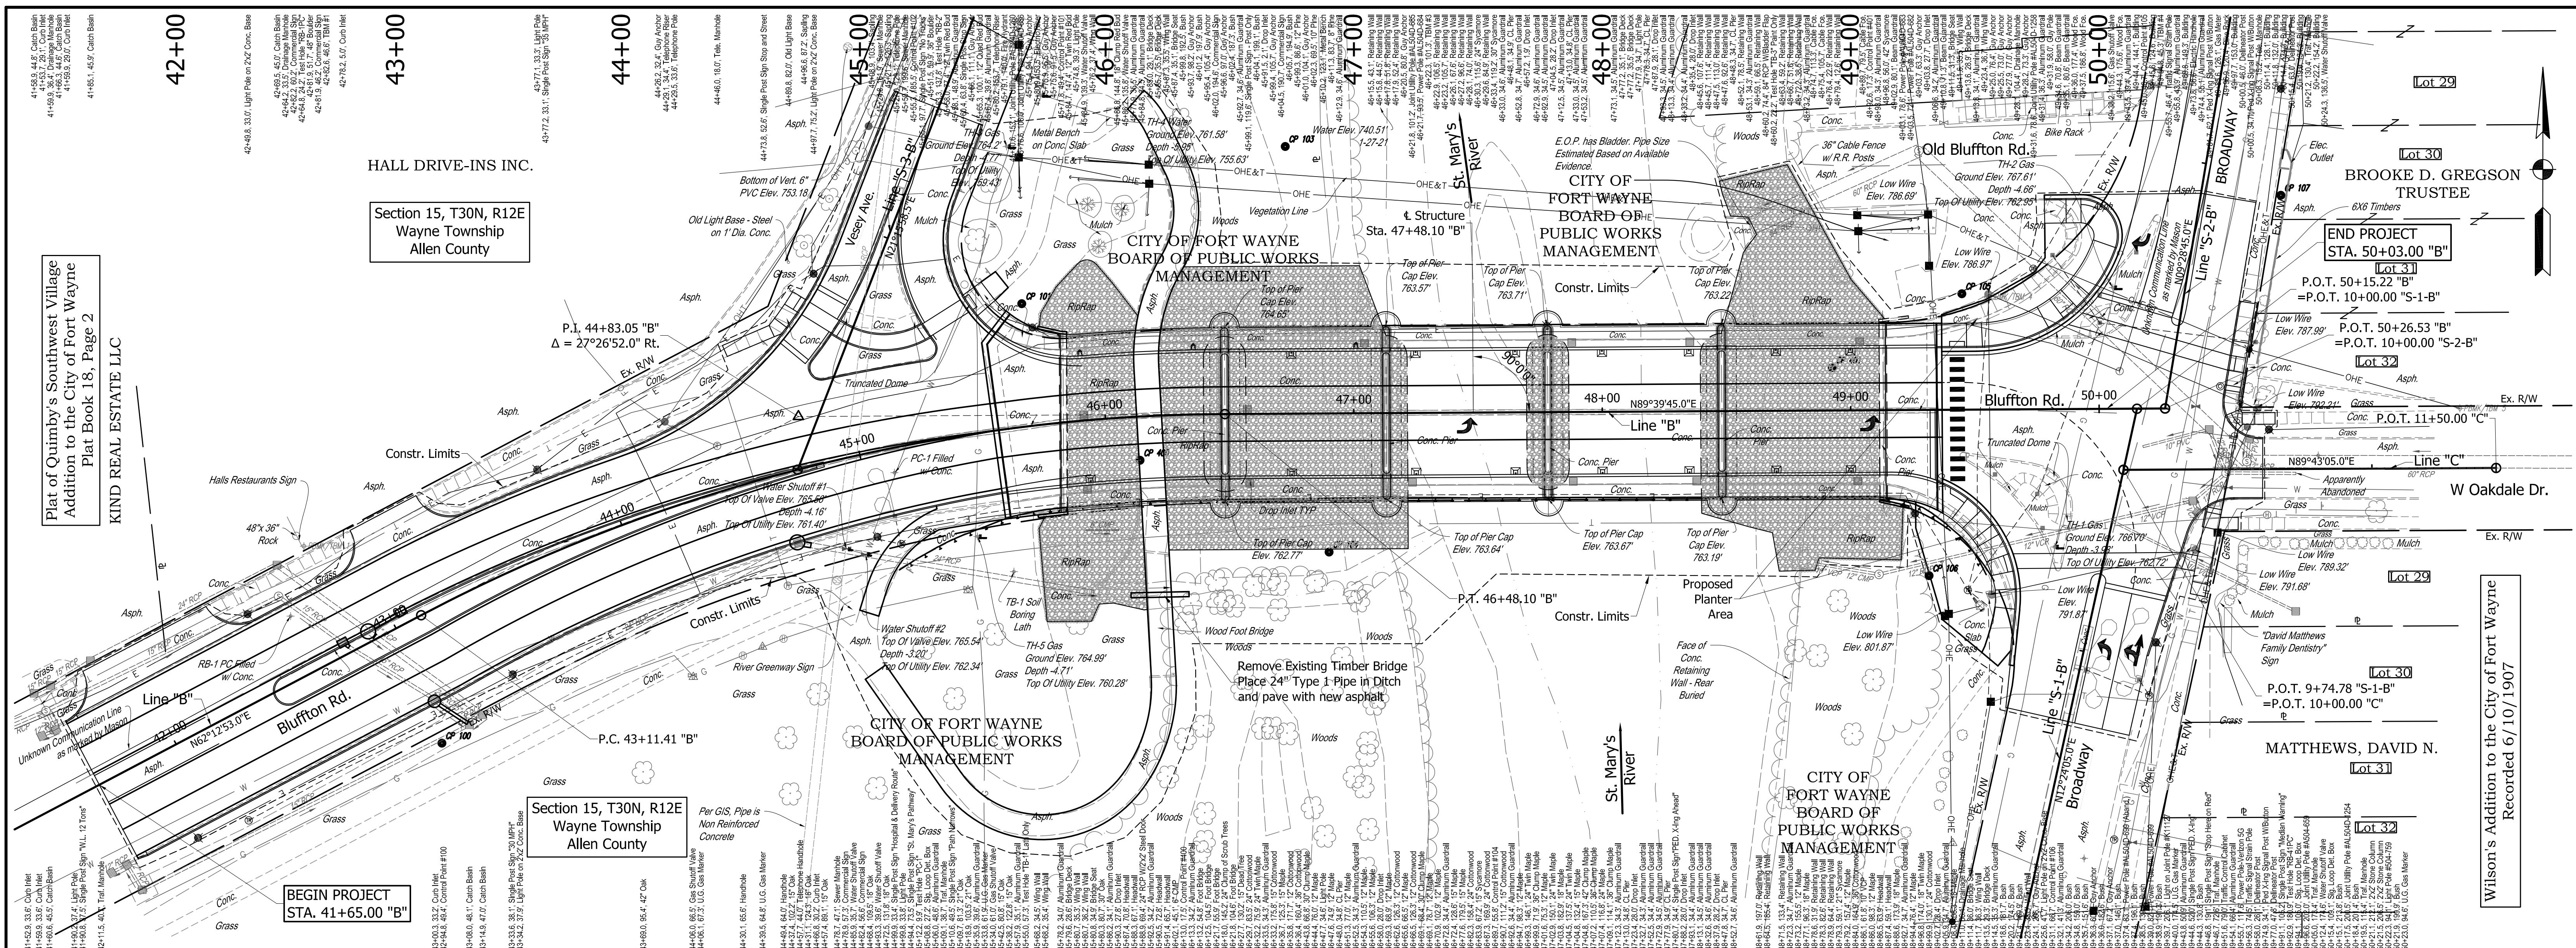


- BENCHMARK INFO**
- TBM#1- CUT X IN NORTHEAST BOLT OF THE SOUTH POLE #NA, 17' EAST OF C/L VESEY AVE., 12' SOUTH C/L NUTTMAN AVE. EXTENDED, ELEV.:759.08'
 - TBM#2- RAILROAD SPIKE 1 FT UP WEST SIDE GUY POLE #NA, 17' EAST OF C/L VESEY AVE., 12' SOUTH C/L NUTTMAN AVE. EXTENDED, ELEV.:759.08'
 - TBM#3- RAILROAD SPIKE 1 FT UP NORTHEAST SIDE JOINT POLE #AL504D-685, 10' WEST C/L ASPH TRAIL, 90' EAST C/L VESEY AVE, ELEV.:763.426'
 - TBM#4- CUT X IN SOUTH BOLT T.S.#K11232 IN THE NORTHWEST CORNER OF THE INTERSECTION OF BLUFFTON RD AND BROADWAY, 45' NORTH C/L BLUFFTON RD., 75' WEST C/L BROADWAY, N:173587.3, E:757891.9, ELEV.:768.206'
 - TBM#5- RAILROAD SPIKE 1 FT UP SOUTH SIDE POWERPOLE #AL504D-870, 25' NORTH OF C/L OAKDALE DR., 120' EAST OF C/L BROADWAY, N:173542.5, E:758081.9, ELEV.:769.729'

		INDIANA DEPARTMENT OF TRANSPORTATION PLAN AND PROFILE LINE "B"		<table border="1"> <tr> <td>HORIZONTAL SCALE</td> <td>BRIDGE FILE</td> </tr> <tr> <td>1"=30'</td> <td>ALLEN 358</td> </tr> <tr> <td>VERTICAL SCALE</td> <td>DESIGNATION</td> </tr> <tr> <td>1"=10'</td> <td>1902834</td> </tr> <tr> <td>SURVEY BOOK</td> <td>SHEETS</td> </tr> <tr> <td>---</td> <td>15 OF 63</td> </tr> <tr> <td>CONTRACT</td> <td>PROJECT</td> </tr> <tr> <td>B-42844</td> <td>1902834</td> </tr> </table>		HORIZONTAL SCALE	BRIDGE FILE	1"=30'	ALLEN 358	VERTICAL SCALE	DESIGNATION	1"=10'	1902834	SURVEY BOOK	SHEETS	---	15 OF 63	CONTRACT	PROJECT	B-42844	1902834
HORIZONTAL SCALE	BRIDGE FILE																				
1"=30'	ALLEN 358																				
VERTICAL SCALE	DESIGNATION																				
1"=10'	1902834																				
SURVEY BOOK	SHEETS																				
---	15 OF 63																				
CONTRACT	PROJECT																				
B-42844	1902834																				
		<p>DESIGNED: BMA DRAWN: BDC</p> <p>CHECKED: KAM CHECKED: BMA</p>		<p>NOT FOR CONSTRUCTION</p>																	

CITY OF FORT WAYNE
BOARD OF PUBLIC WORKS
MANAGEMENT

HALL DRIVE-INS INC.

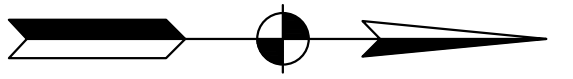

CURVE DATA

P.I. 1+08.50 "P"
Δ = 108°34'32.5" Lt.
R = 40.00'
T = 55.64'
L = 75.80'
E = 28.53'

P.I. 1+08.50 "P"
Δ = 108°34'32.5" Lt.

CURVE DATA

P.I. 1+50.26 "P"
Δ = 39°35'39.8" Lt.
R = 60.00'
T = 21.60'
L = 41.46'
E = 3.77'

P.I. 1+50.26 "P"
Δ = 39°35'39.8" Lt.

P.T. 1+70.12 "P"

CURVE DATA



P.I. 3+18.69 "P"
Δ = 32°54'49.1" Rt.
R = 80.00'
T = 23.63'
L = 45.96'
E = 3.42'

CURVE DATA

P.I. 3+61.39 "P"
Δ = 55°15'34.4" Lt.
R = 35.00'
T = 18.32'
L = 33.76'
E = 4.51'

CURVE DATA

P.I. 4+03.43 "P"
Δ = 32°40'11.4" Lt.
R = 30.00'
T = 8.79'
L = 17.11'
E = 1.26'

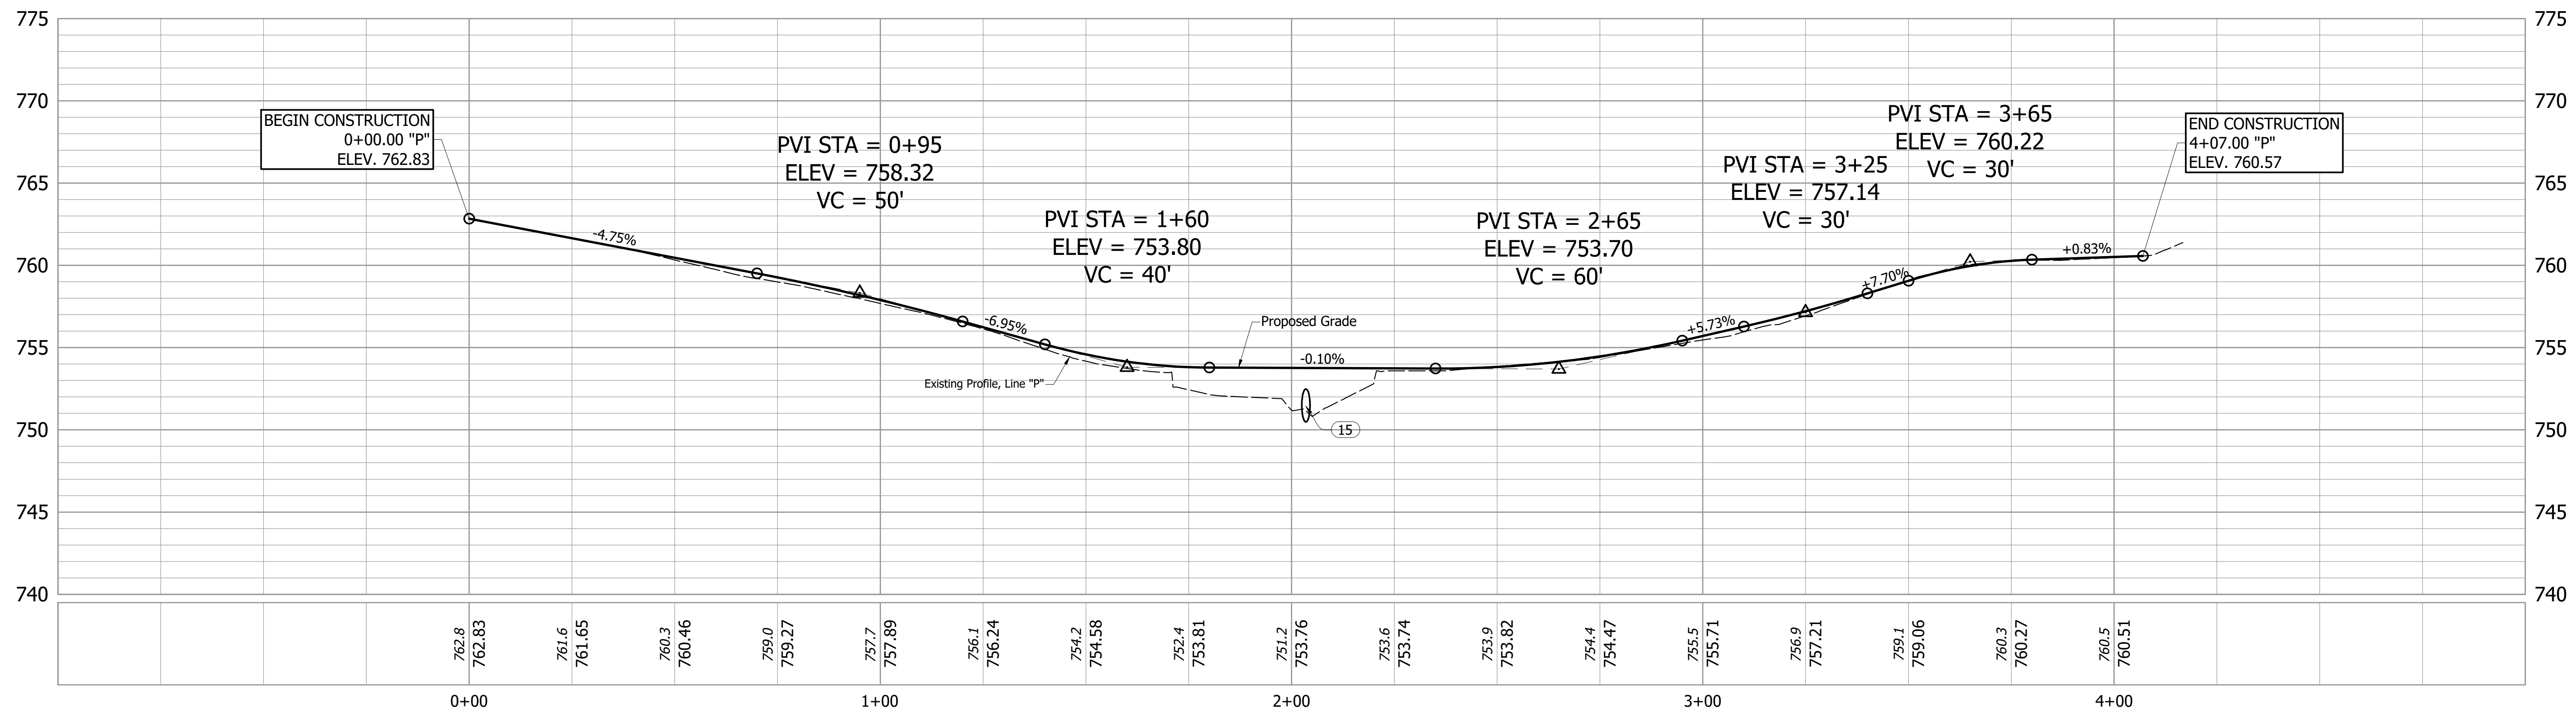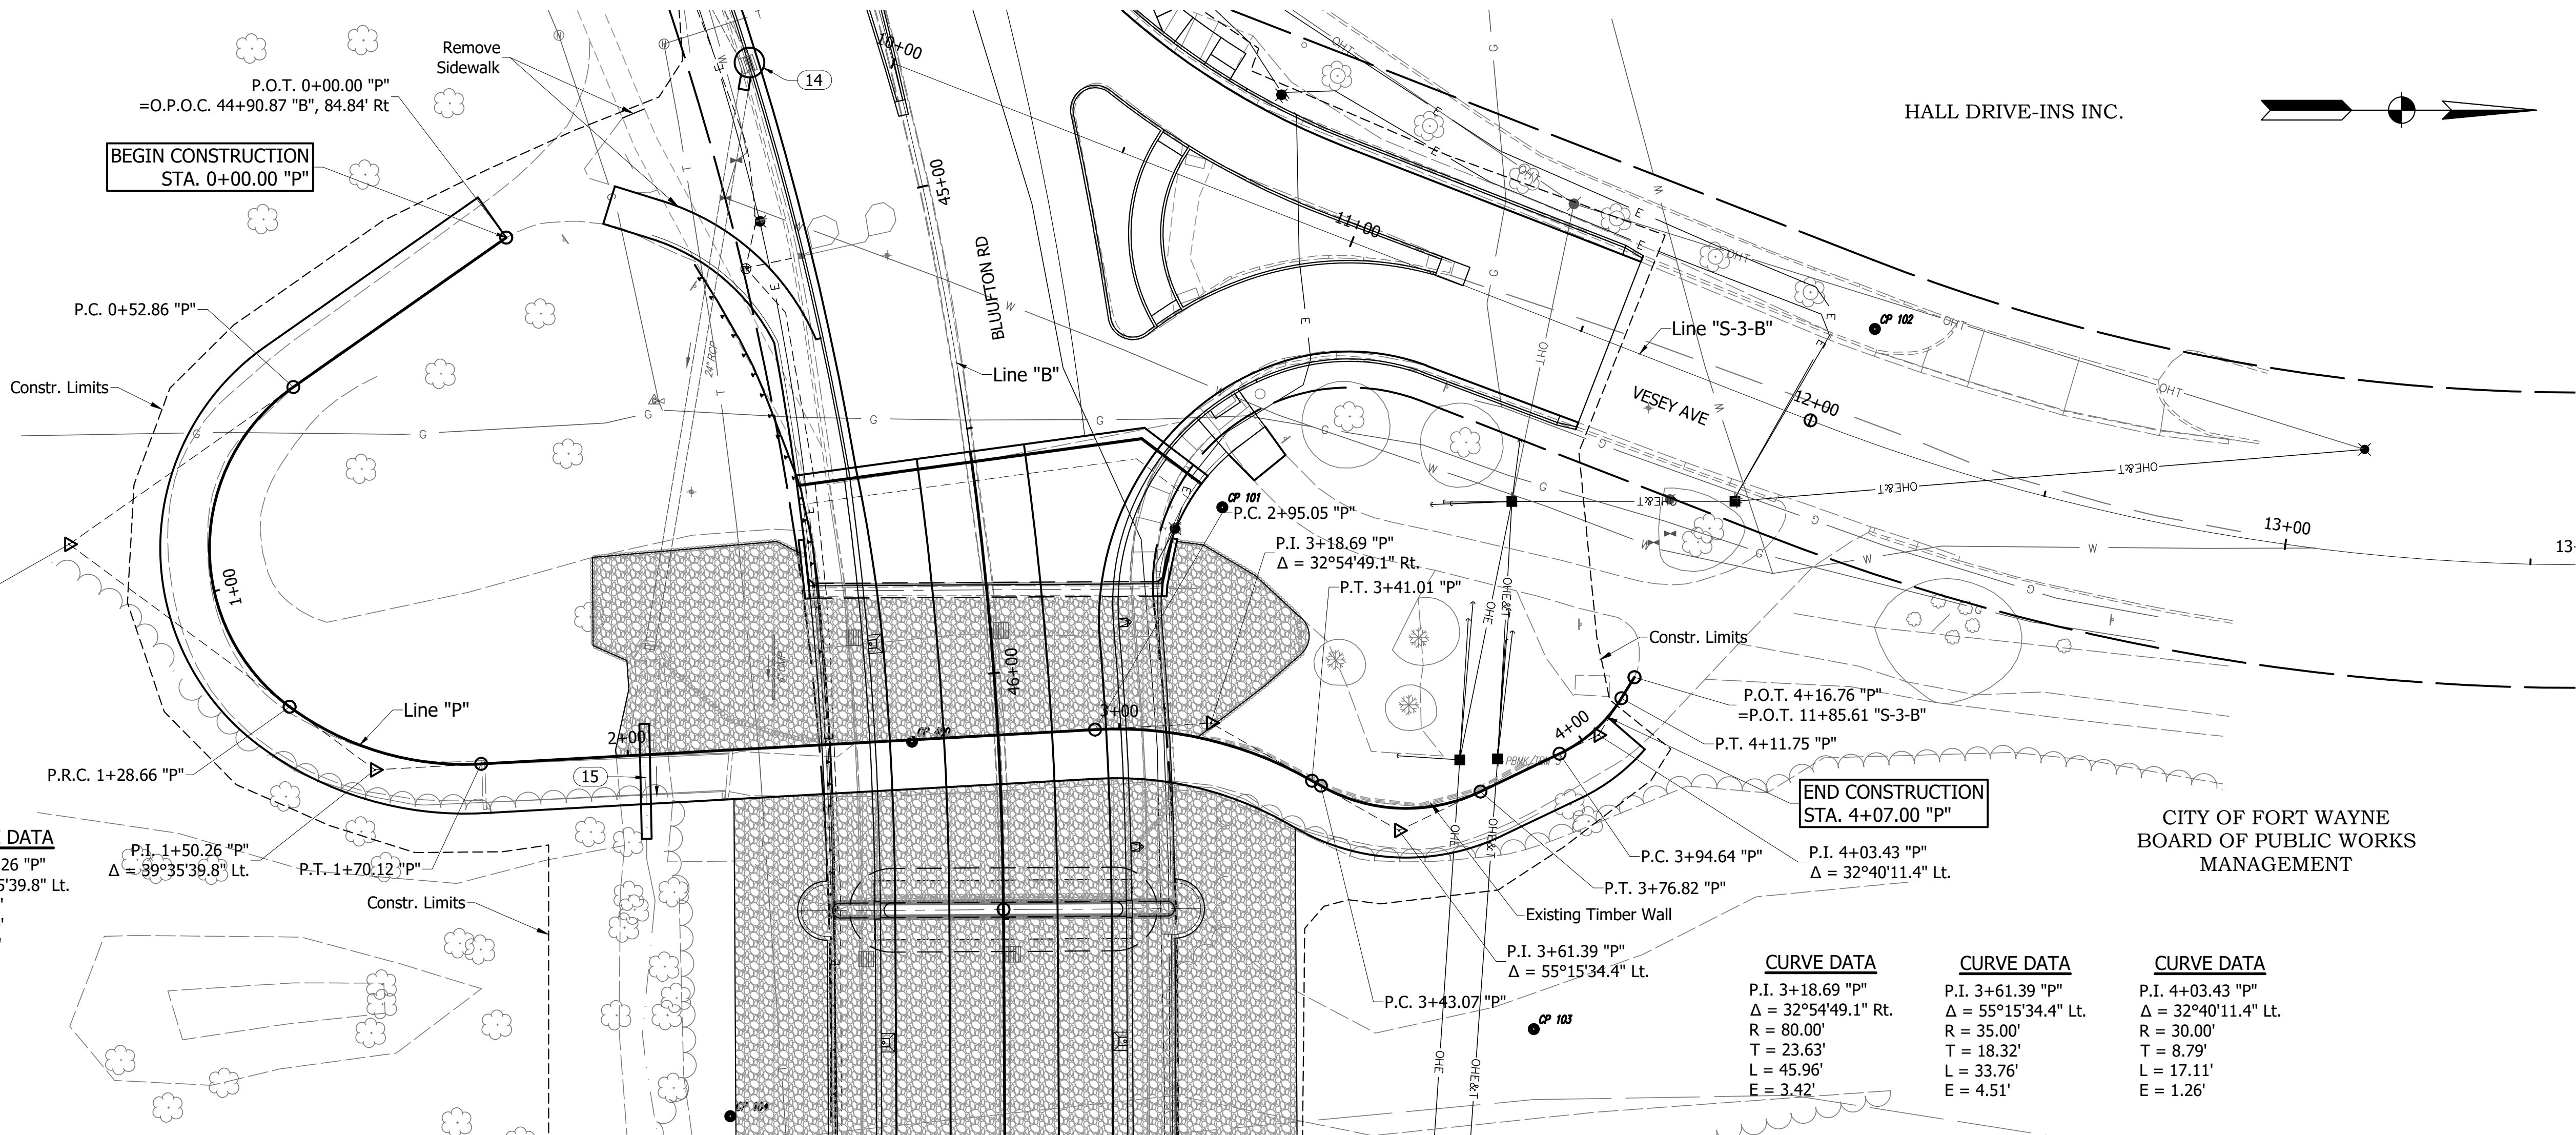


NOT FOR
CONSTRUCTION

DESIGNED: BMA DRAWN: CNC
CHECKED: KAM CHECKED: BMA

INDIANA
DEPARTMENT OF TRANSPORTATION

PLAN AND PROFILE
ST. MARYS PATHWAY - LINE "P"

HORIZONTAL SCALE 1" = 20'	BRIDGE FILE ALLEN 358
VERTICAL SCALE 1" = 5'	DESIGNATION 1902834
SURVEY BOOK ----	SHEETS 16 of 63
CONTRACT B-42844	PROJECT 1902834

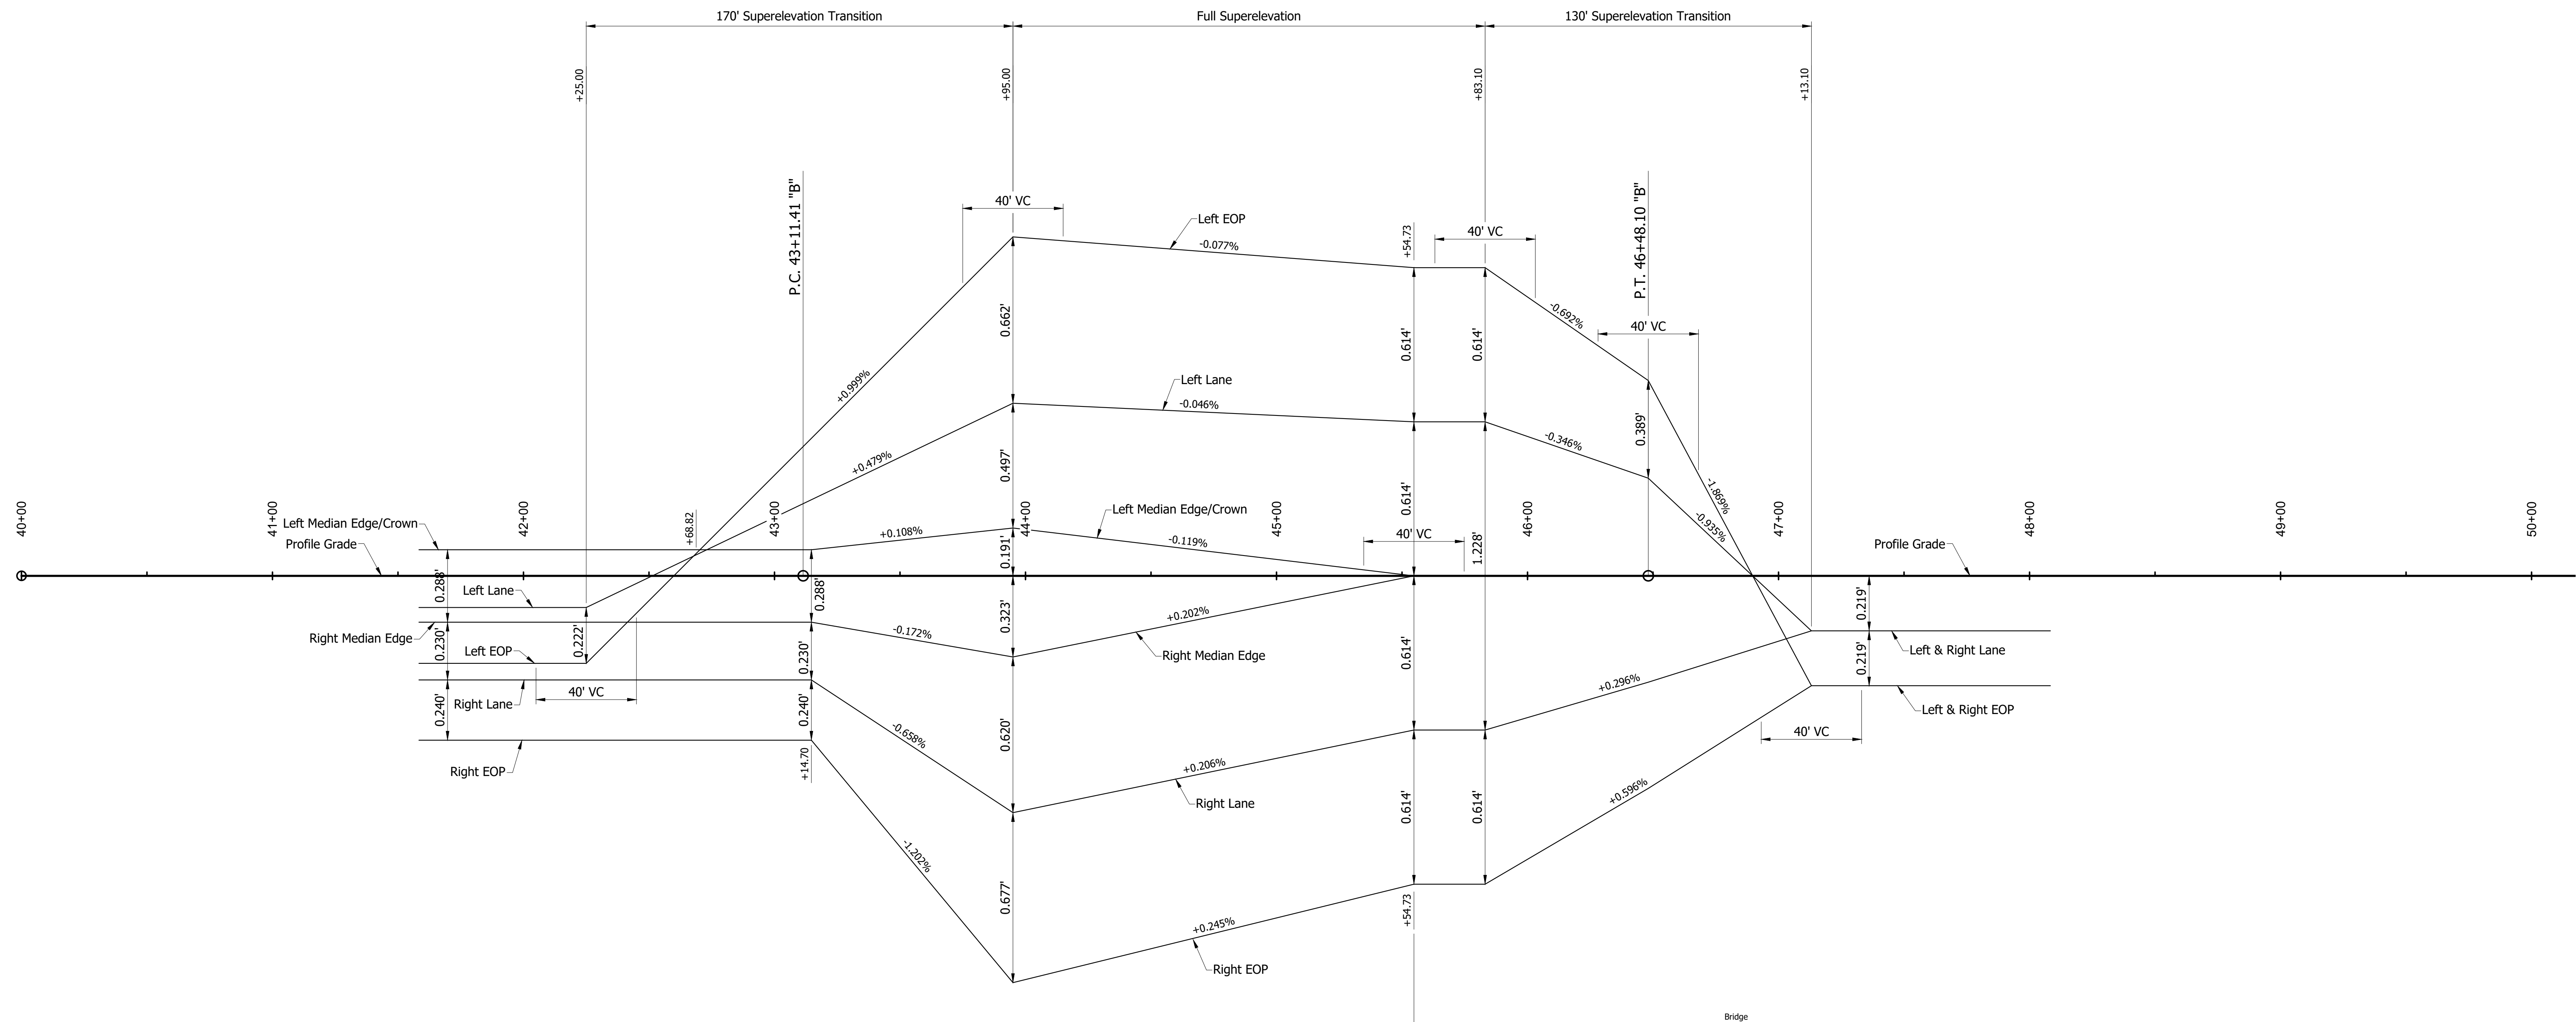


CURVE DATA
 P.I. 44+83.05 "B"
 $\Delta = 27^\circ 26' 52.0''$ Rt.
 R = 702.82'
 e = 5.58%
 Gmax = 0.62%

**NOT FOR
CONSTRUCTION**

DESIGNED: BMA DRAWN: CNC
 CHECKED: KAM CHECKED: BMA


INDIANA
 DEPARTMENT OF TRANSPORTATION
 SUPERELEVATION TRANSITION DIAGRAM
 LINE "B" - BLUFFTON ROAD

HORIZONTAL SCALE 1" = 30'	BRIDGE FILE ALLEN 358
VERTICAL SCALE 1" = 0.3'	DESIGNATION 1902834
SURVEY BOOK ----	SHEETS 17 of 63
CONTRACT B-42844	PROJECT 1902834

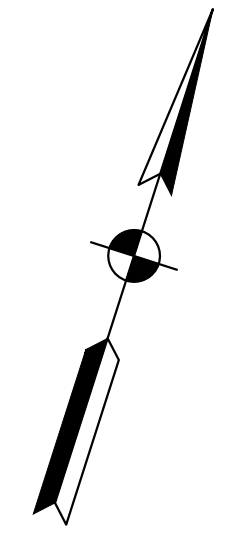

END CONSTRUCTION
STA. 11+56.23 "S-3-B"

CURVE DATA
 P.I. 44+83.05 "B"
 $\Delta = 27^\circ 26' 52.0''$ Rt.
 R = 702.82'
 T = 171.64'
 L = 336.69'
 E = 20.66'

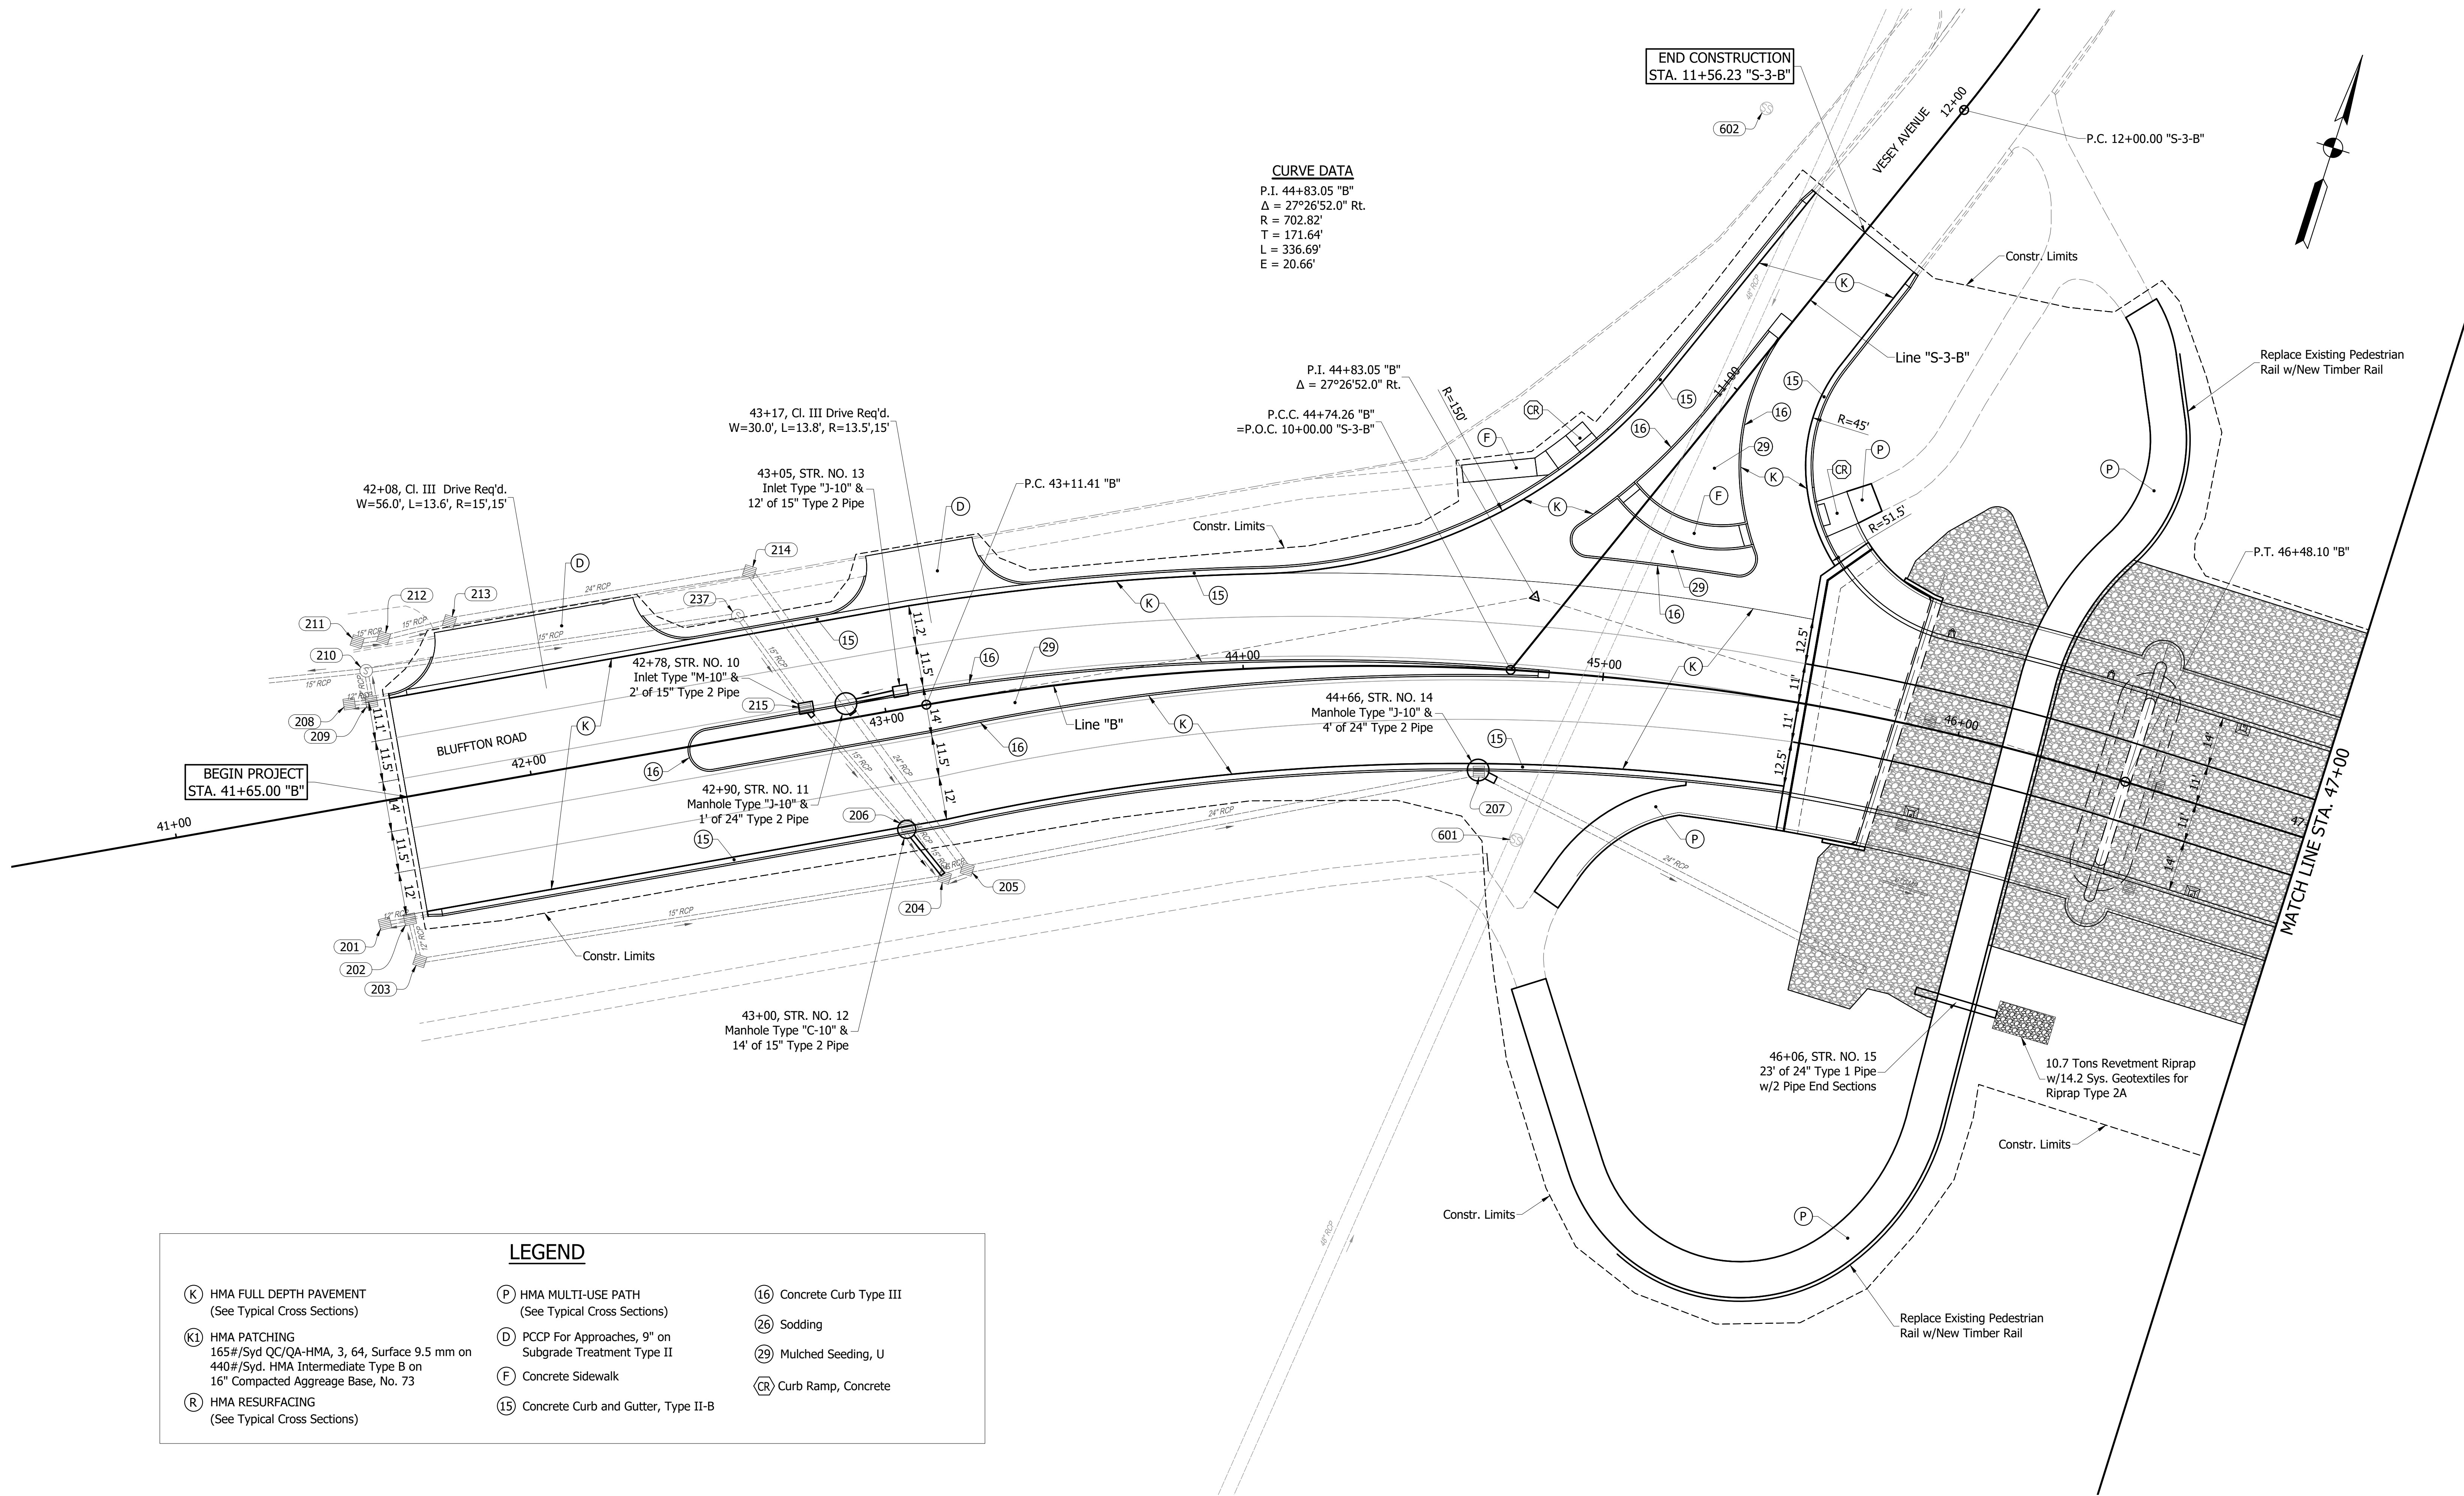

BEGIN PROJECT
STA. 41+65.00 "B"

MATCH LINE STA. 47+00

LEGEND

- | | | |
|---|--|-----------------------------|
| (K) HMA FULL DEPTH PAVEMENT
(See Typical Cross Sections) | (P) HMA MULTI-USE PATH
(See Typical Cross Sections) | (16) Concrete Curb Type III |
| (KI) HMA PATCHING
165#/Syd QC/QA-HMA, 3, 64, Surface 9.5 mm on
440#/Syd. HMA Intermediate Type B on
16" Compacted Aggregate Base, No. 73 | (D) PCCP For Approaches, 9" on
Subgrade Treatment Type II | (26) Sodding |
| (R) HMA RESURFACING
(See Typical Cross Sections) | (F) Concrete Sidewalk | (29) Mulched Seeding, U |
| | (15) Concrete Curb and Gutter, Type II-B | (CR) Curb Ramp, Concrete |



NOT FOR
CONSTRUCTION


DESIGNED: BMA	DRAWN: CNC
CHECKED: KAM	CHECKED: BMA

INDIANA
DEPARTMENT OF TRANSPORTATION

CONSTRUCTION DETAILS
LINE "B" - BLUFFTON ROAD

HORIZONTAL SCALE 1" = 20'	BRIDGE FILE ALLEN 358
VERTICAL SCALE N/A	DESIGNATION 1902834
SURVEY BOOK ---	SHEETS 18 of 63
CONTRACT B-42844	PROJECT 1902834

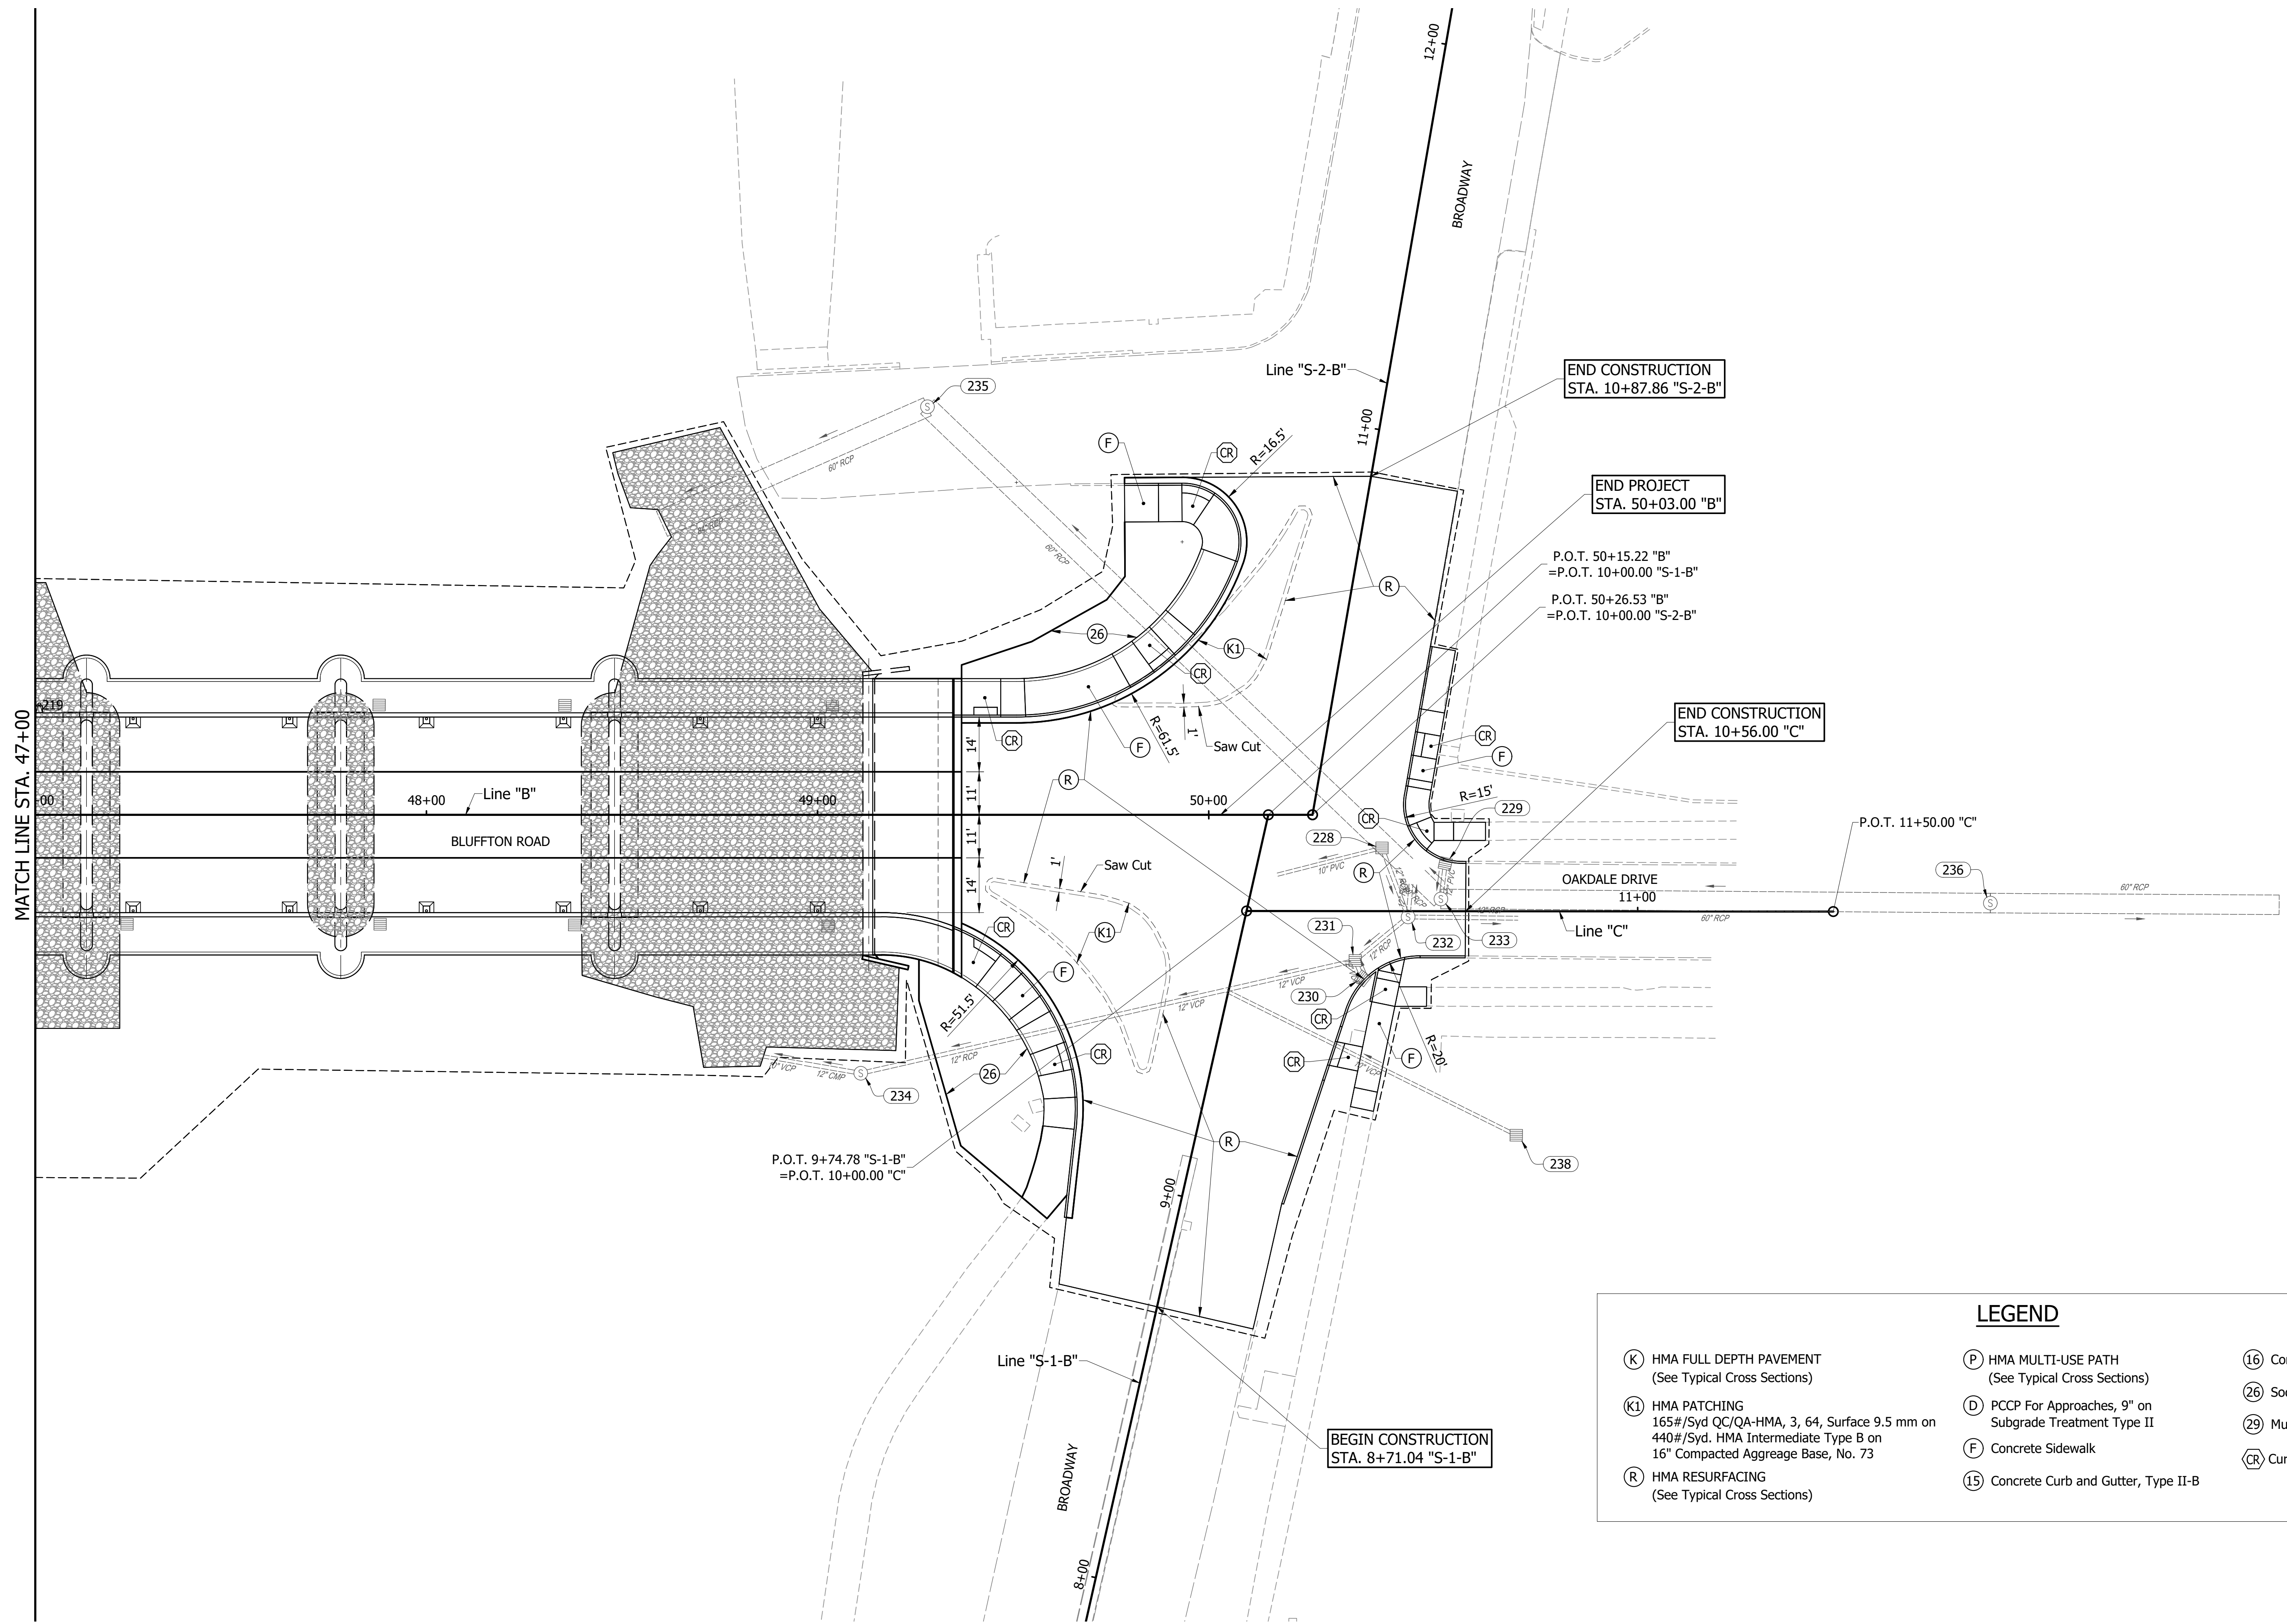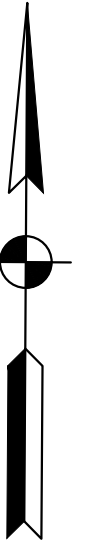


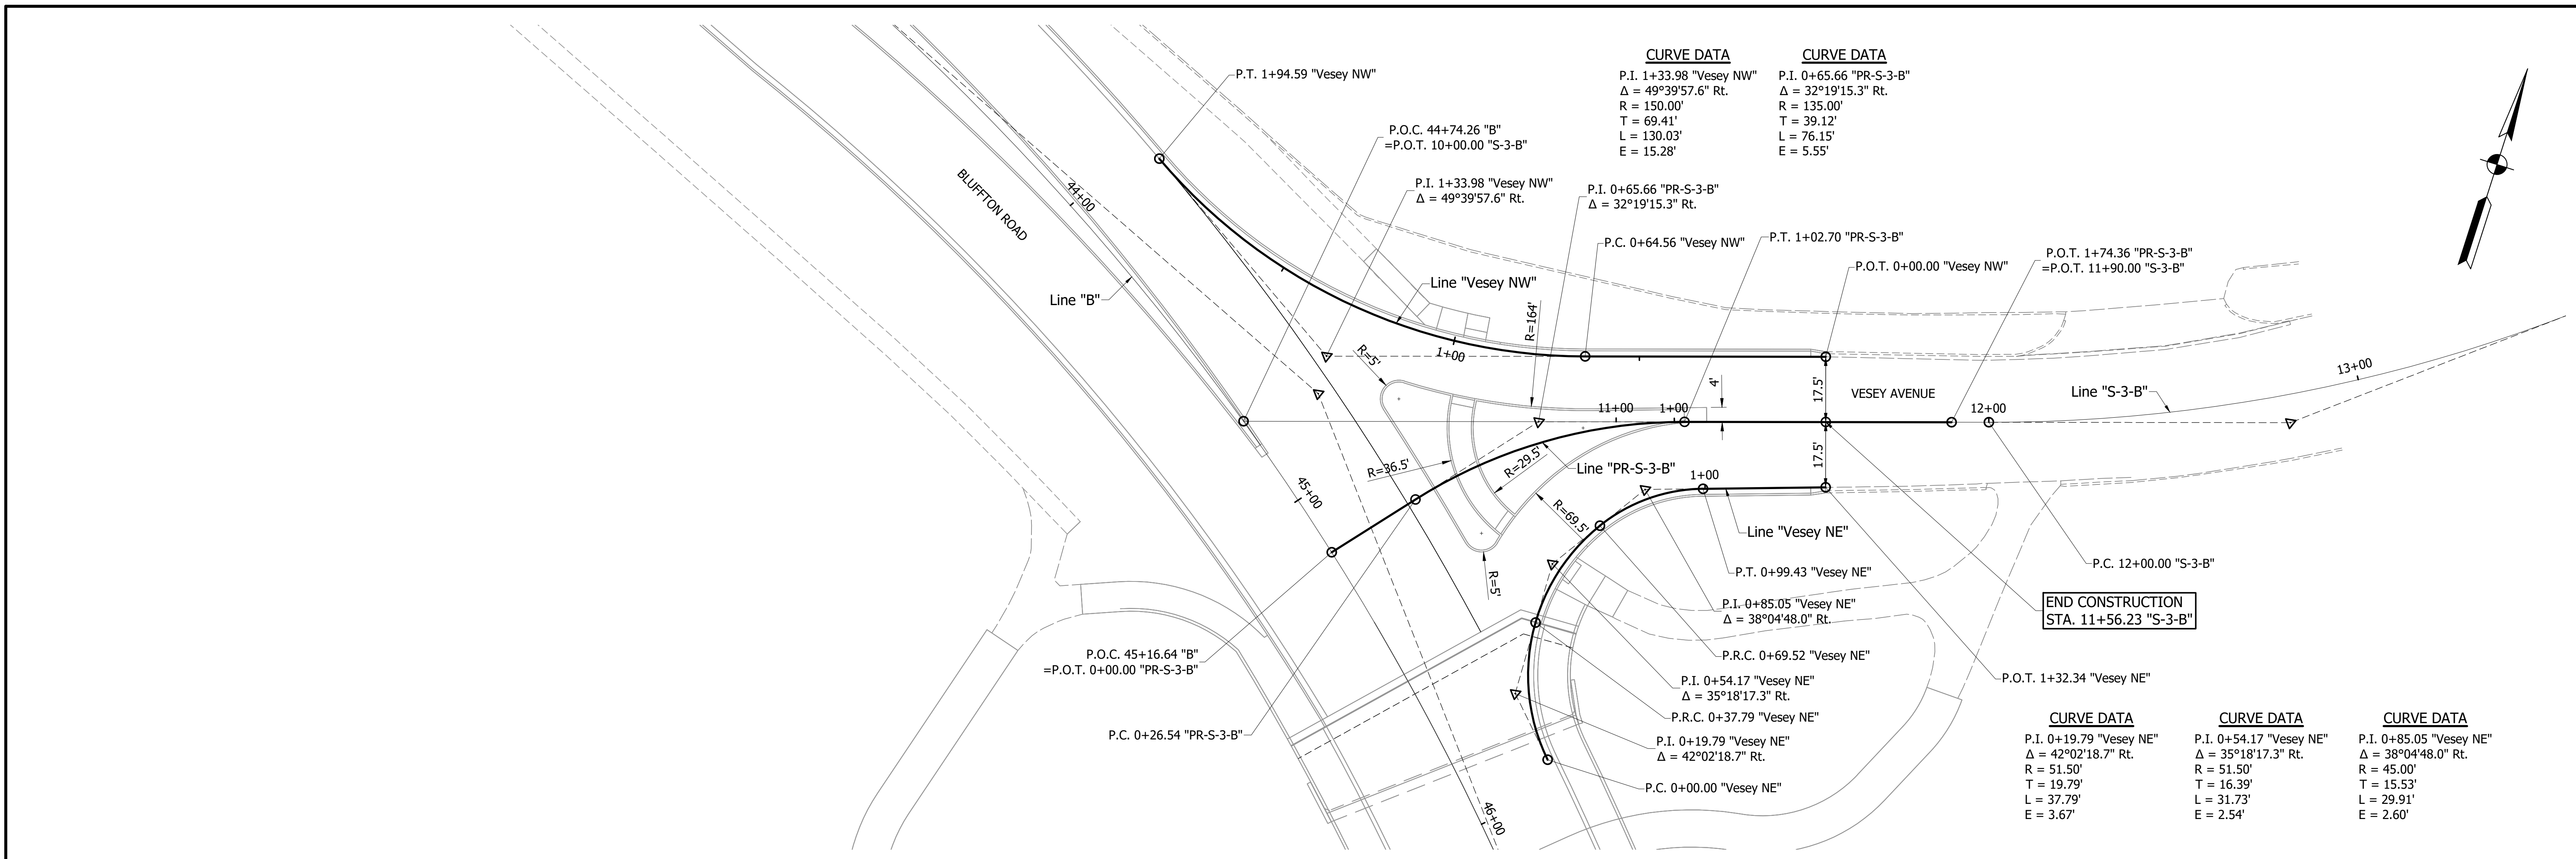


CURVE DATA	CURVE DATA
P.I. 1+33.98 "Vesey NW" Δ = 49°39'57.6" Rt. R = 150.00' T = 69.41' L = 130.03' E = 15.28'	P.I. 0+65.66 "PR-S-3-B" Δ = 32°19'15.3" Rt. R = 135.00' T = 39.12' L = 76.15' E = 5.55'

CURVE DATA	CURVE DATA	CURVE DATA
P.I. 0+19.79 "Vesey NE" Δ = 42°02'18.7" Rt. R = 51.50' T = 19.79' L = 37.79' E = 3.67'	P.I. 0+54.17 "Vesey NE" Δ = 35°18'17.3" Rt. R = 51.50' T = 16.39' L = 31.73' E = 2.54'	P.I. 0+85.05 "Vesey NE" Δ = 38°04'48.0" Rt. R = 45.00' T = 15.53' L = 29.91' E = 2.60'


Vesey NW

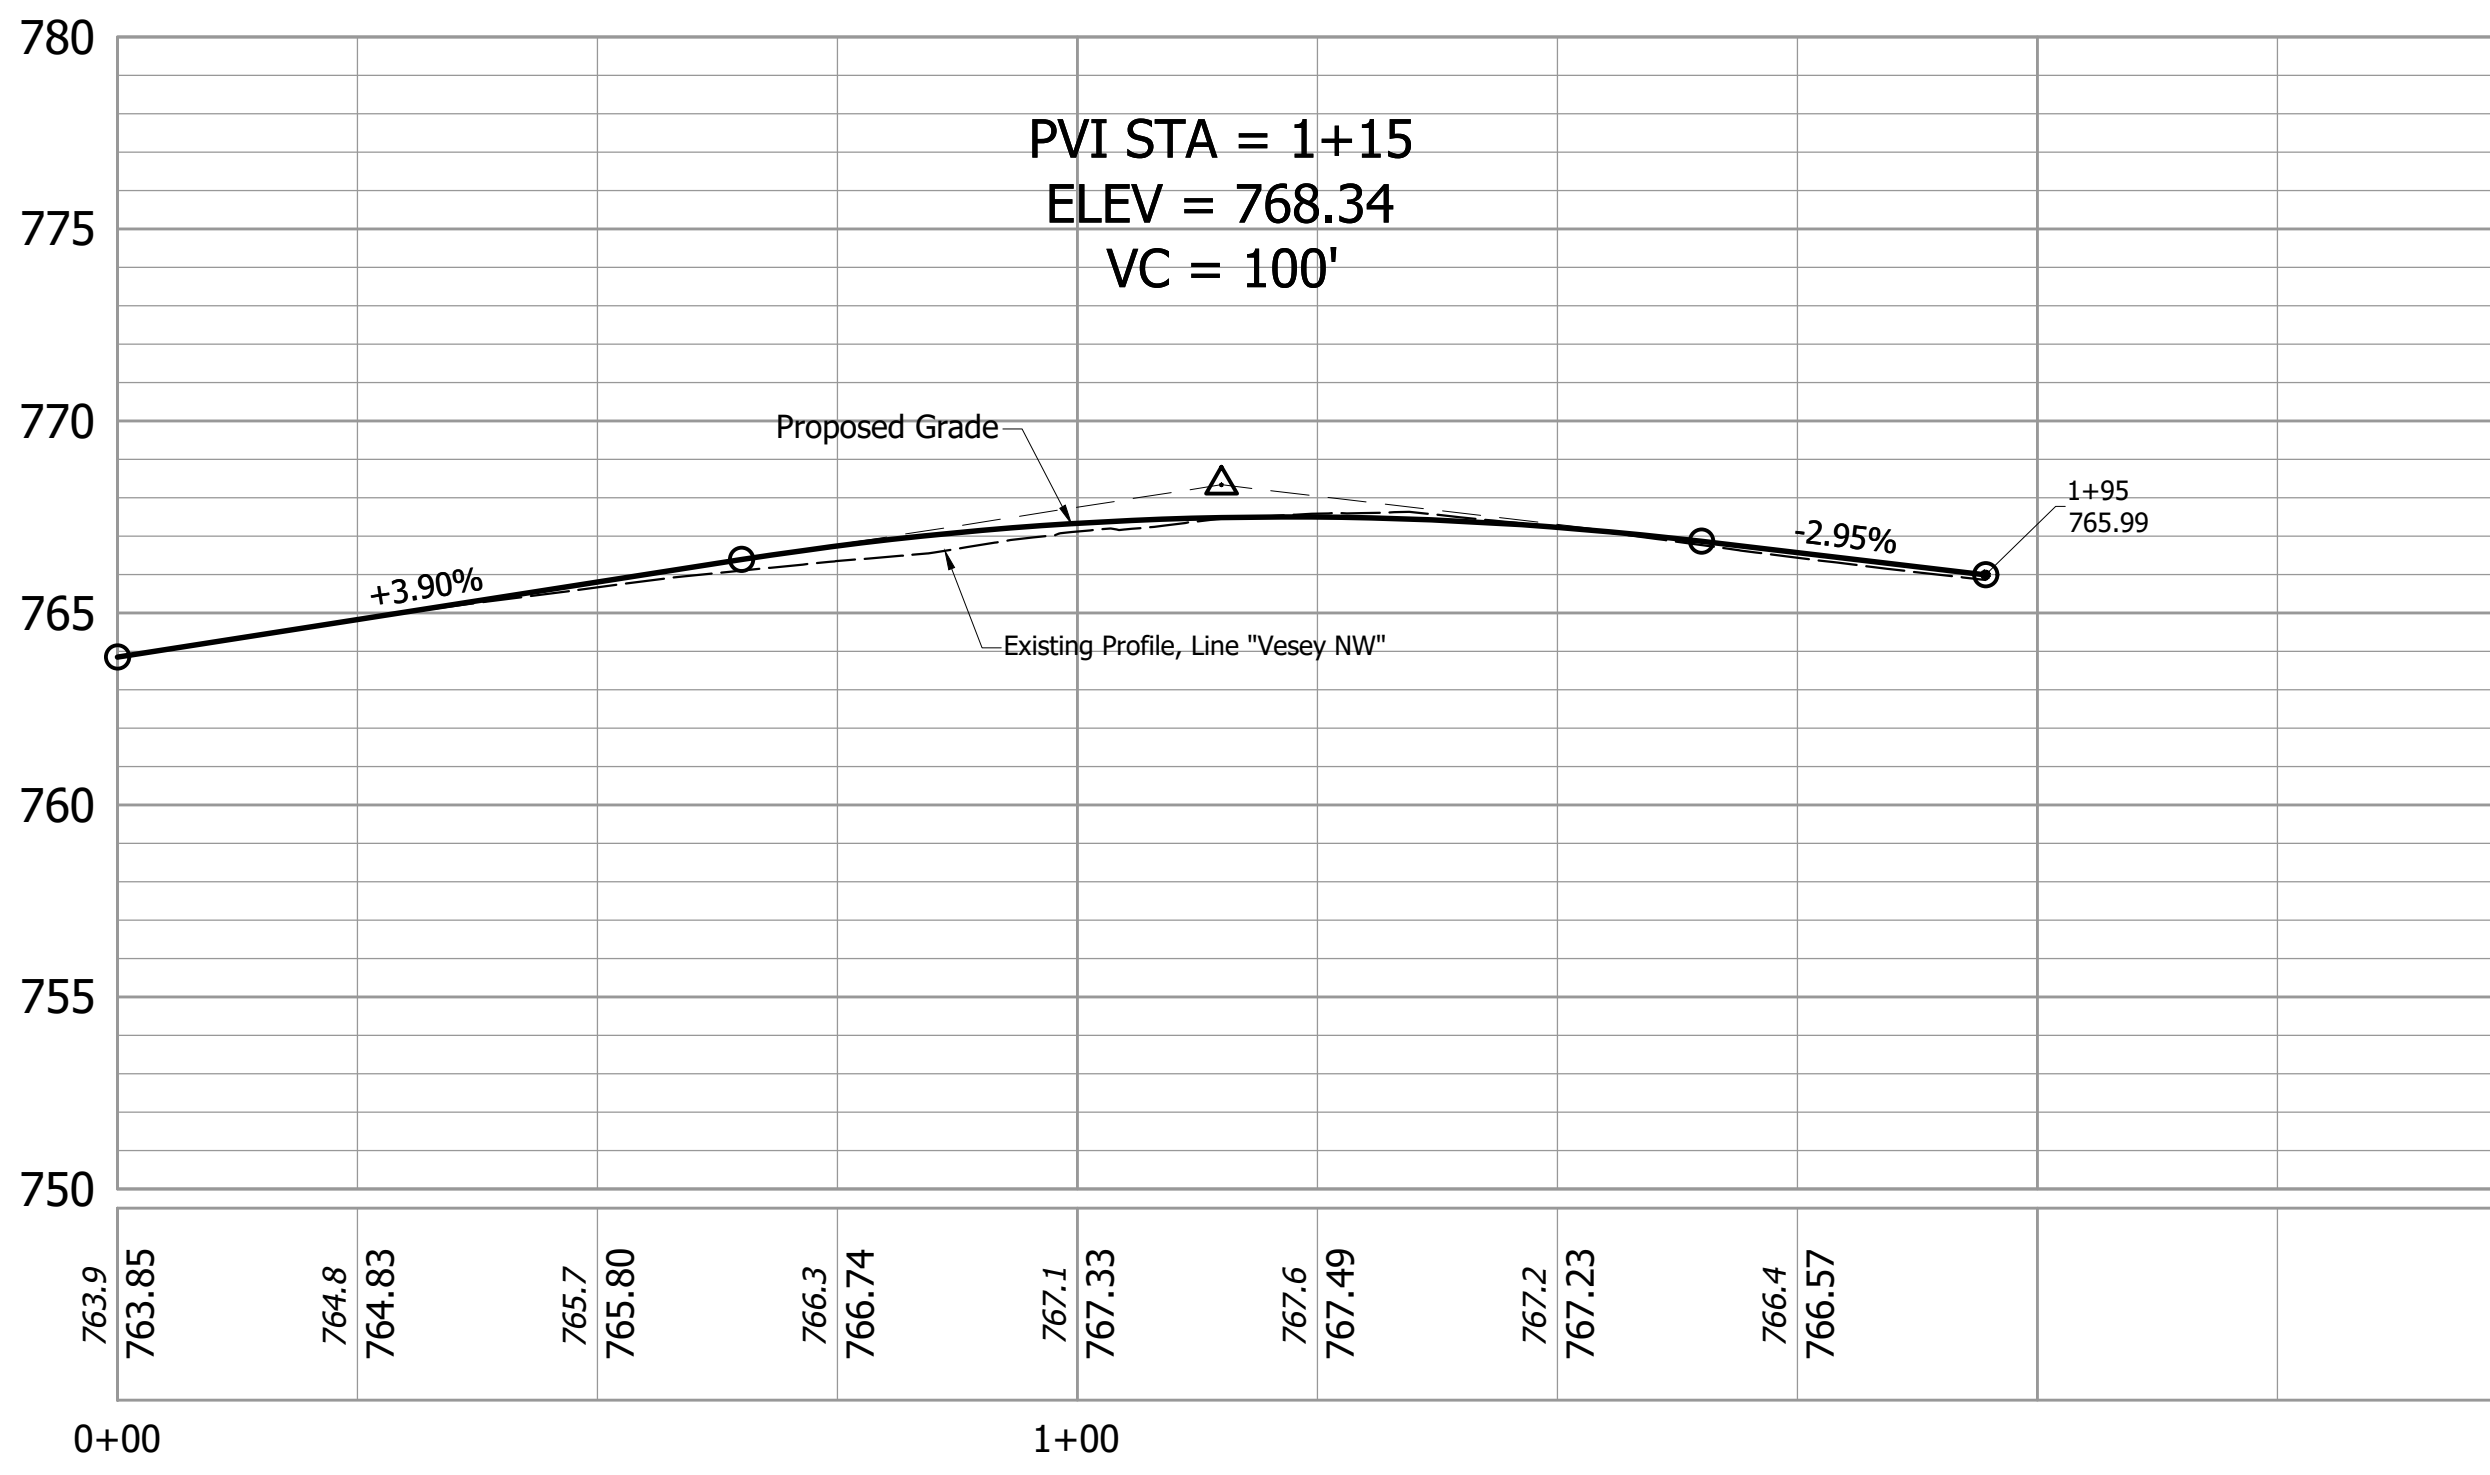

PR-S-3-B

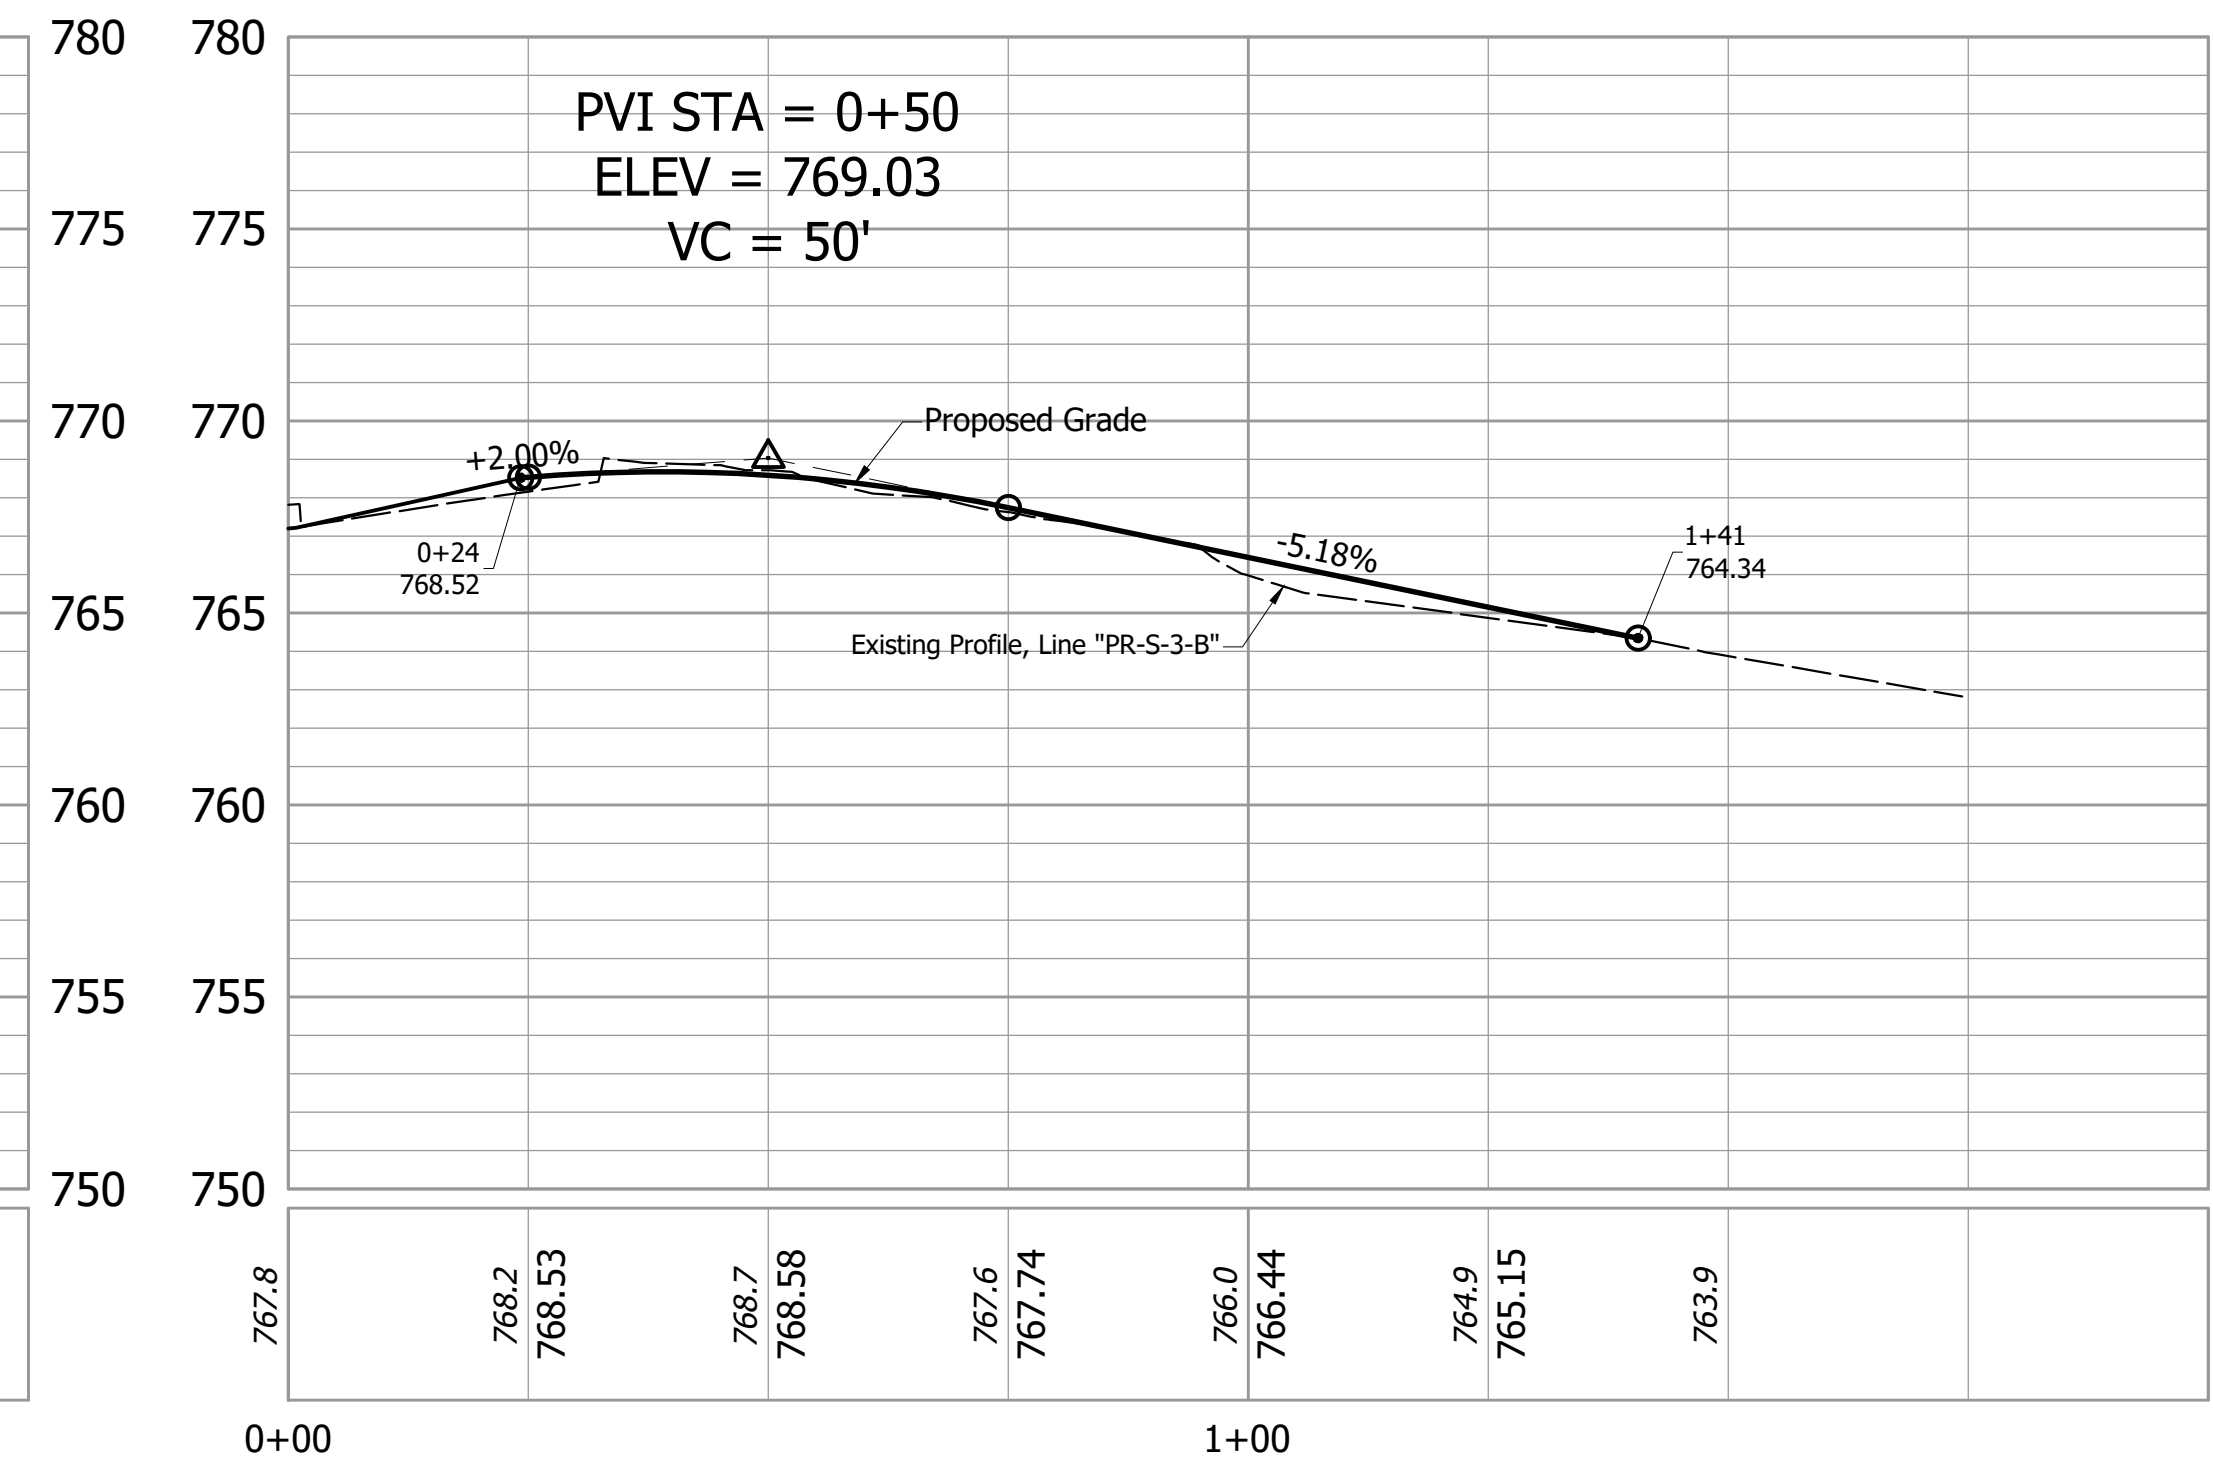

Vesey NE

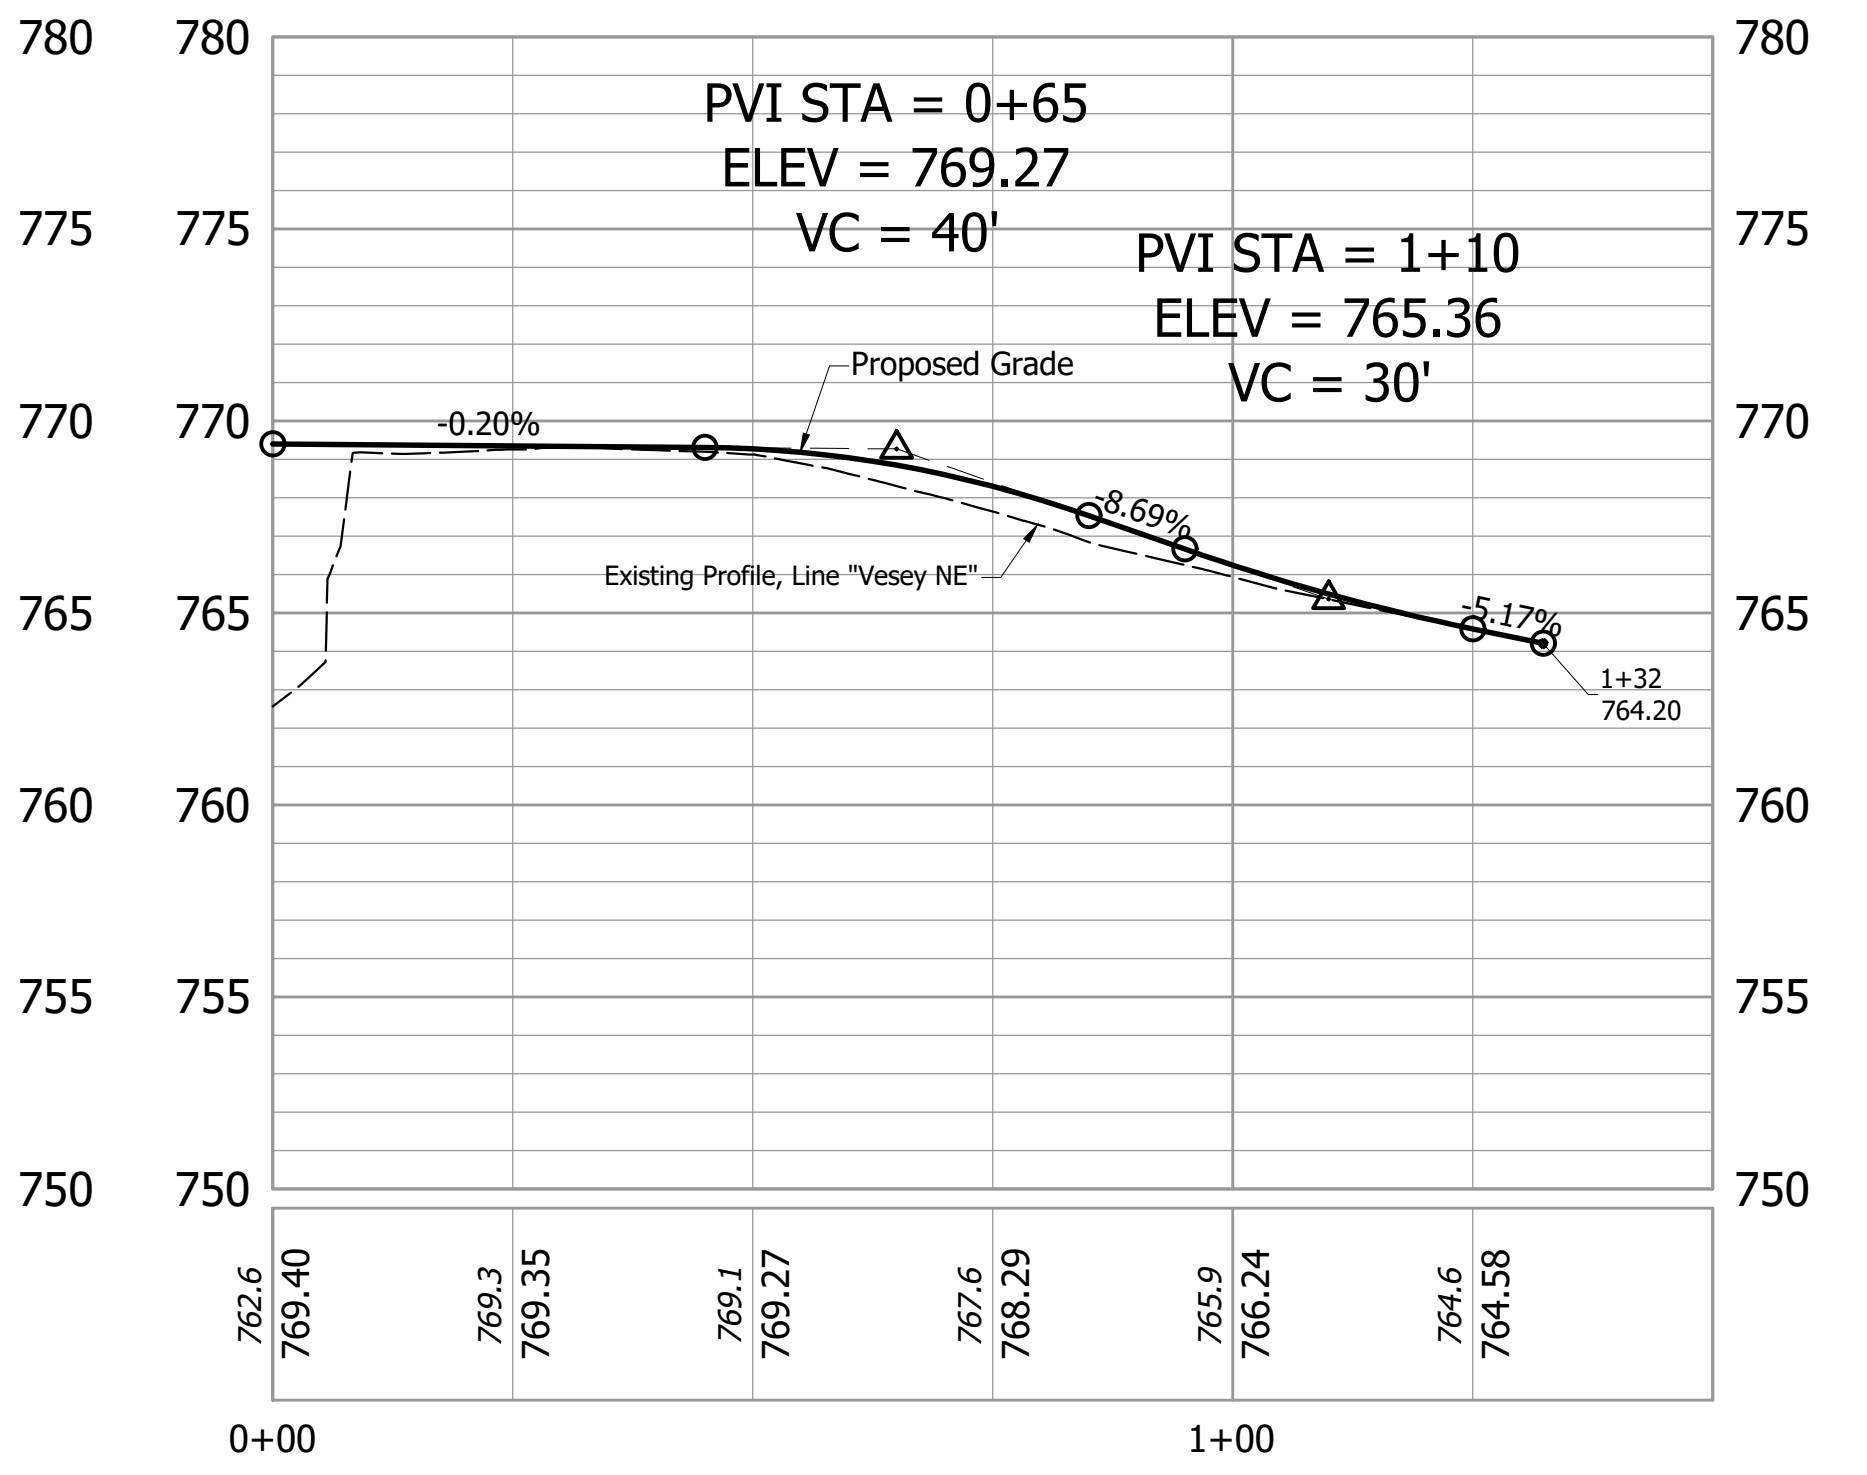







NOT FOR CONSTRUCTION

DESIGNED: BMA	DRAWN: CNC
CHECKED: KAM	CHECKED: BMA

INDIANA
DEPARTMENT OF TRANSPORTATION

INTERSECTION DETAILS
BLUFFTON RD / BROADWAY

HORIZONTAL SCALE 1" = 20'	BRIDGE FILE ALLEN 358
VERTICAL SCALE N/A	DESIGNATION 1902834
SURVEY BOOK ----	SHEETS 20 of 63
CONTRACT B-42844	PROJECT 1902834

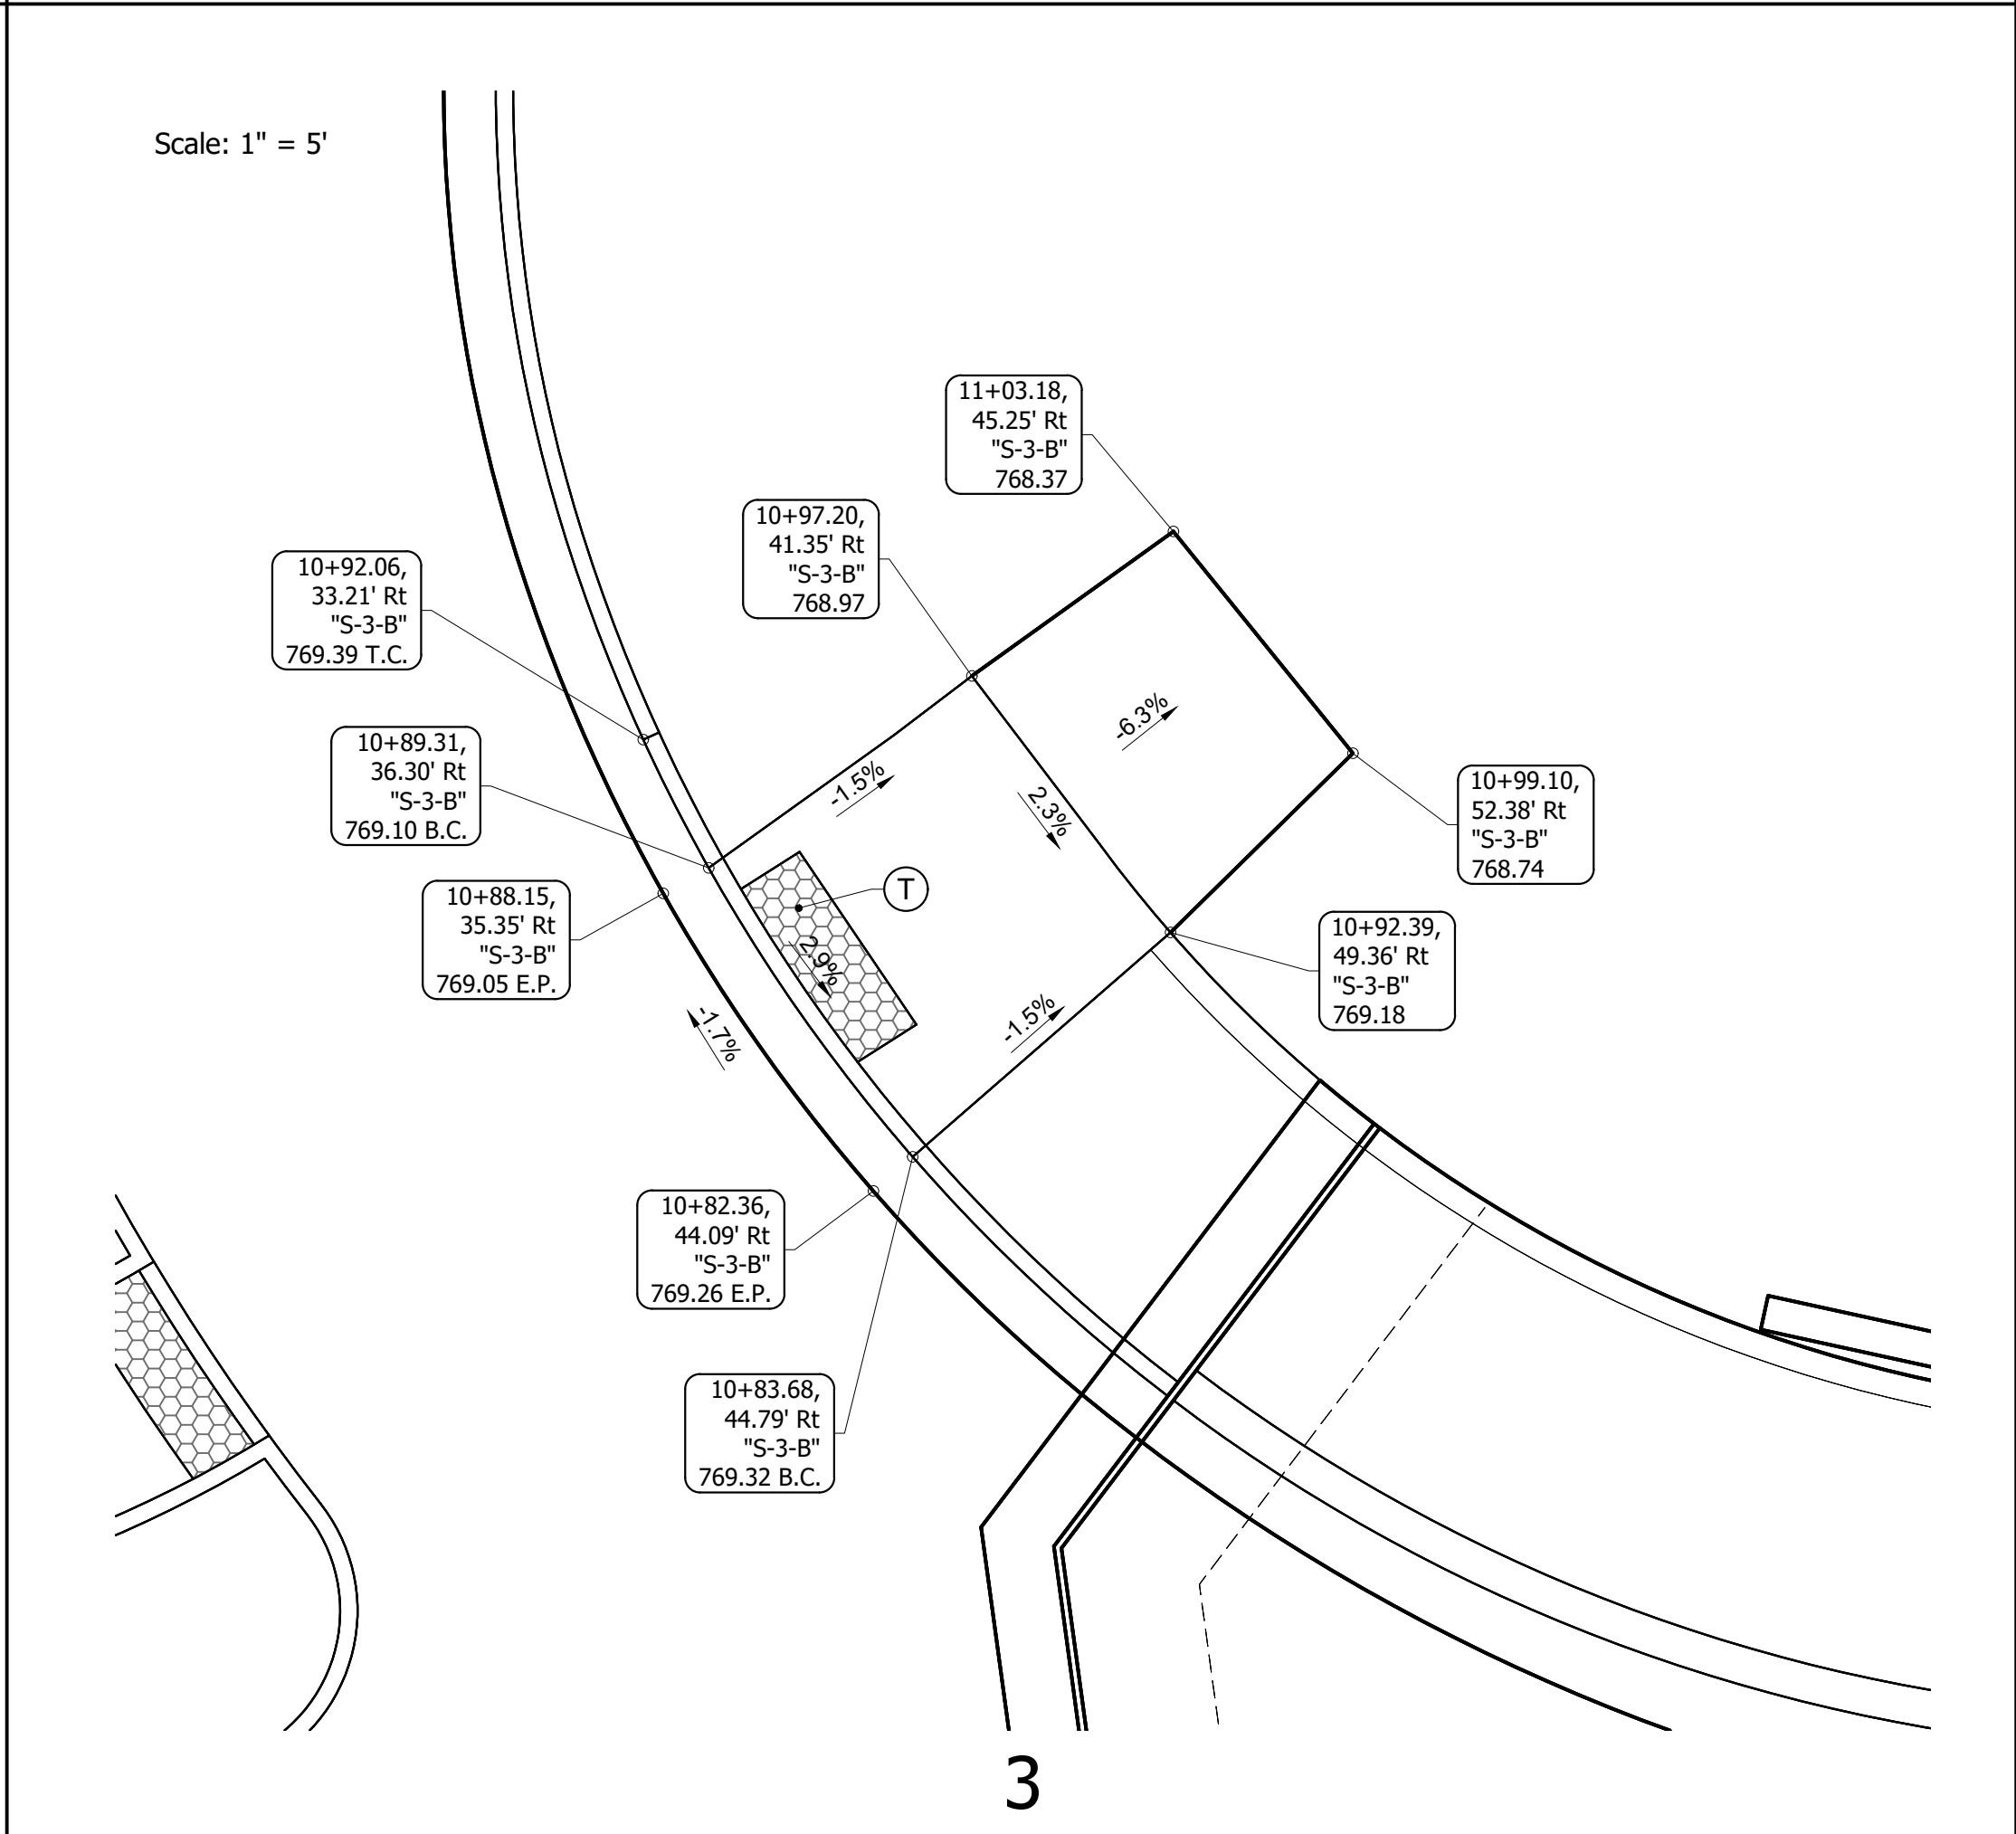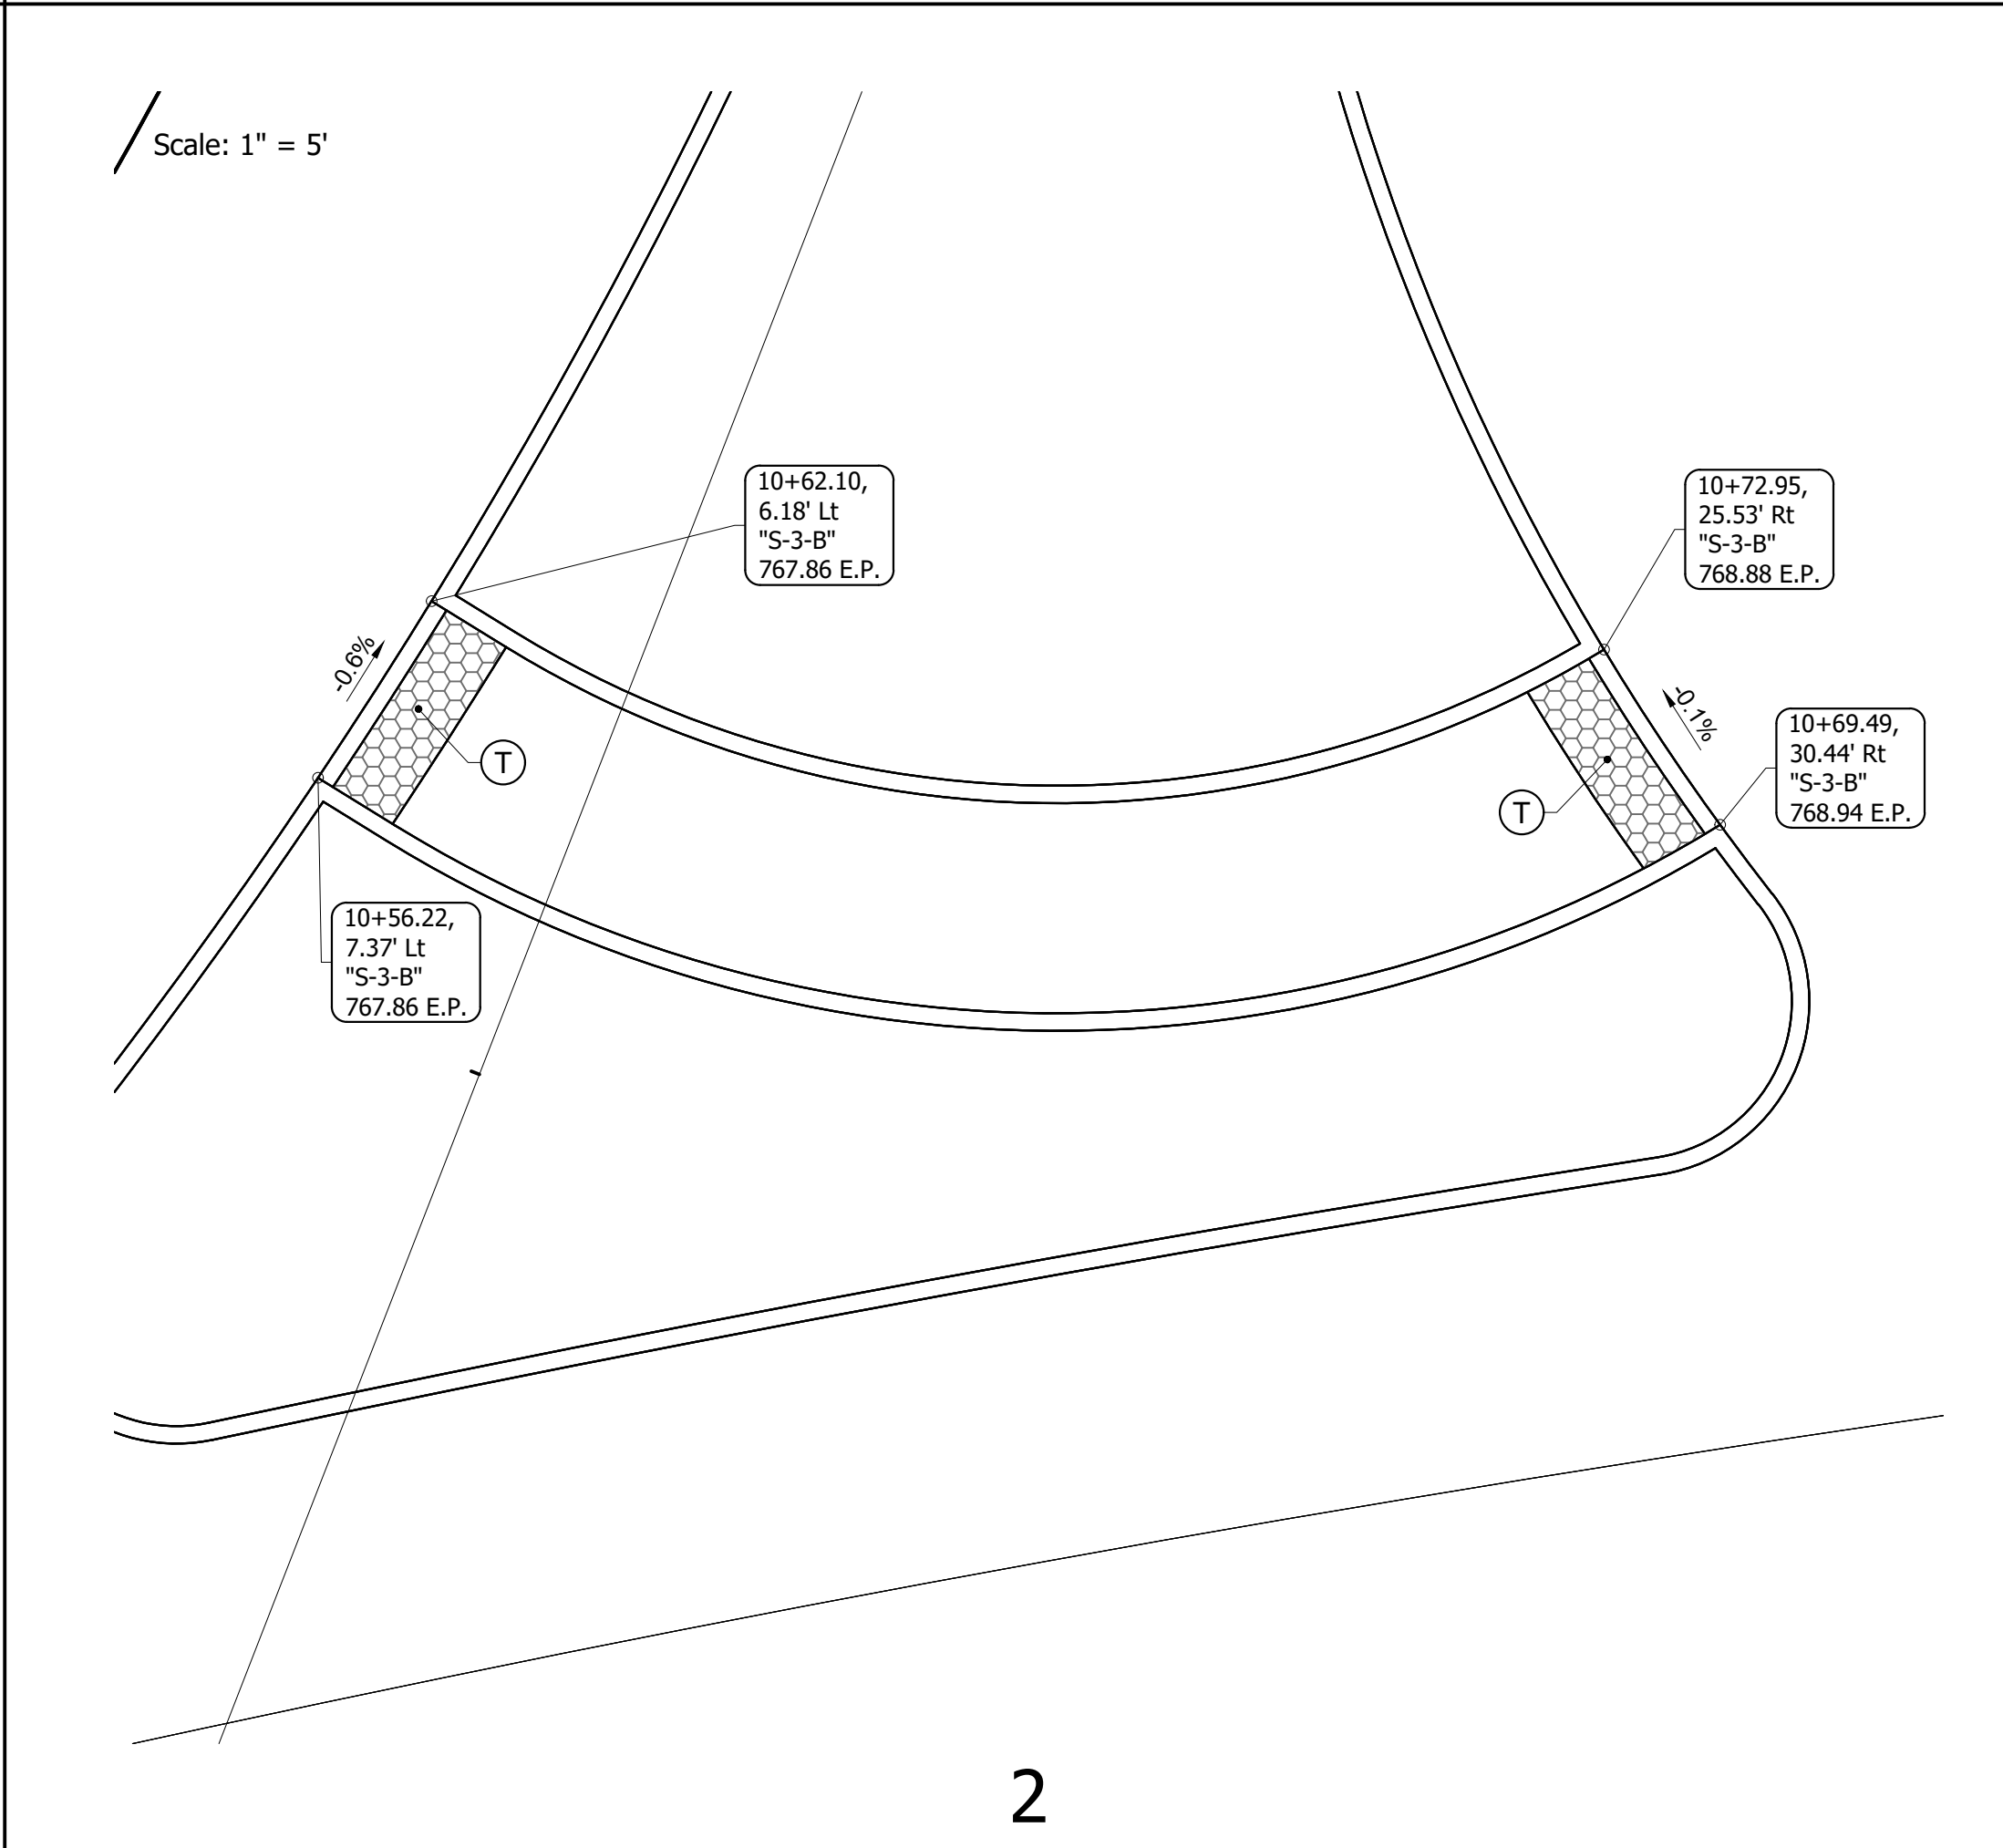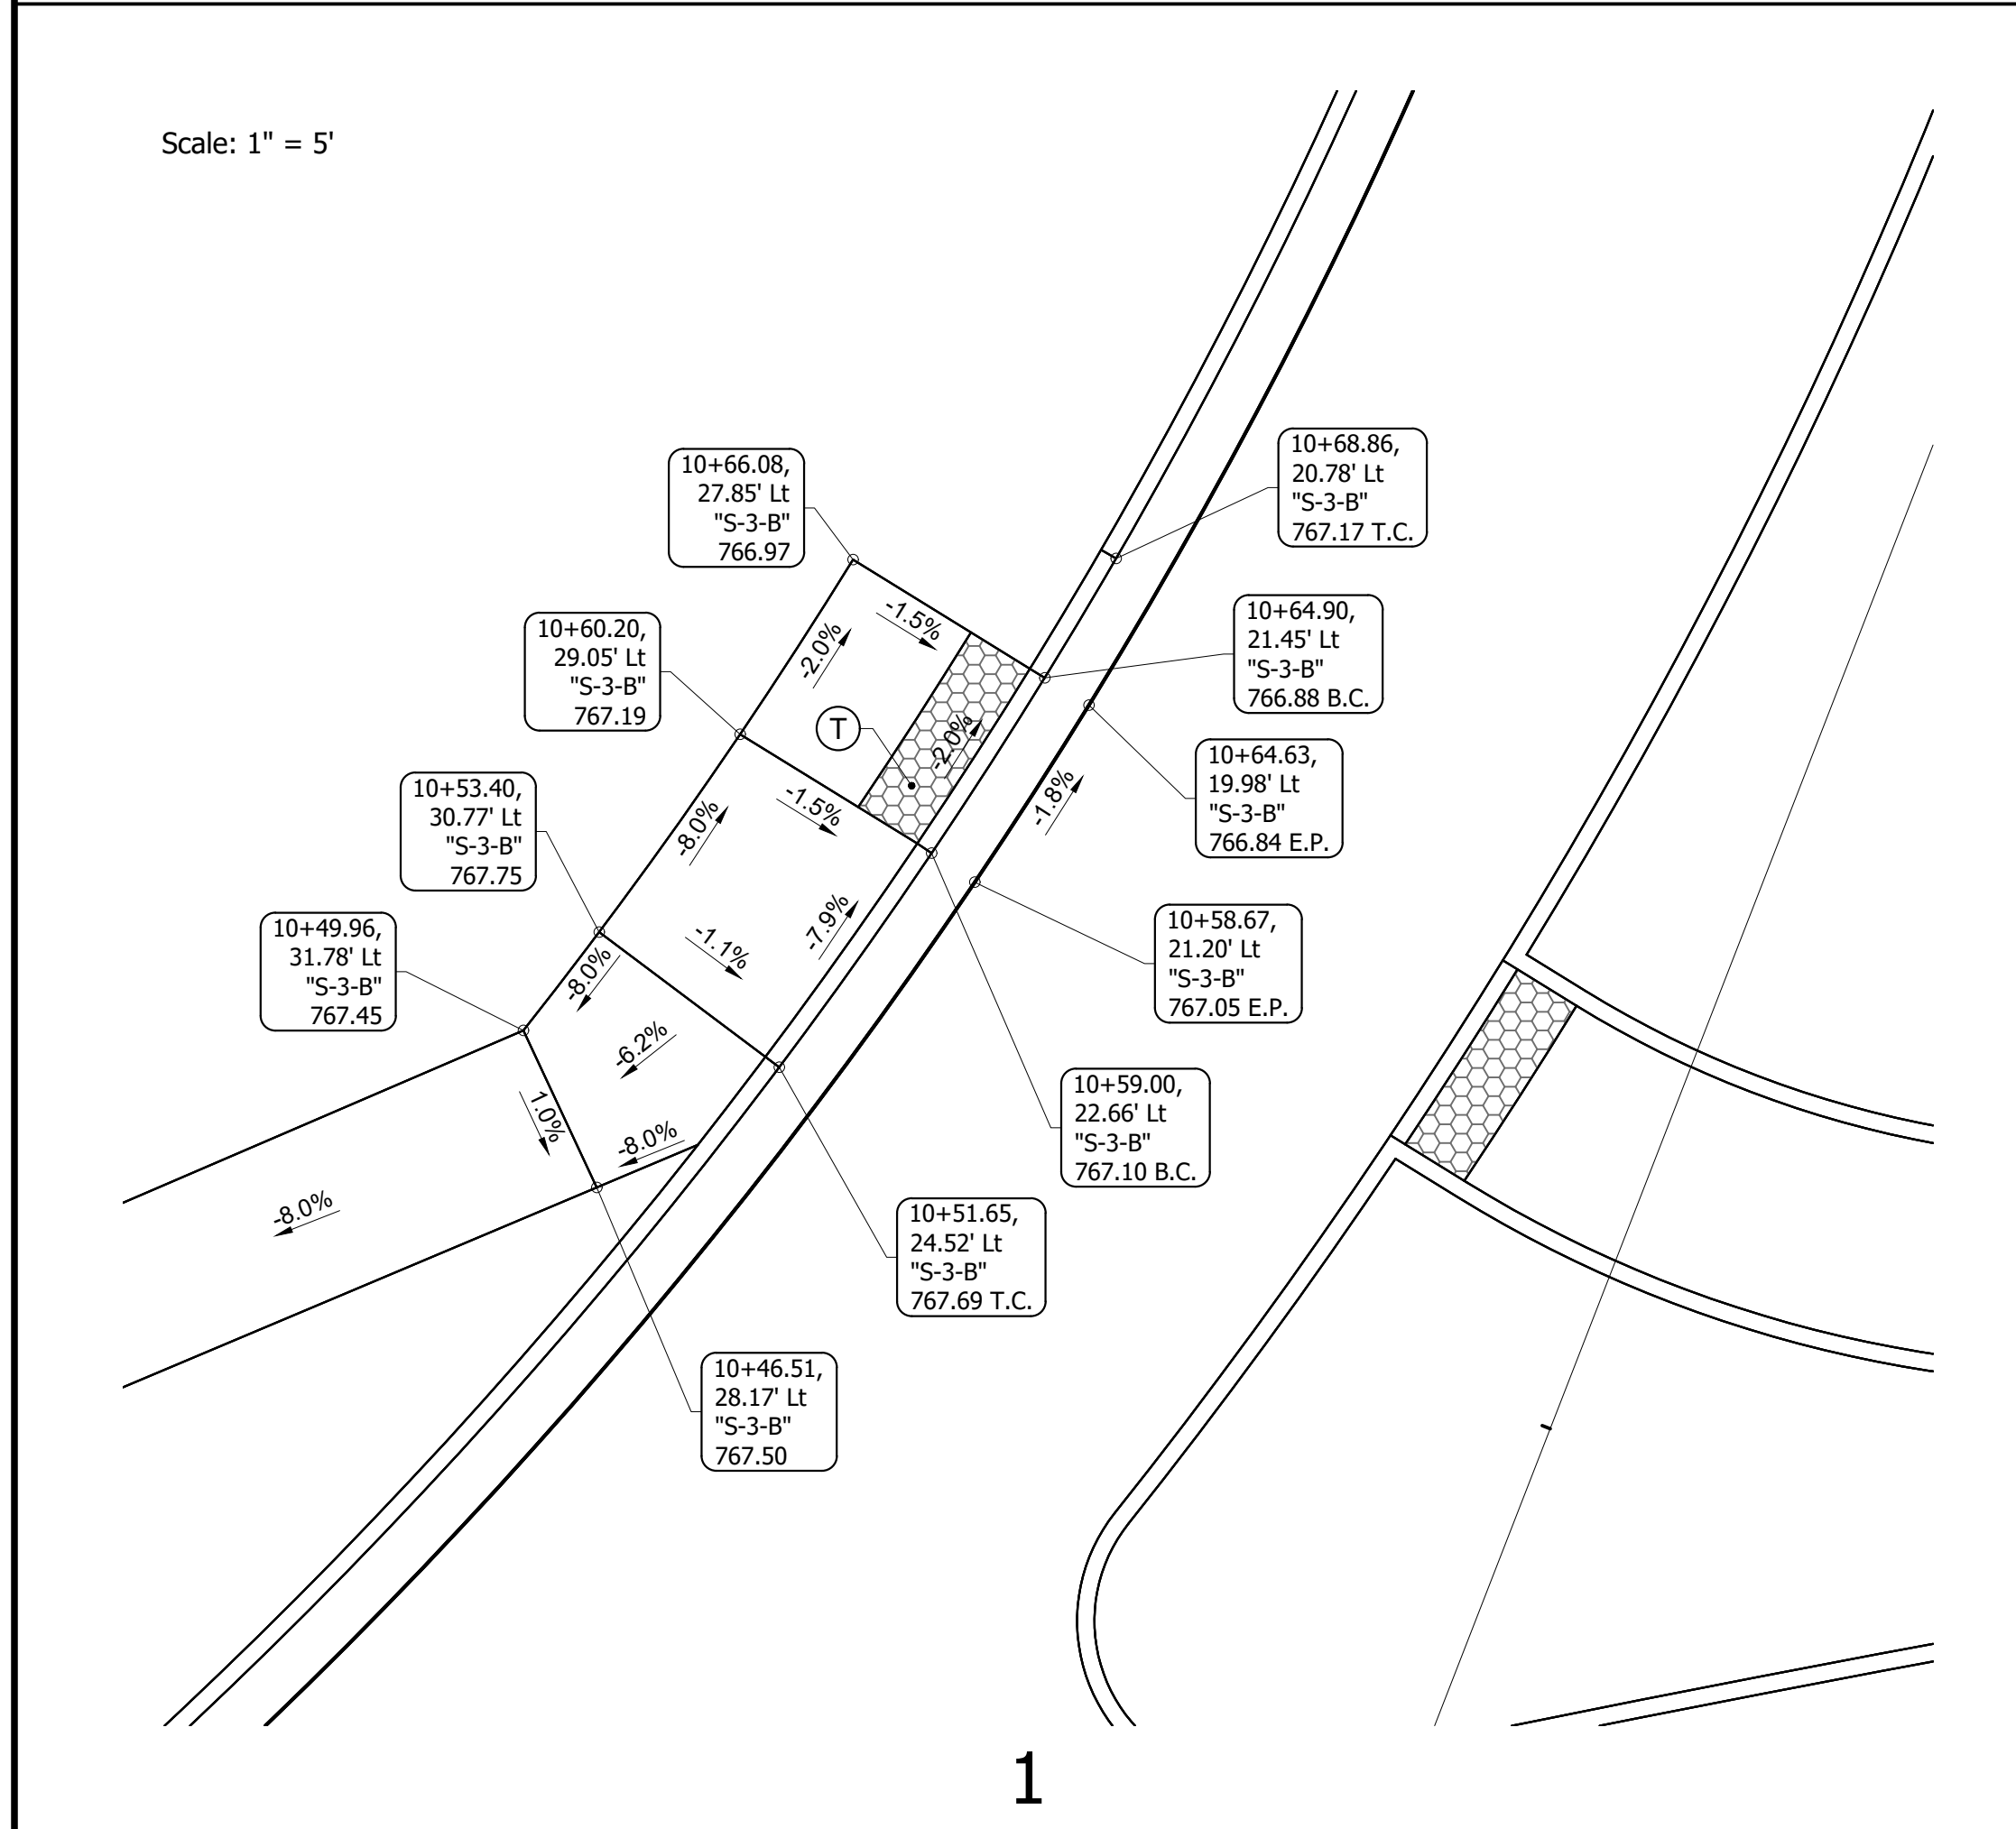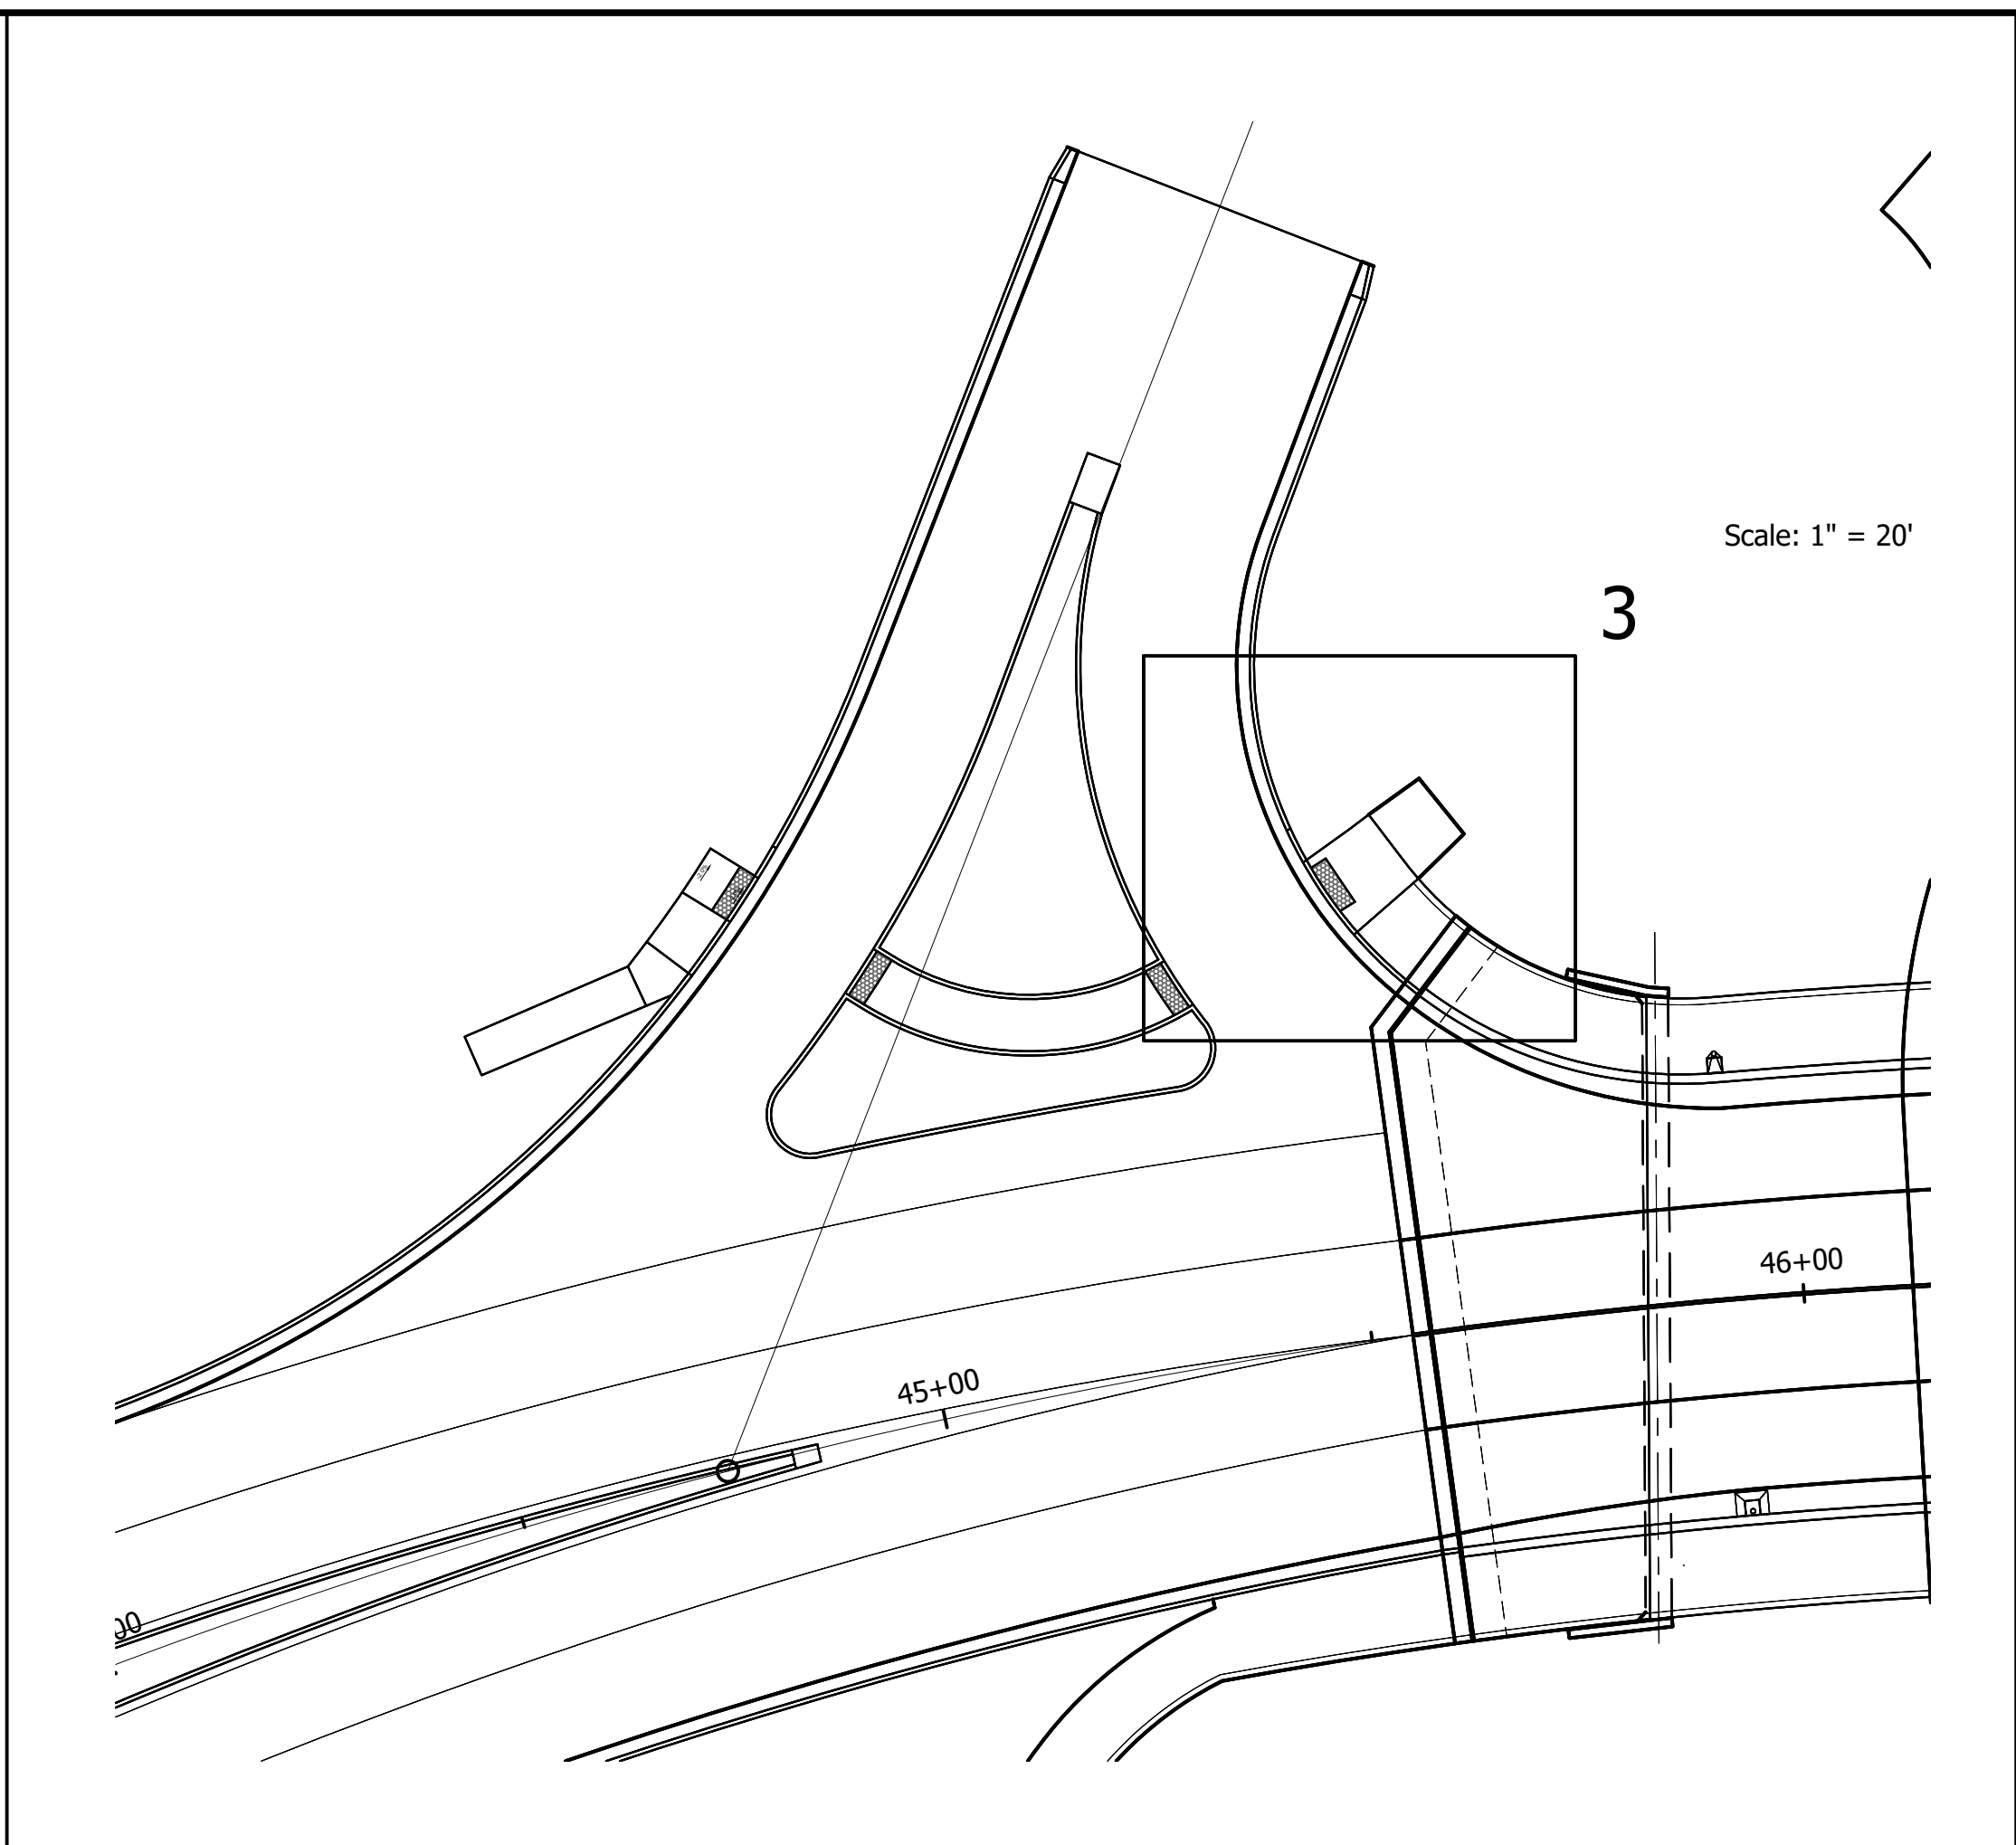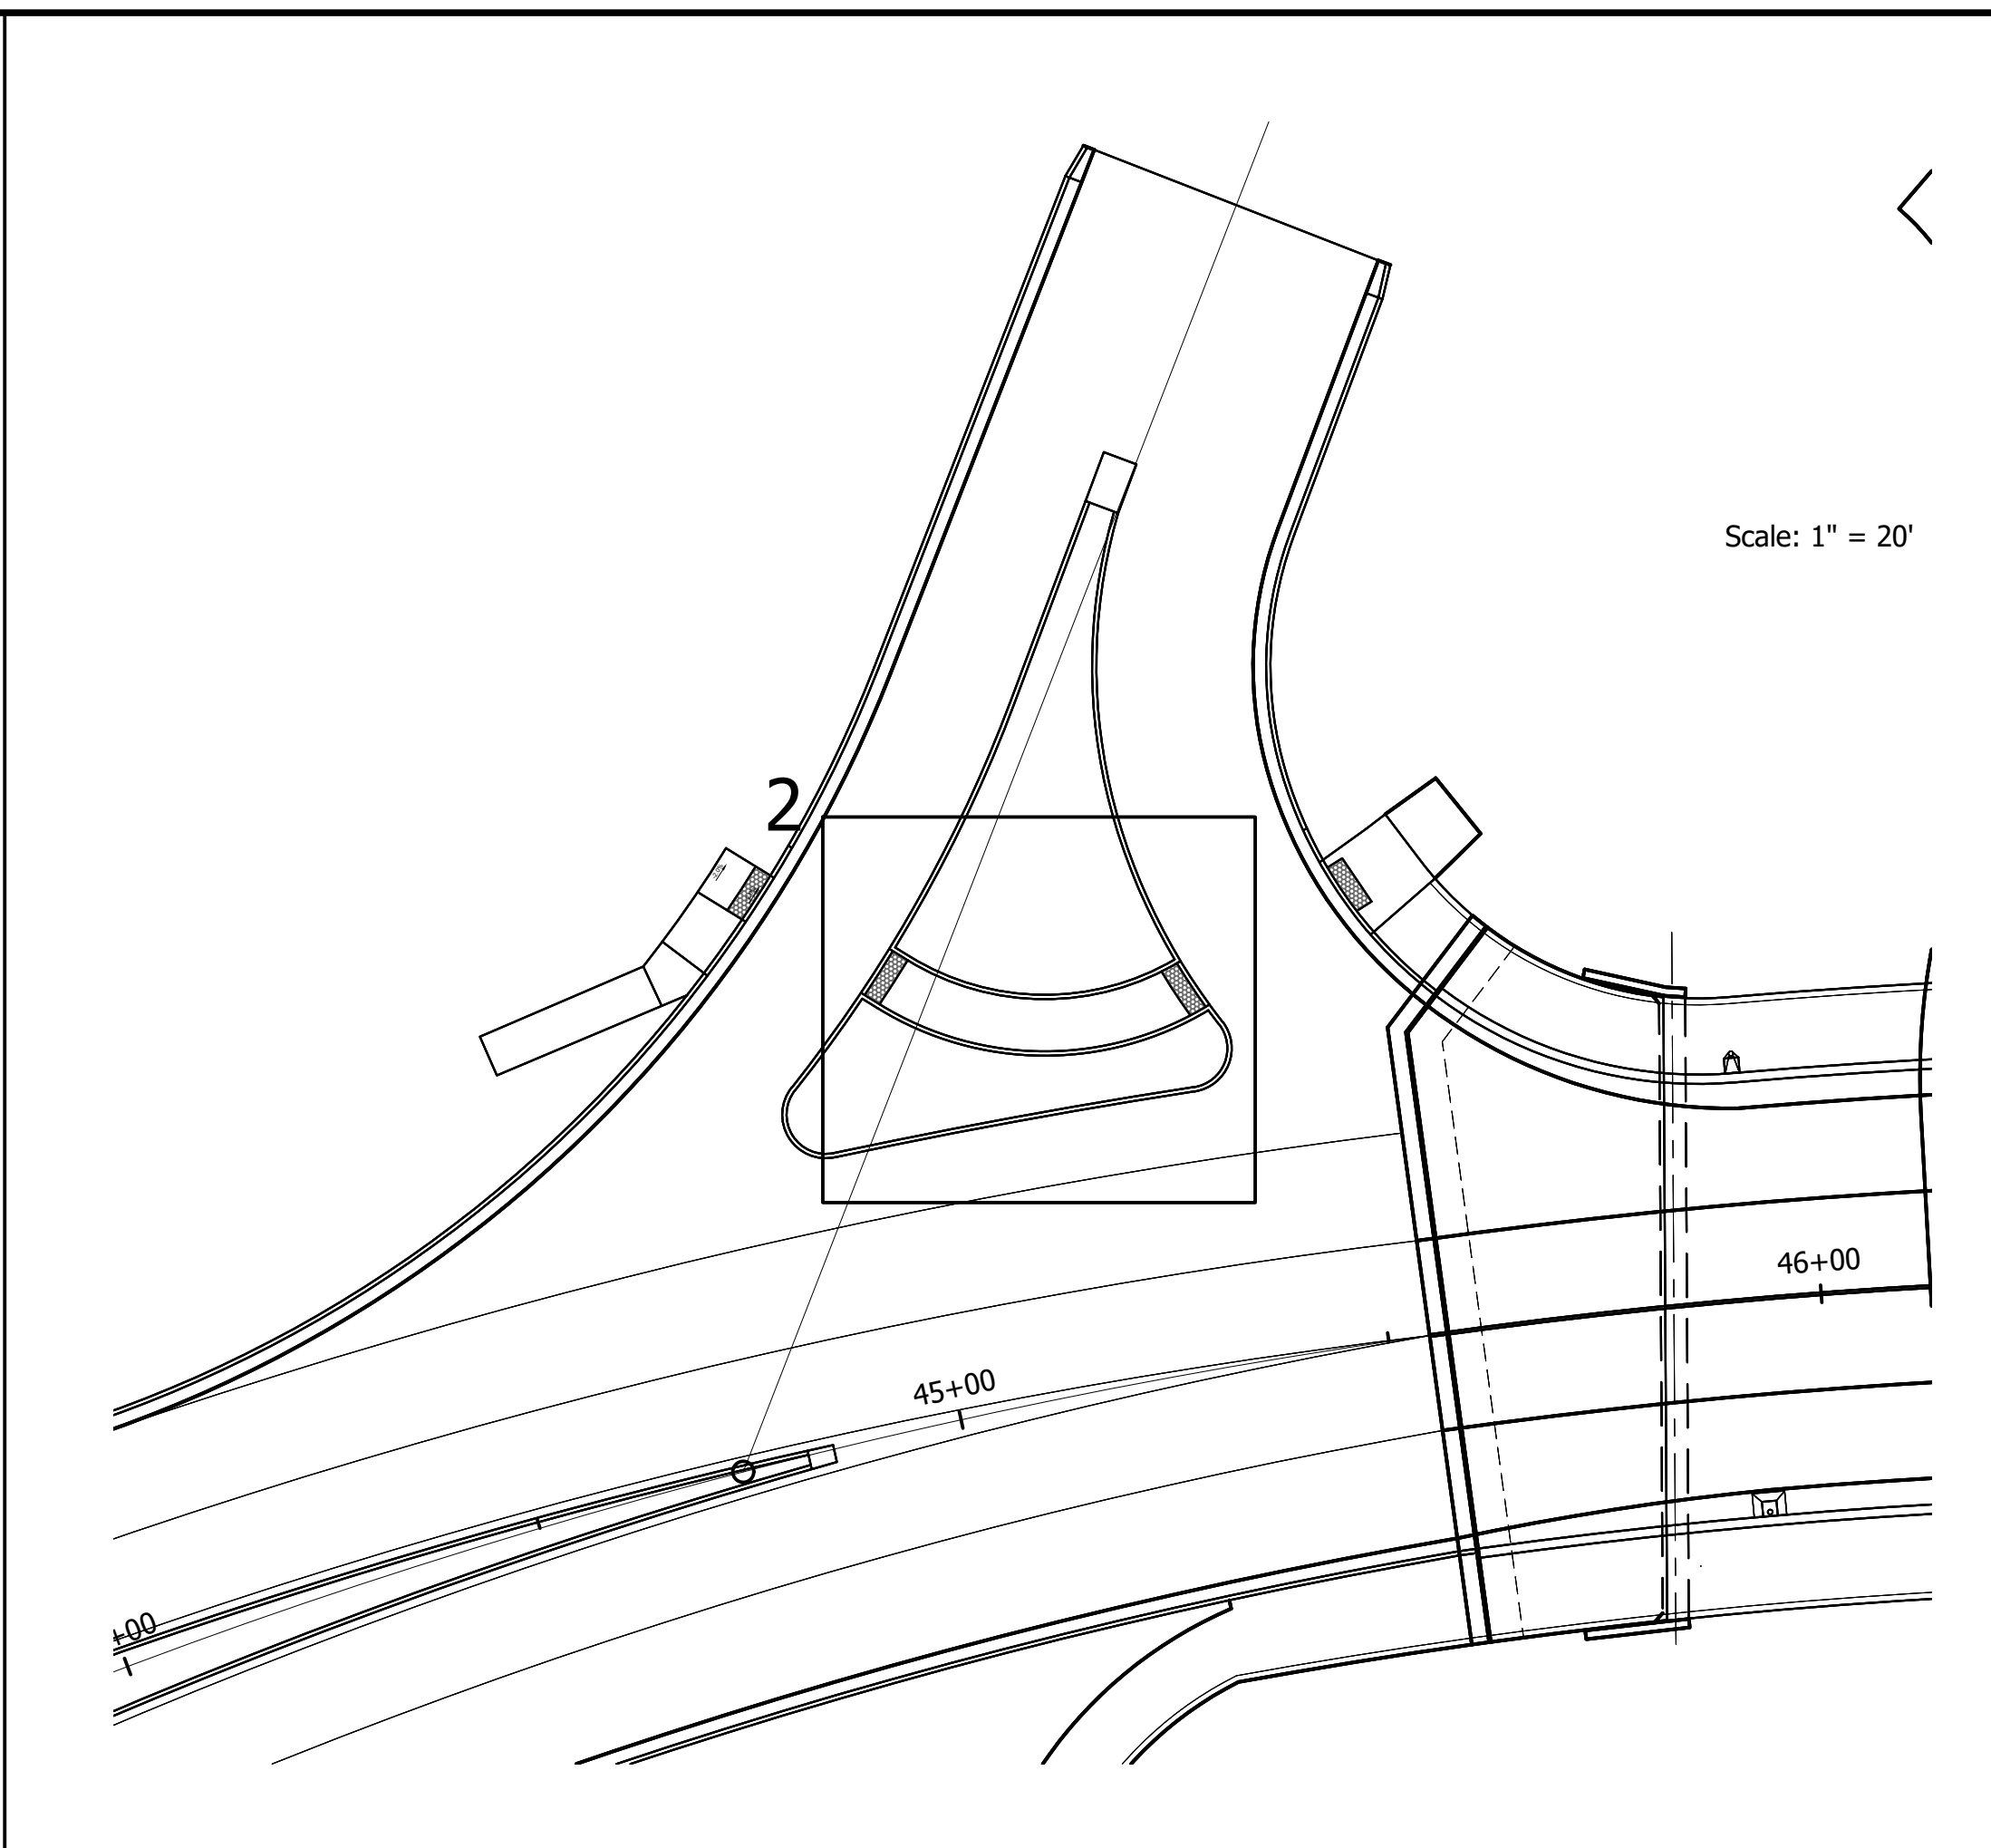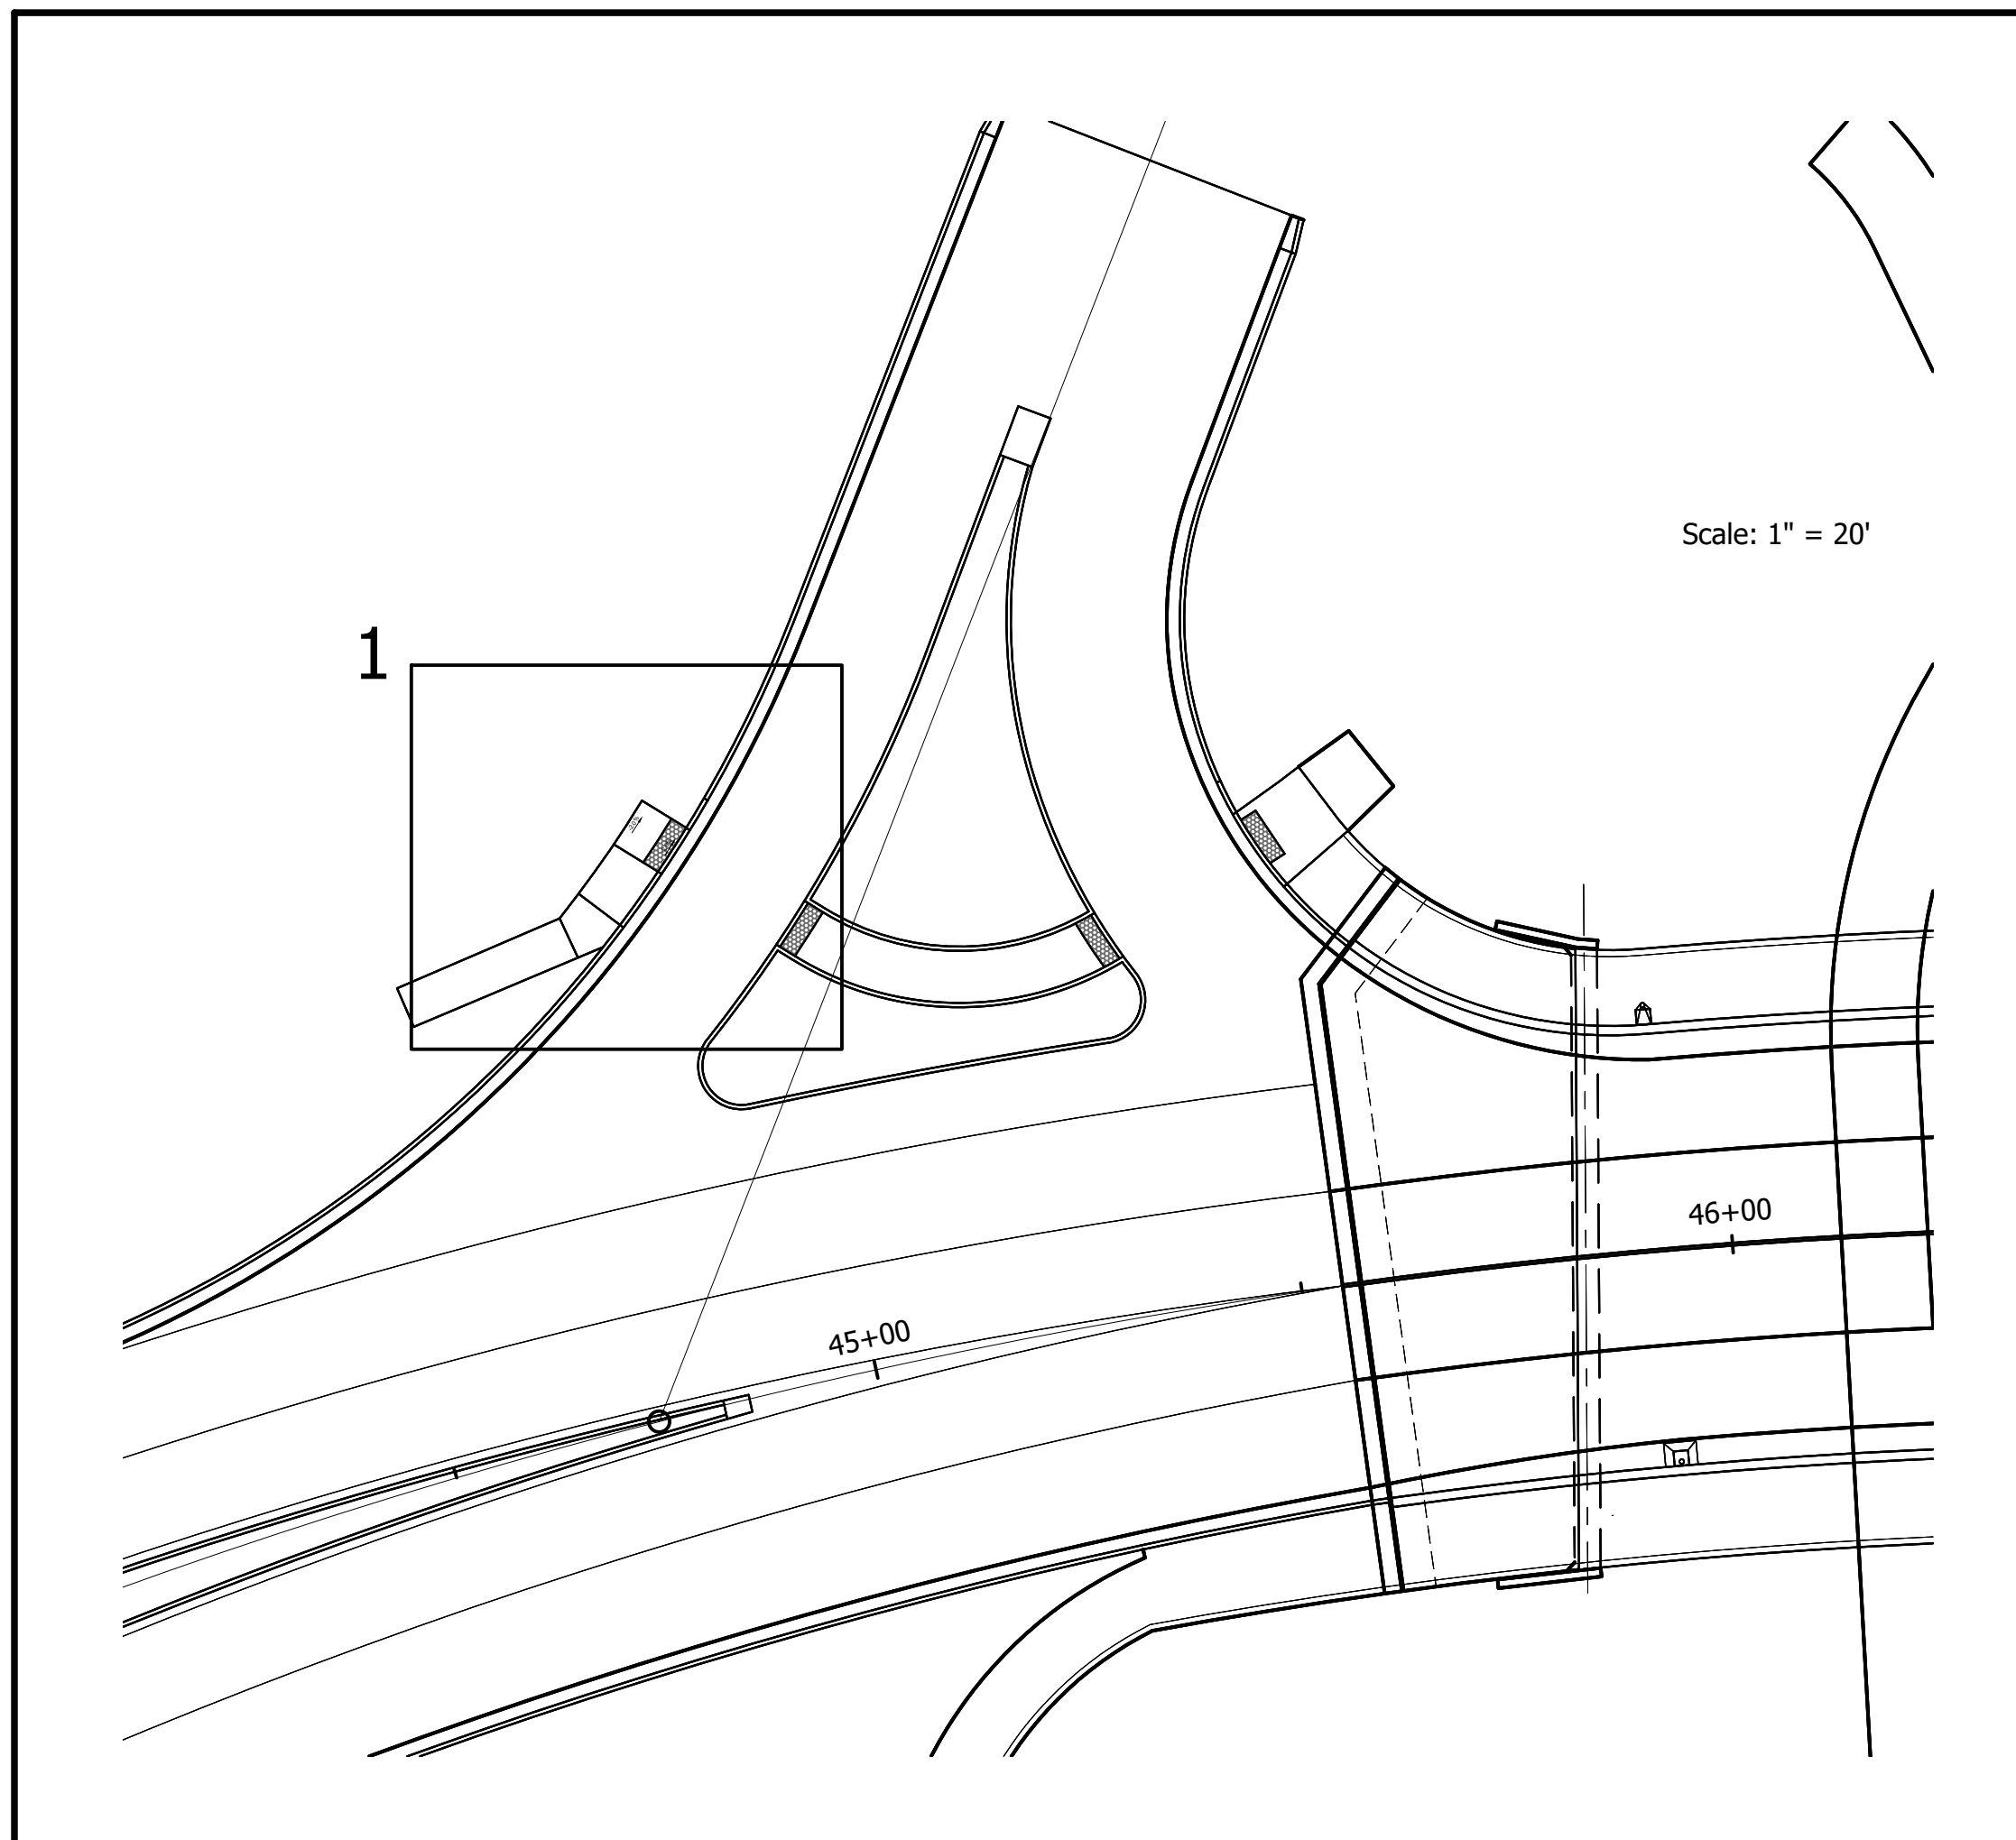

- LEGEND**
- (T) Detectable Warning Surface
 - (C) Required Curb
 - E.P. = Edge of Pavement
 - B.C. = Bottom of Curb
 - T.C. = Top of Curb







NOT FOR CONSTRUCTION

DESIGNED: BMA	DRAWN: CNC
CHECKED: KAM	CHECKED: BMA

**INDIANA
DEPARTMENT OF TRANSPORTATION**

**CURB RAMP DETAILS
BLUFFTON RD / BROADWAY**

HORIZONTAL SCALE AS NOTED	BRIDGE FILE ALLEN 358
VERTICAL SCALE N/A	DESIGNATION 1902834
SURVEY BOOK ----	SHEETS 21 of 63
CONTRACT B-42844	PROJECT 1902834

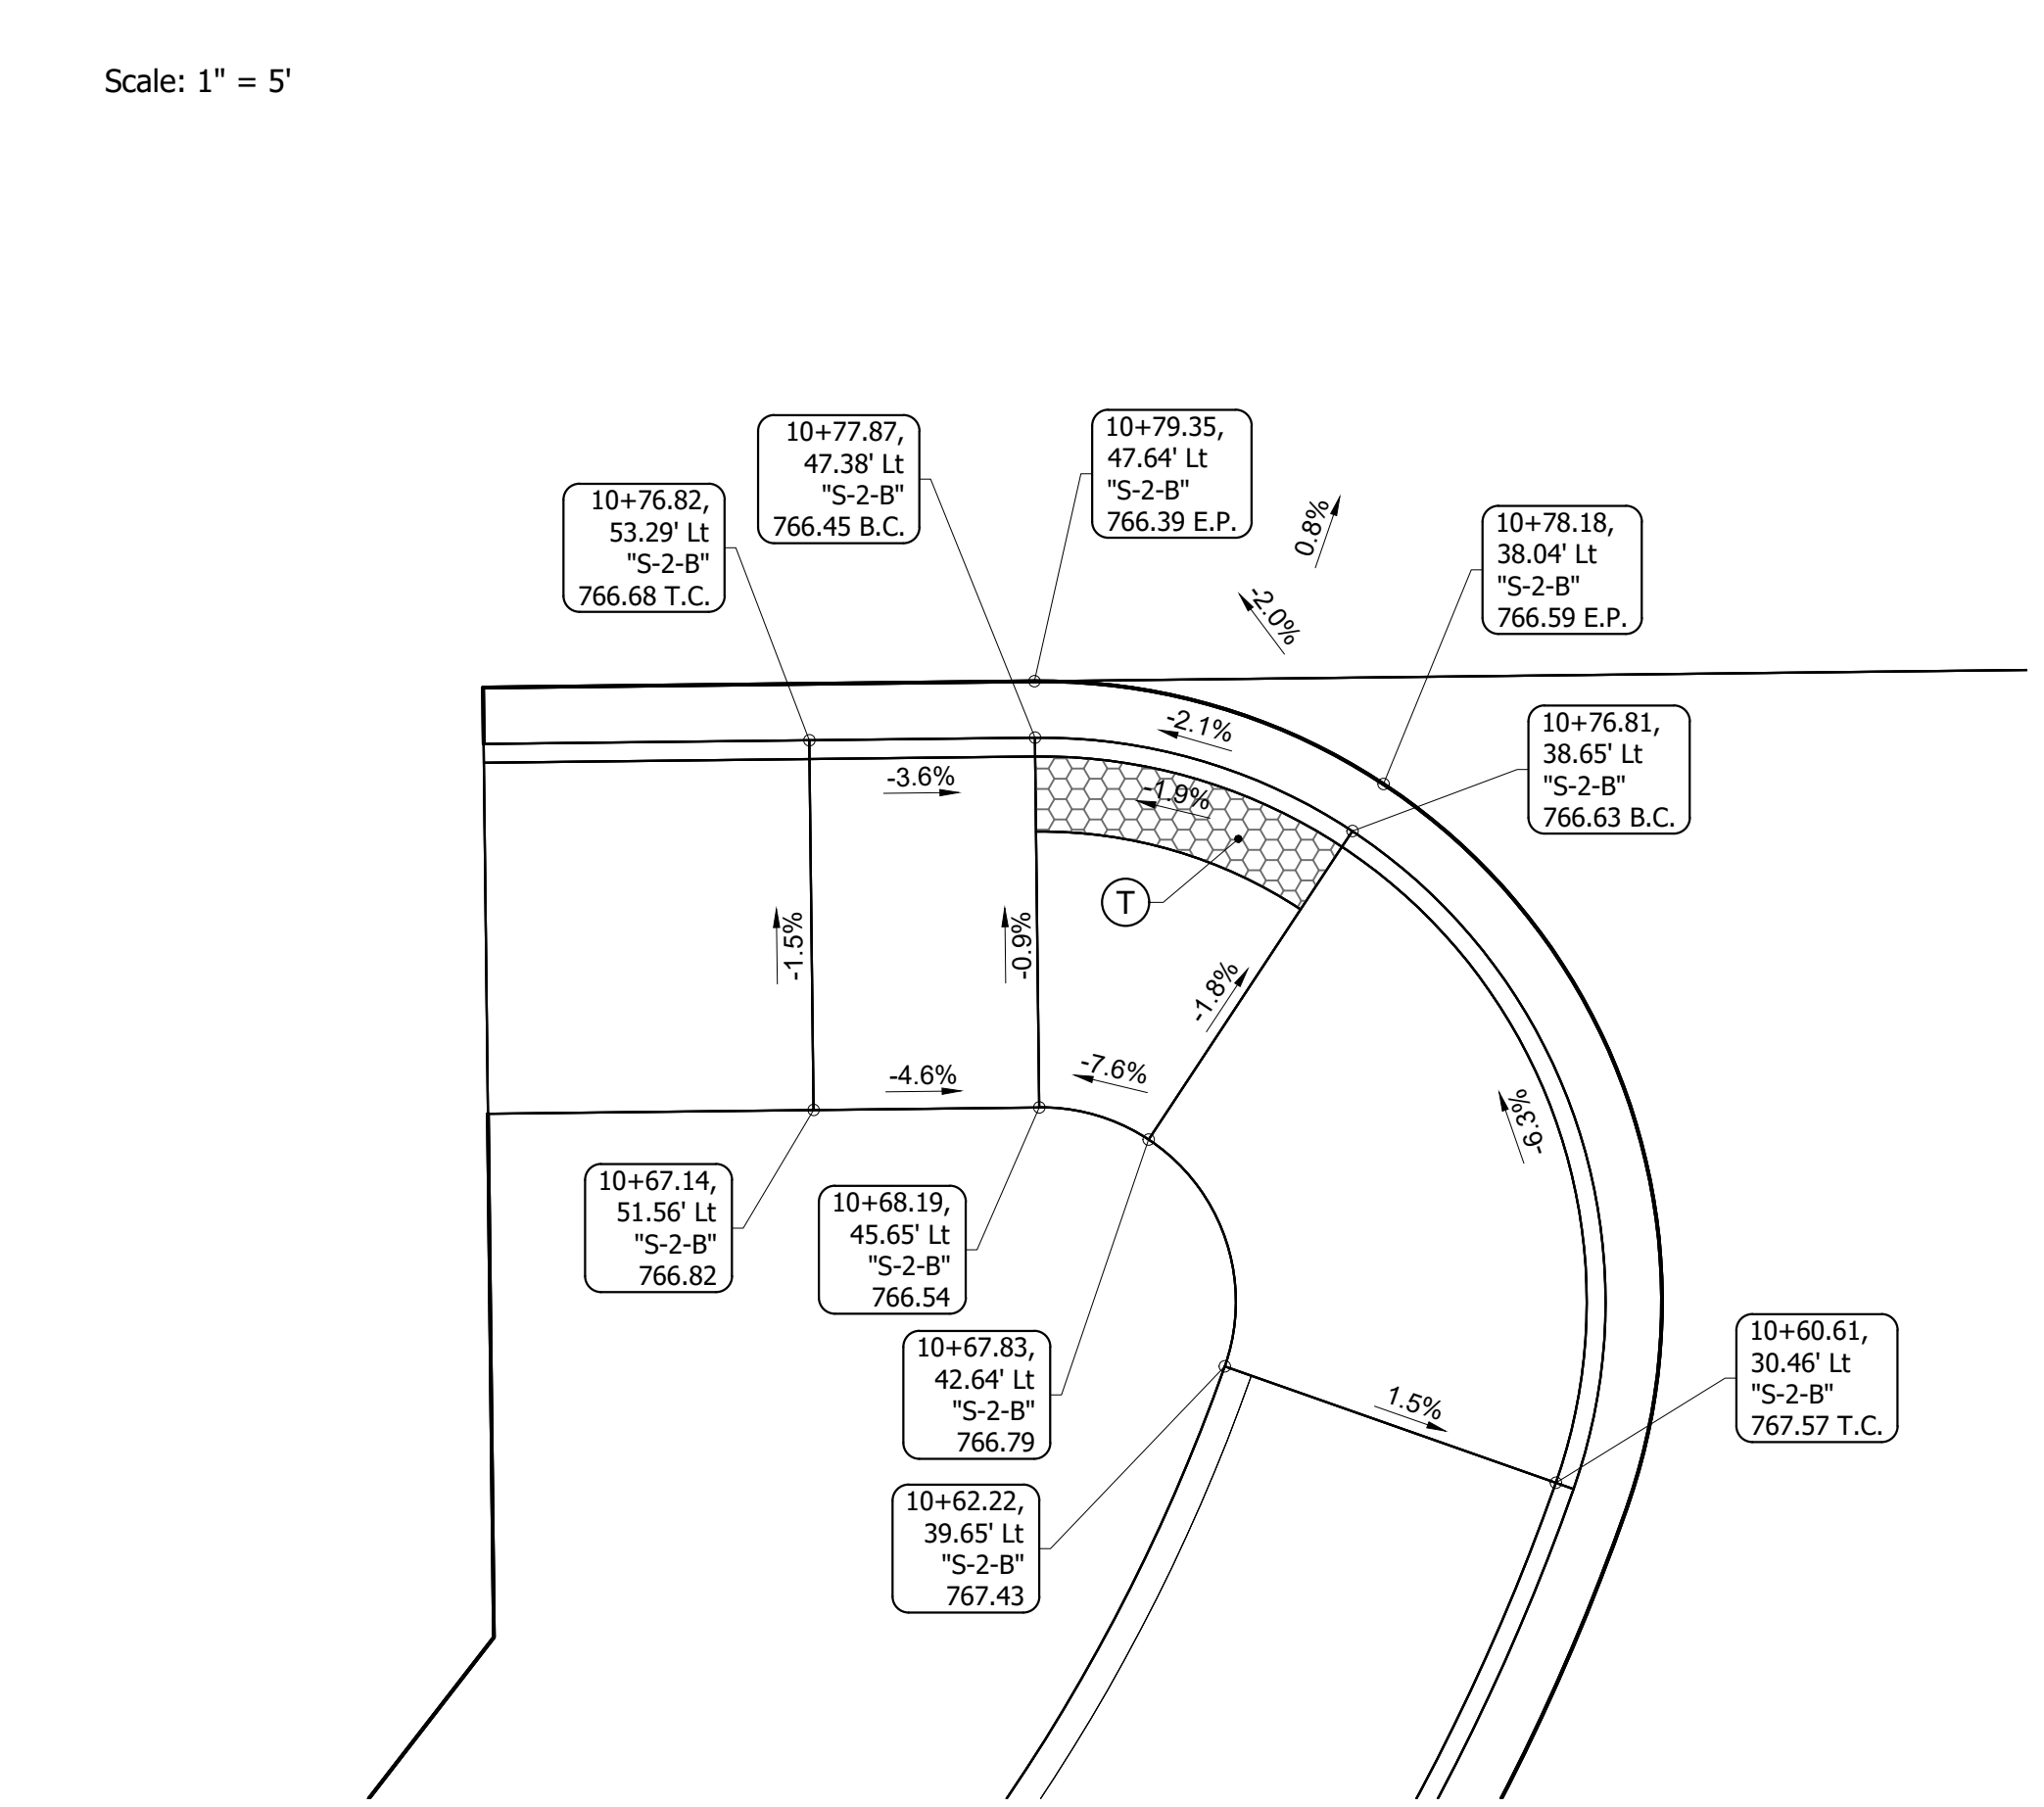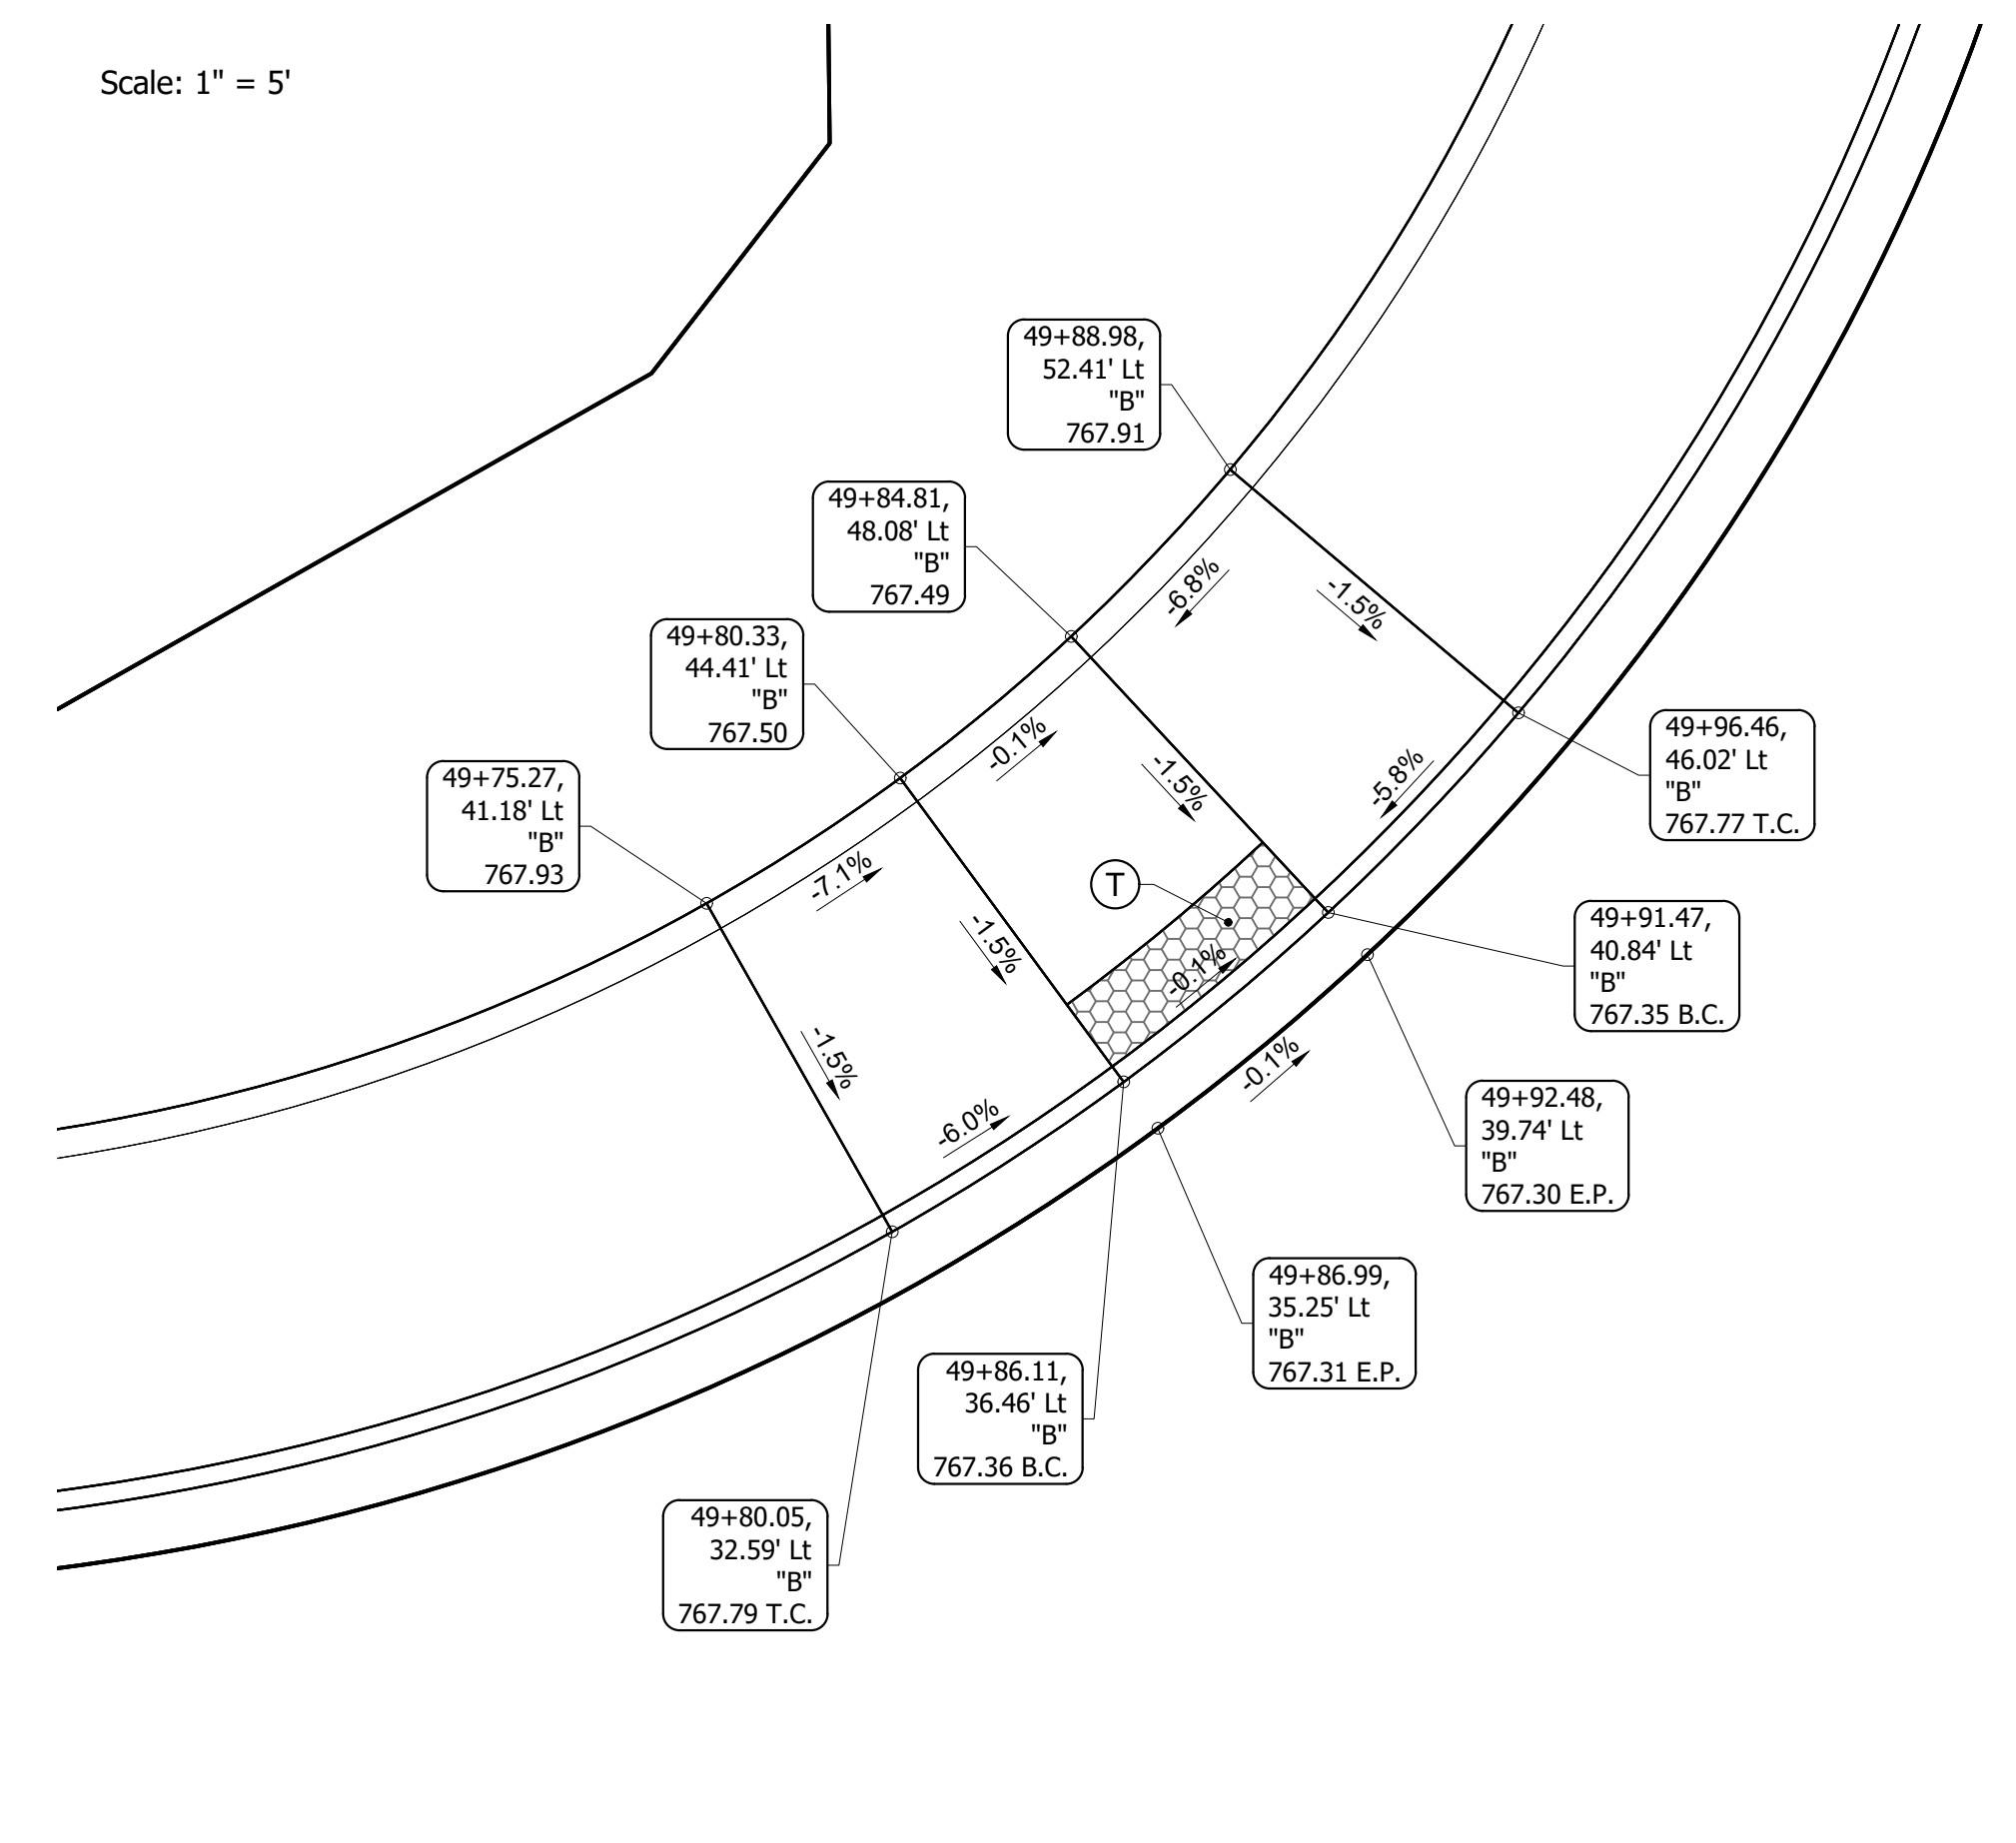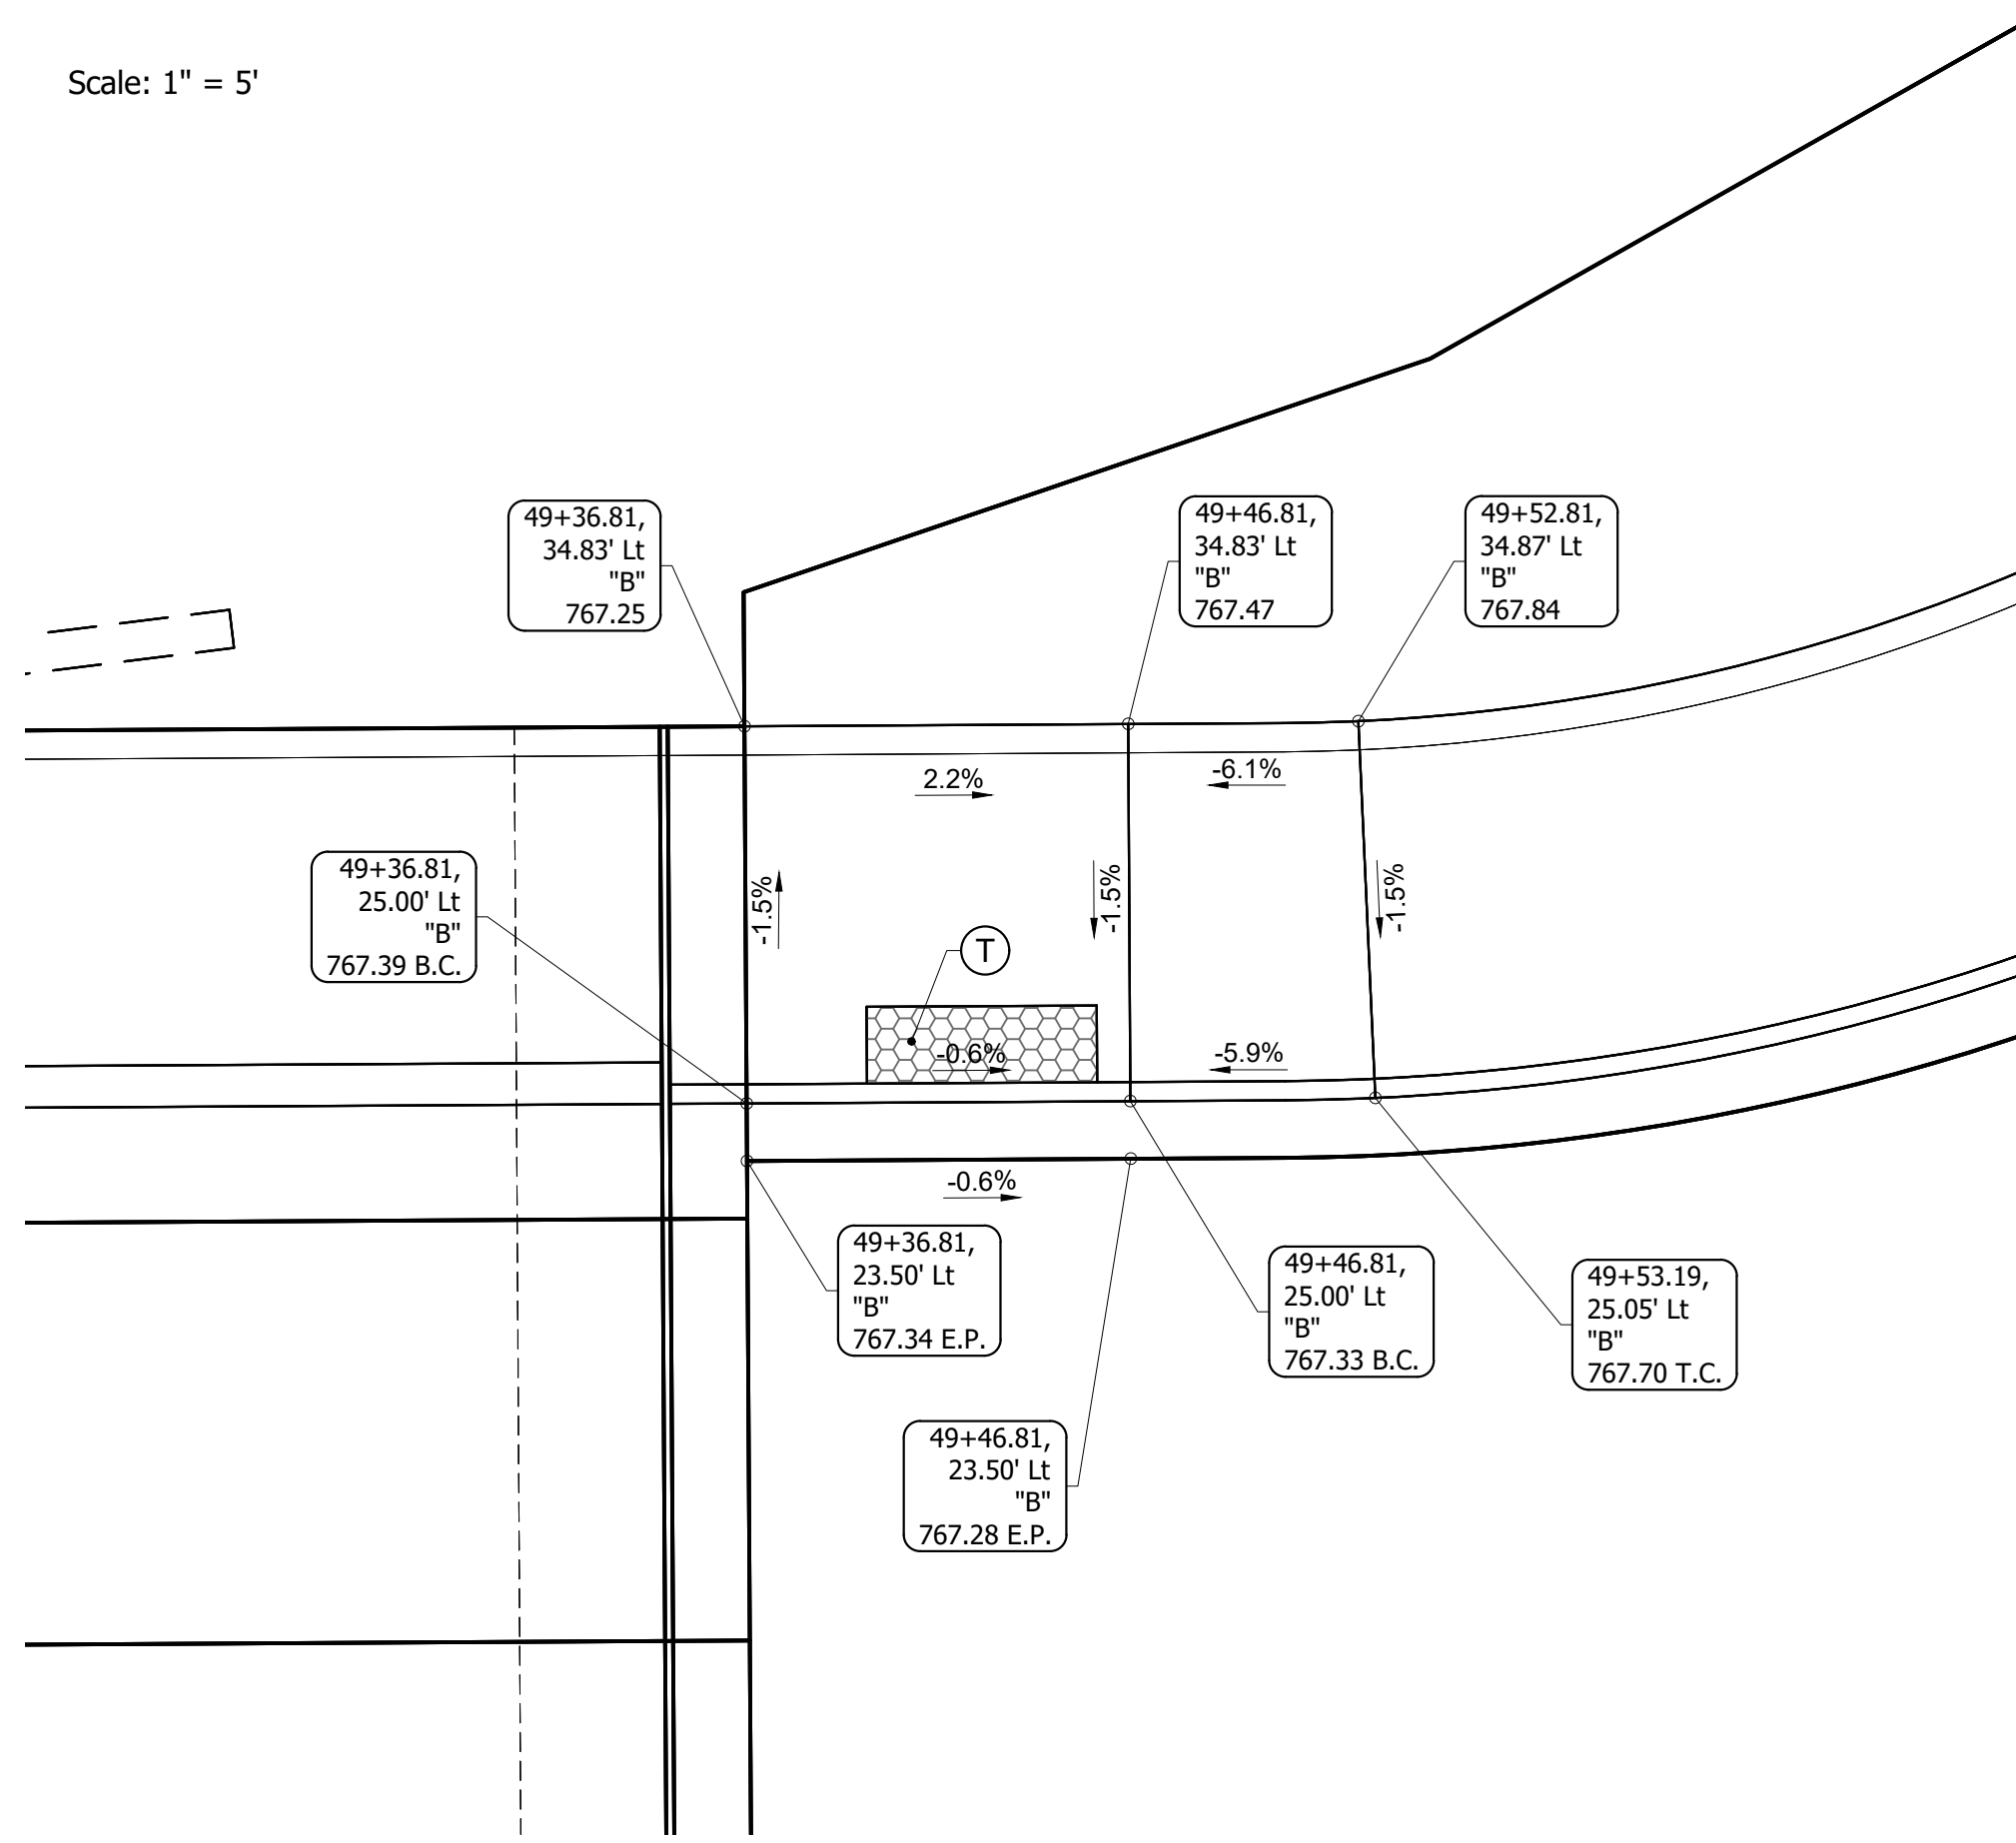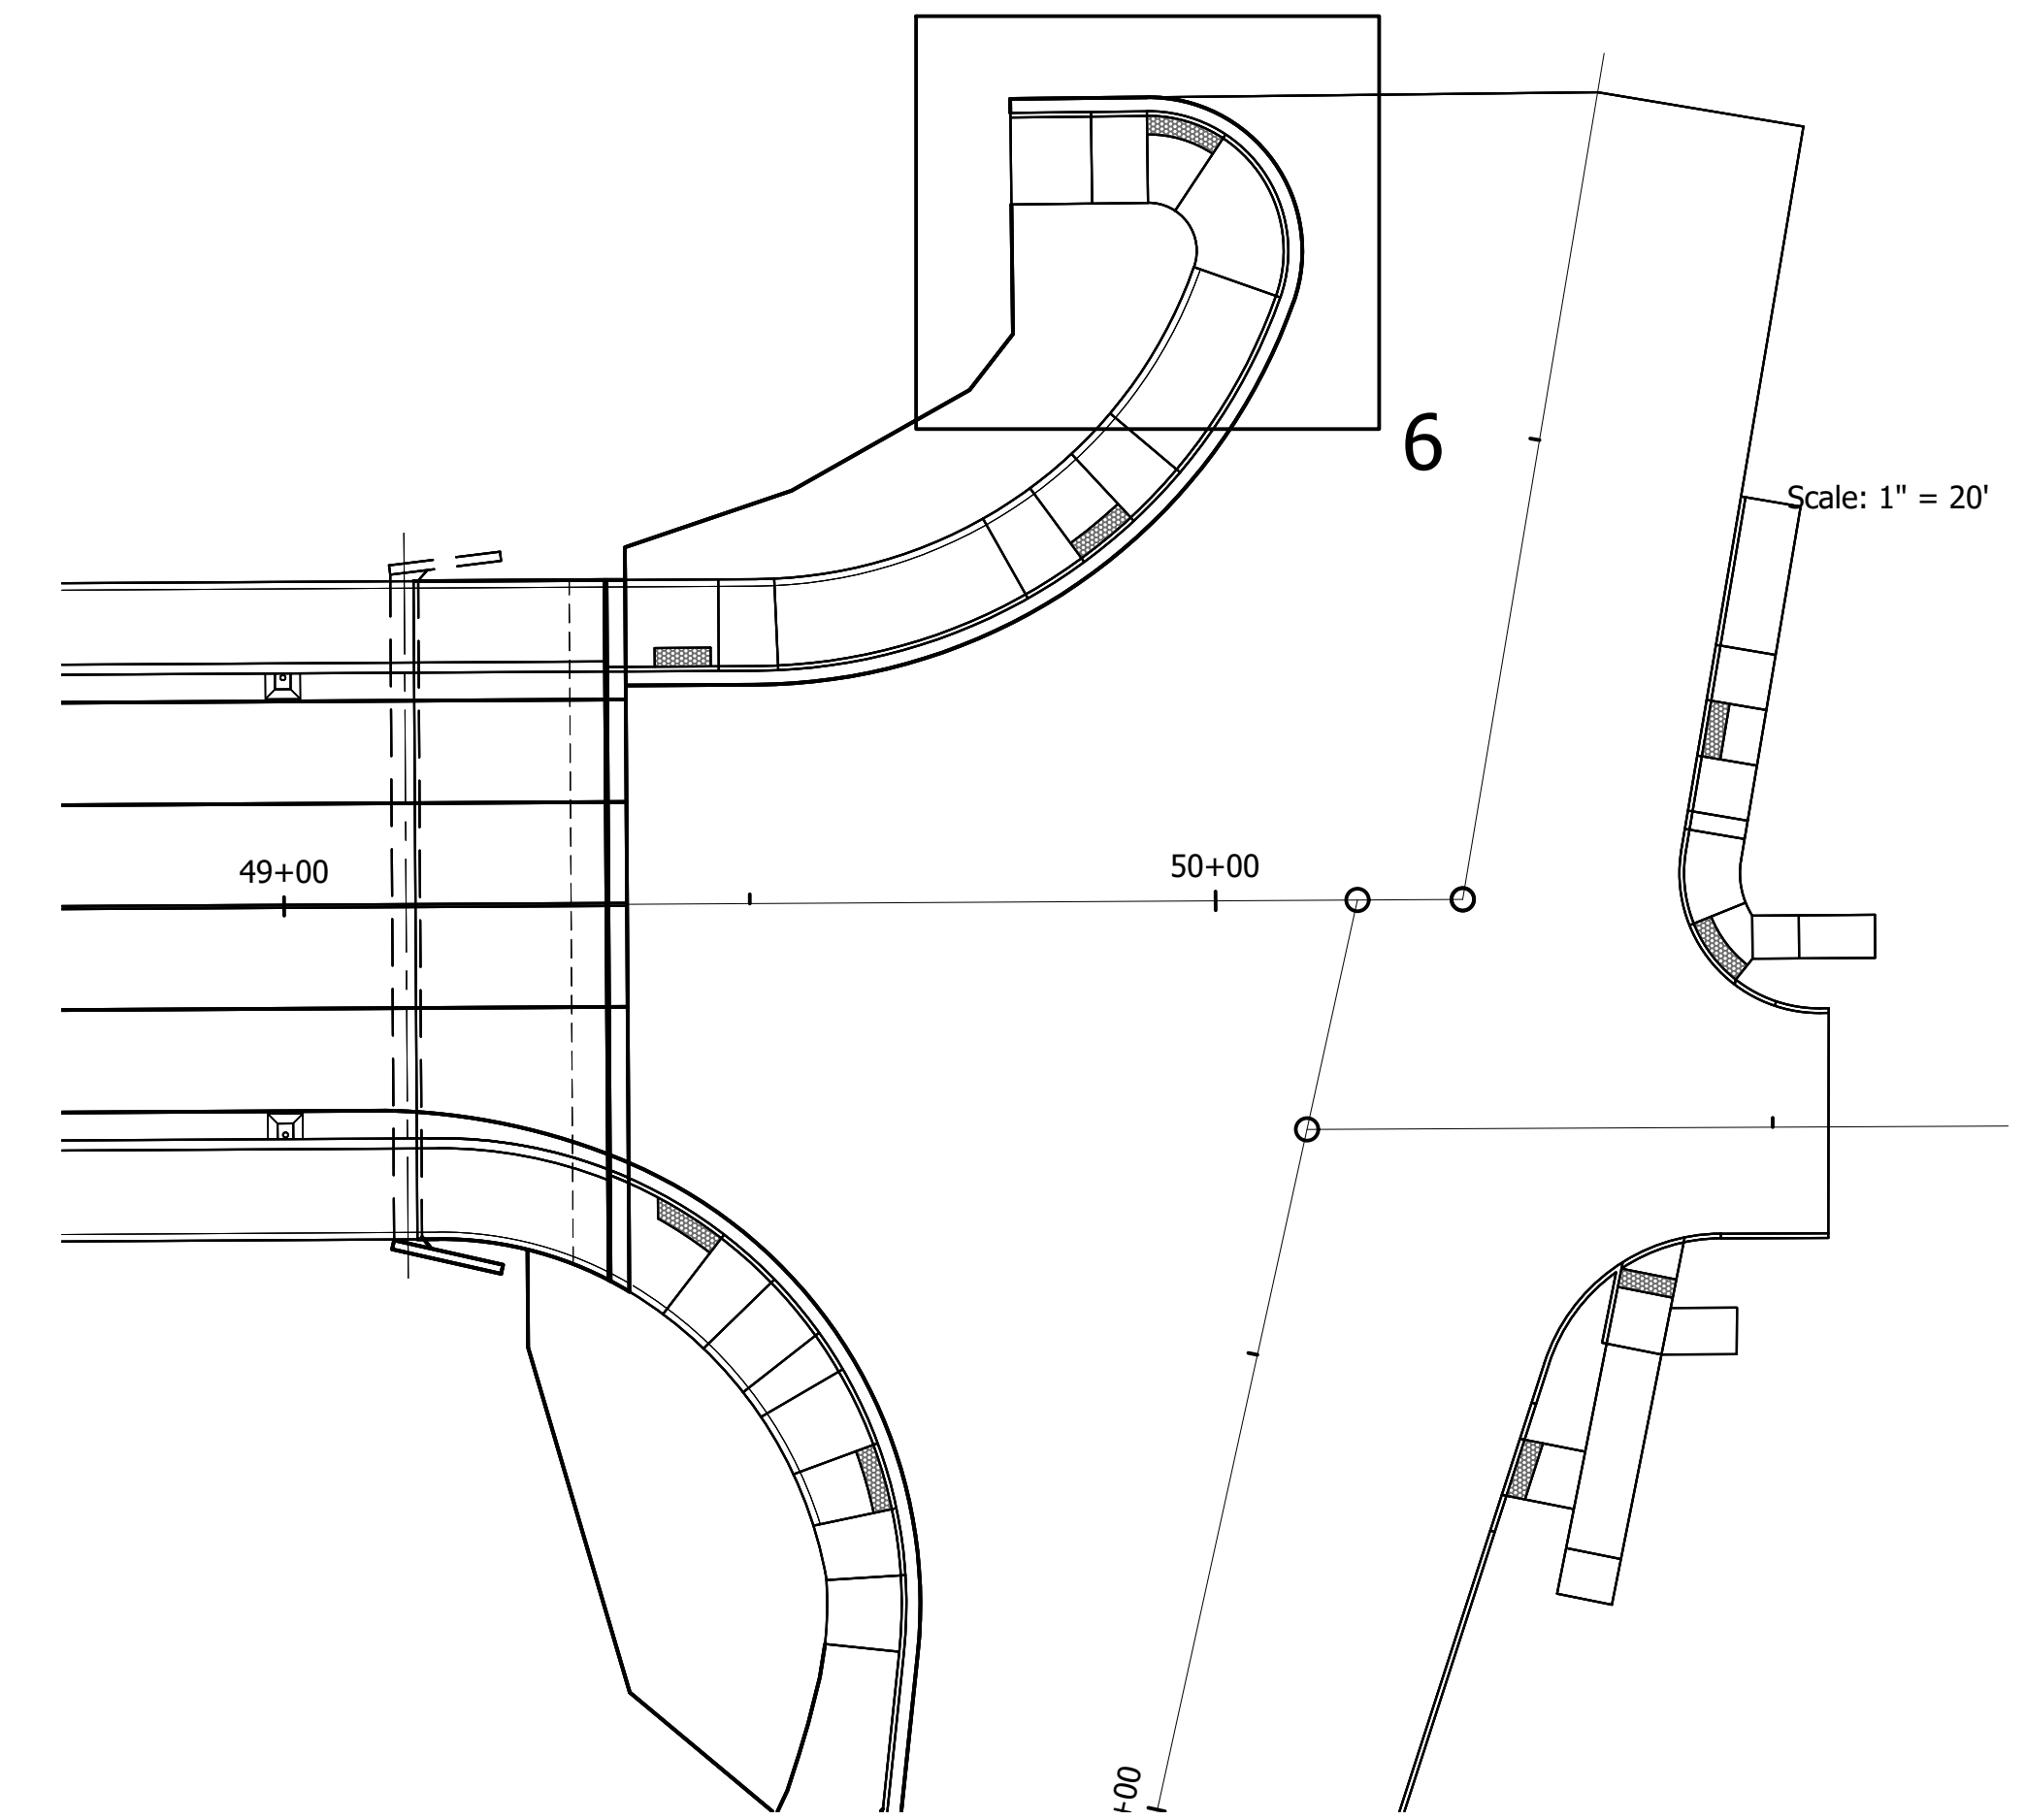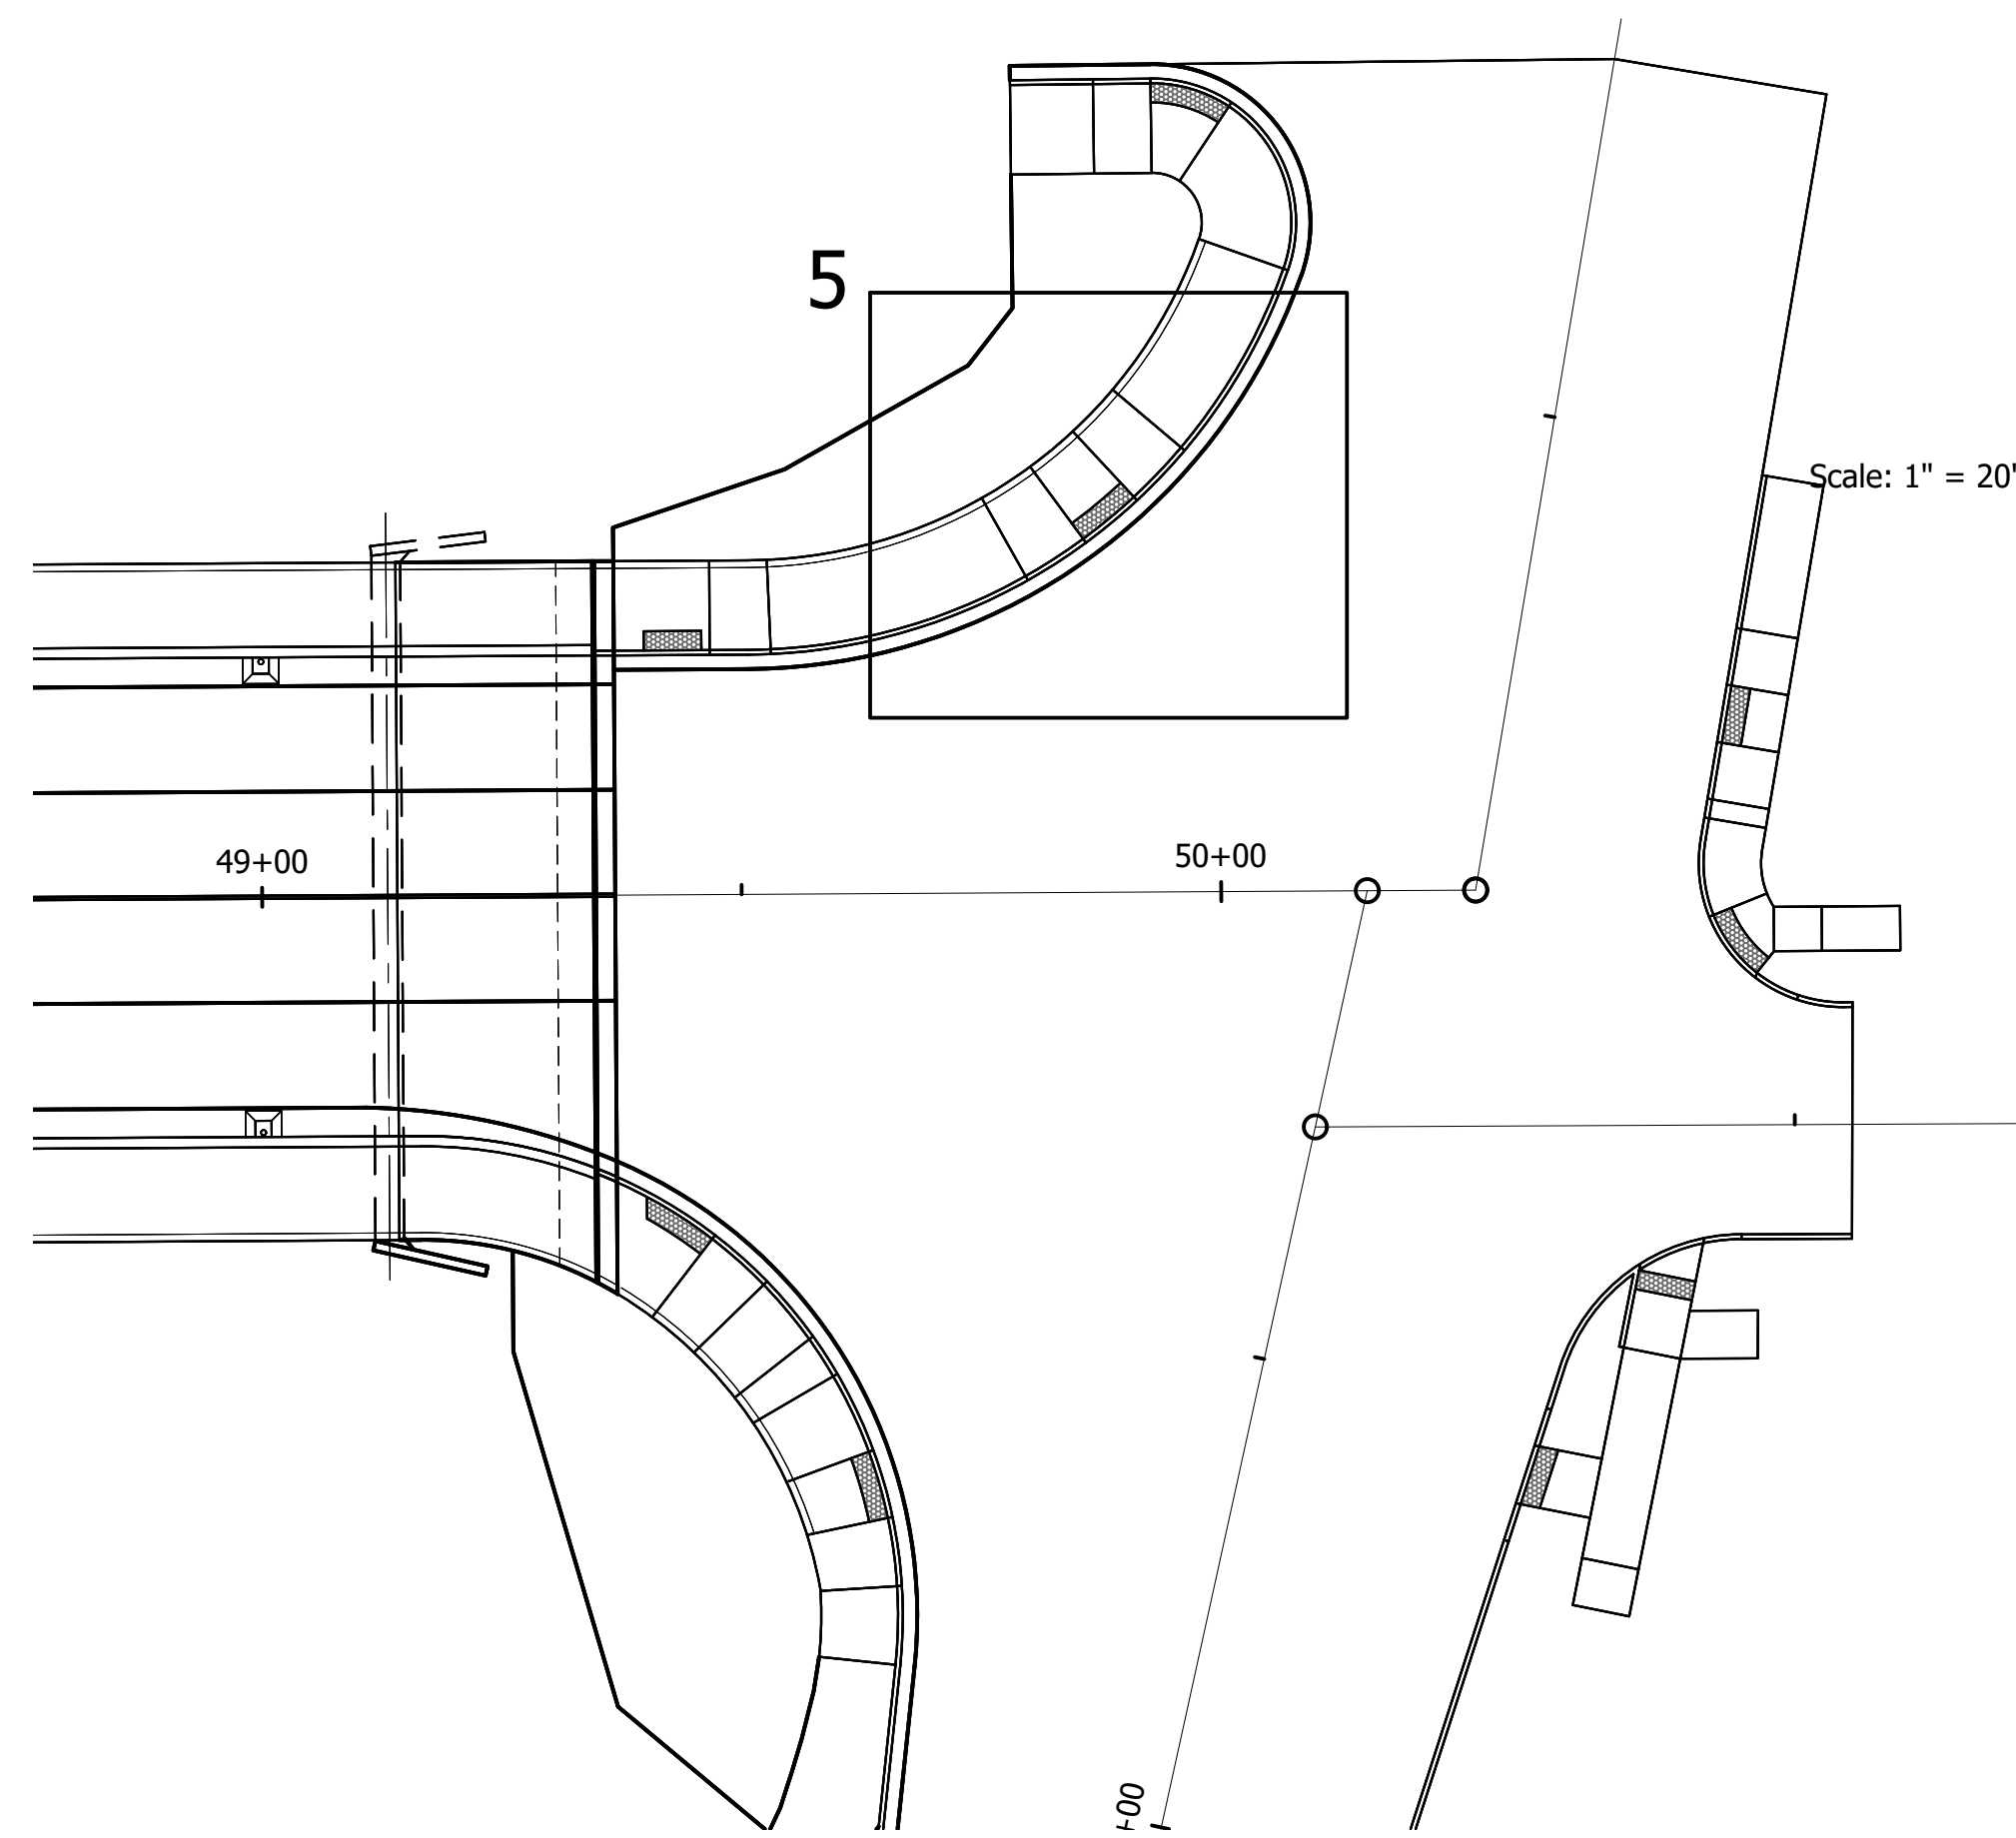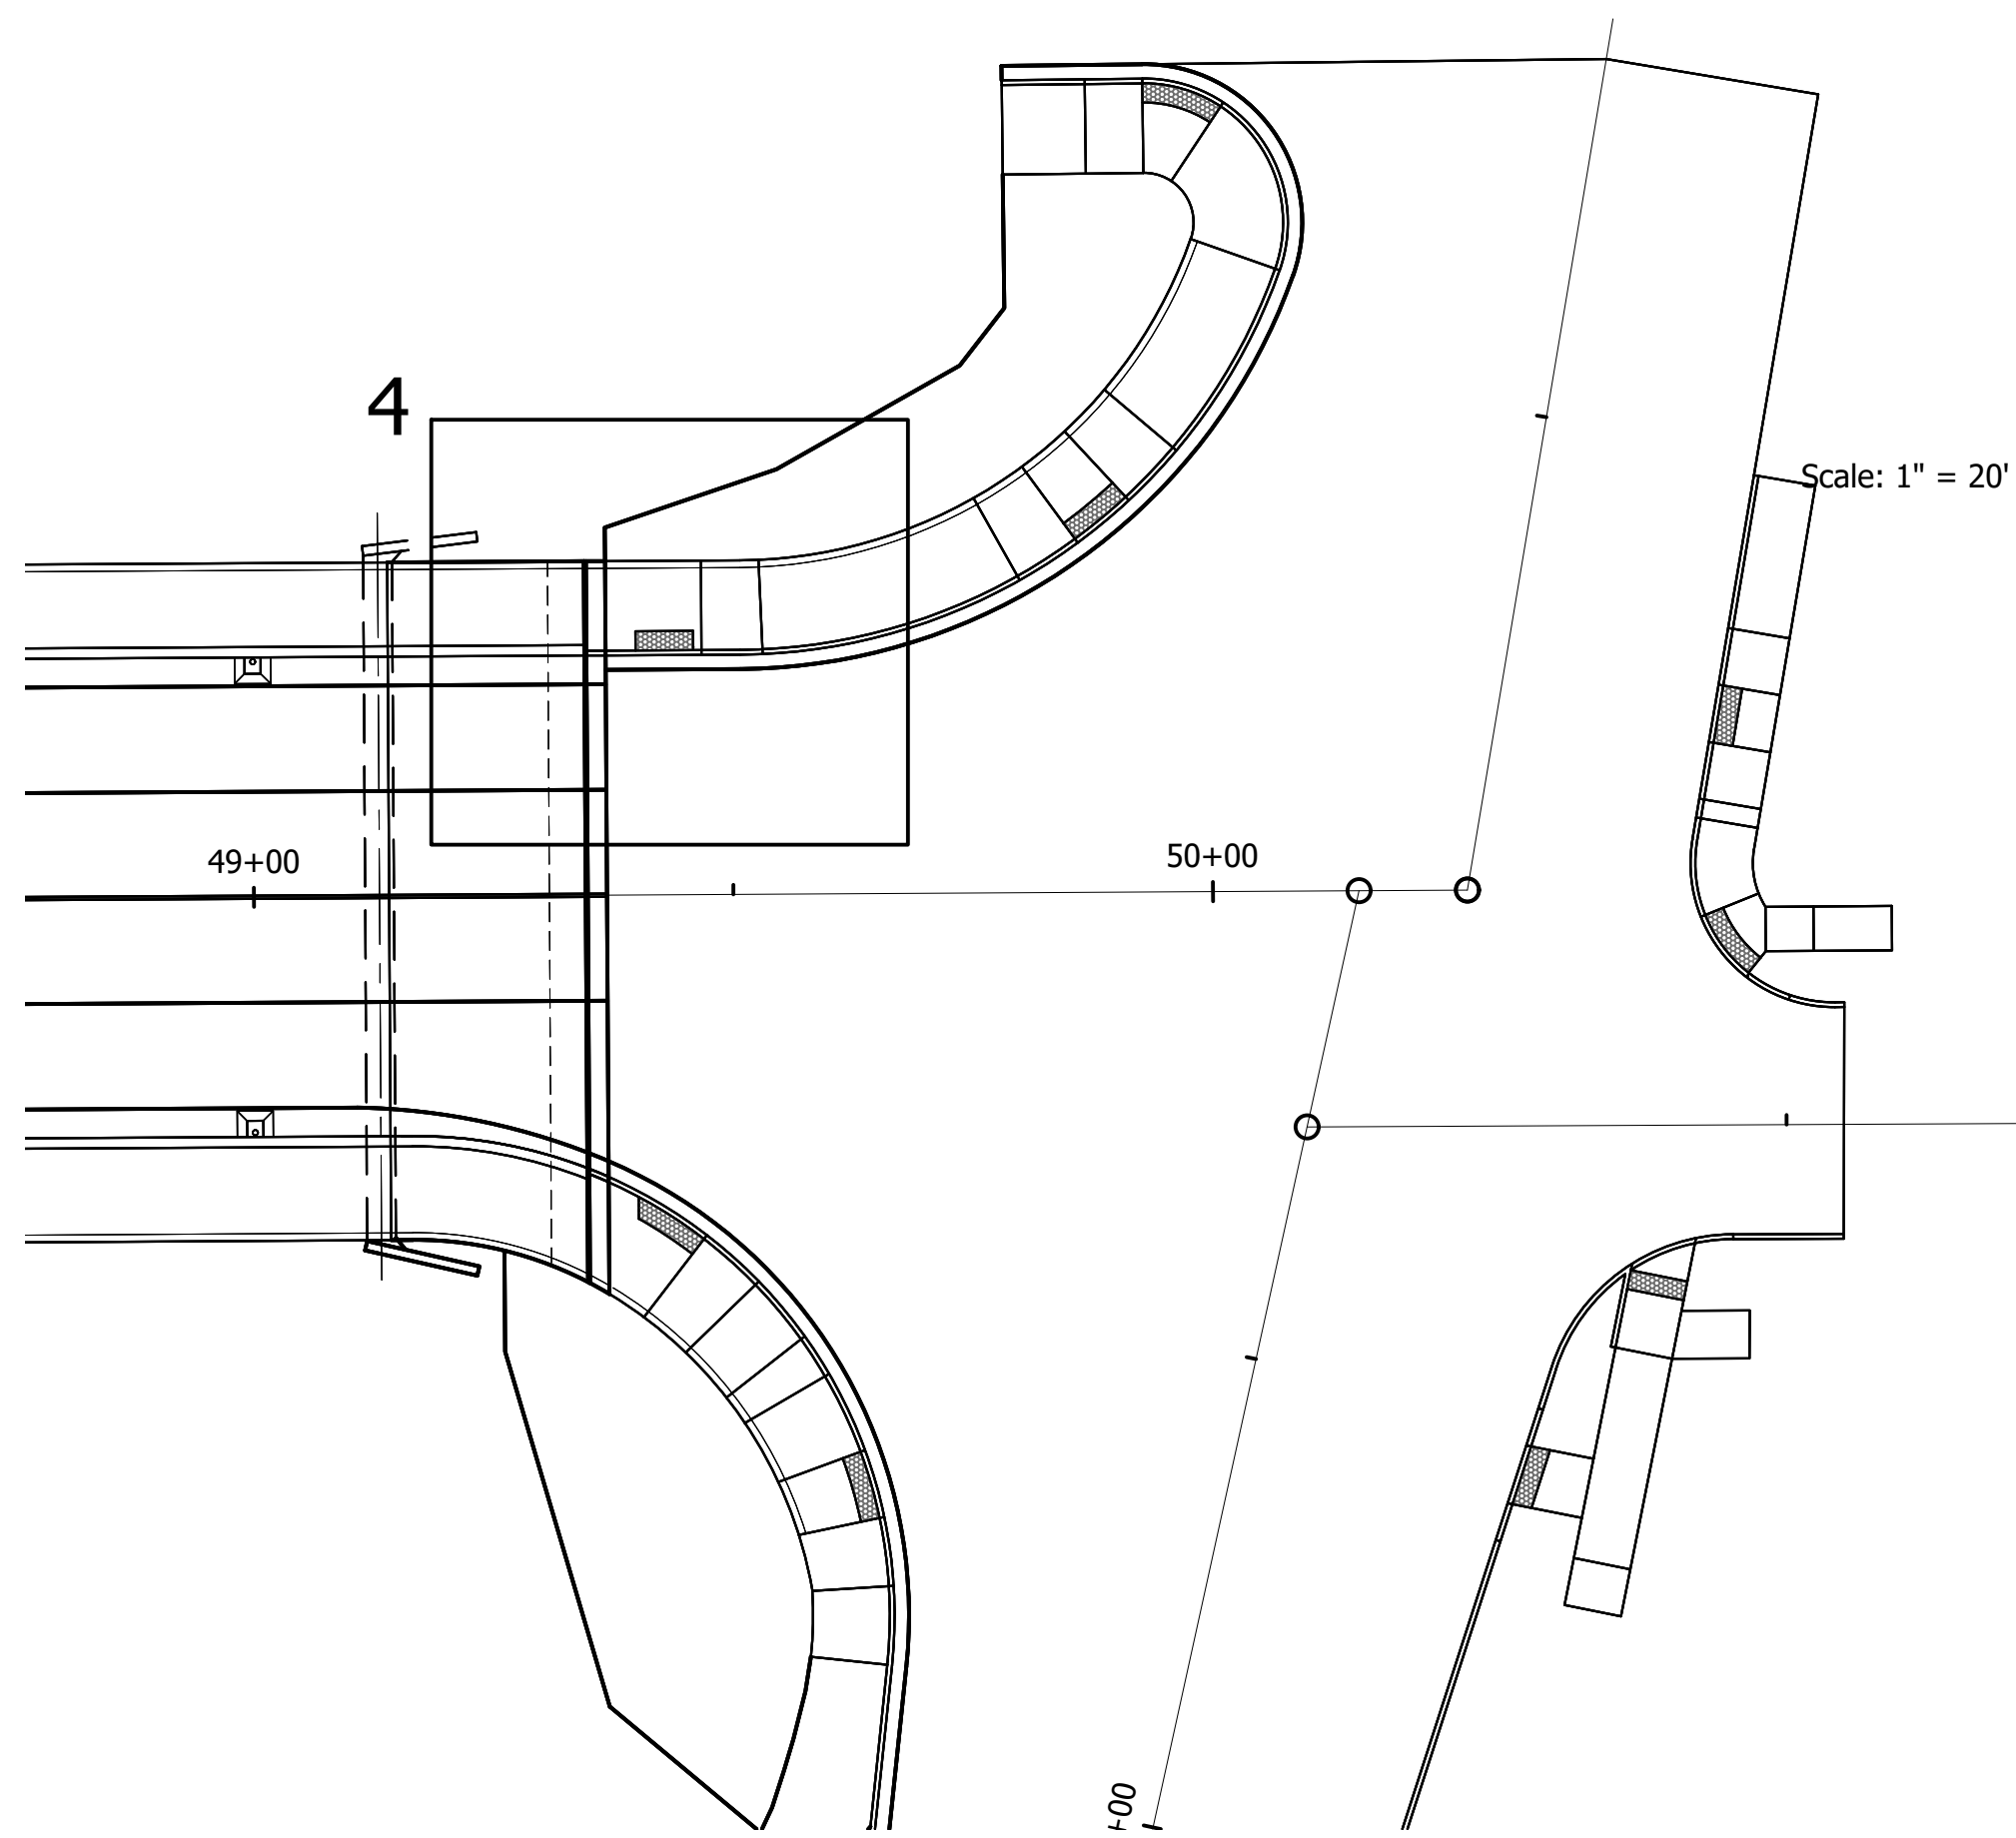

LEGEND

(T) Detectable Warning Surface
 (C) Required Curb
 E.P. = Edge of Pavement
 B.C. = Bottom of Curb
 T.C. = Top of Curb







NOT FOR CONSTRUCTION

DESIGNED: BMA DRAWN: CNC
 CHECKED: KAM CHECKED: BMA

INDIANA DEPARTMENT OF TRANSPORTATION

CURB RAMP DETAILS
BLUFFTON RD / BROADWAY

HORIZONTAL SCALE	BRIDGE FILE
AS NOTED	ALLEN 358
VERTICAL SCALE	DESIGNATION
N/A	1902834
SURVEY BOOK	SHEETS
---	22 of 63
CONTRACT	PROJECT
B-42844	1902834

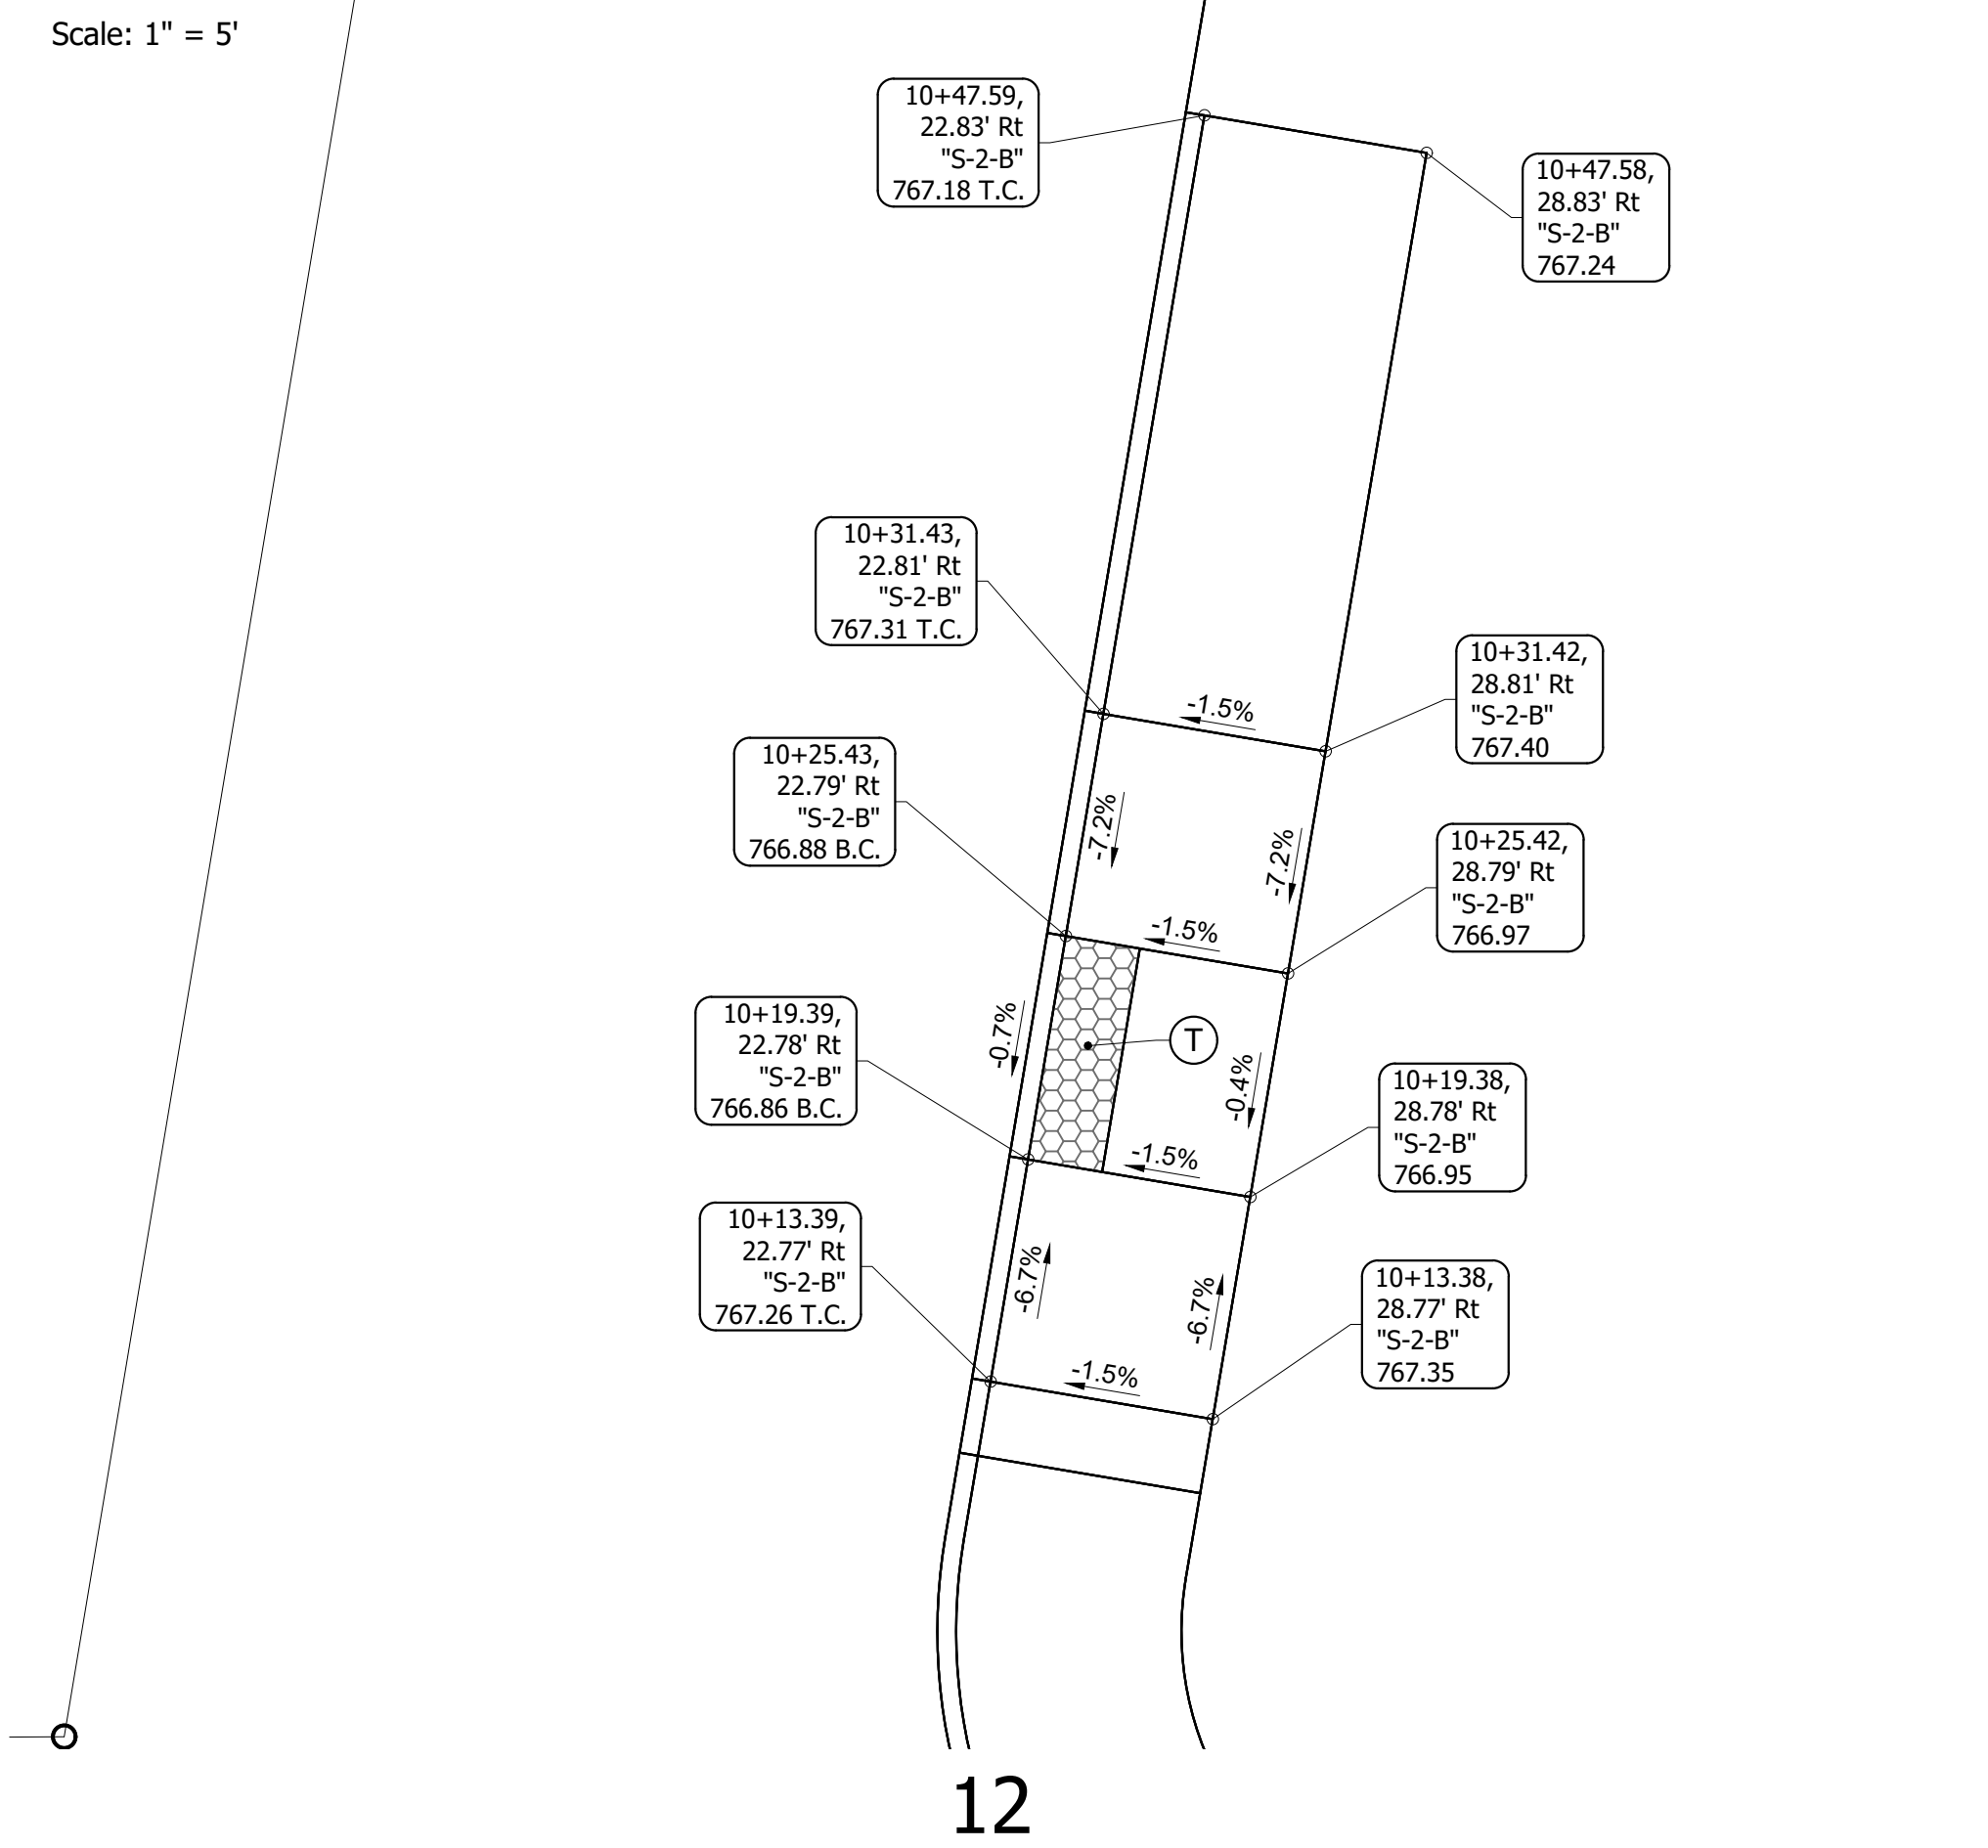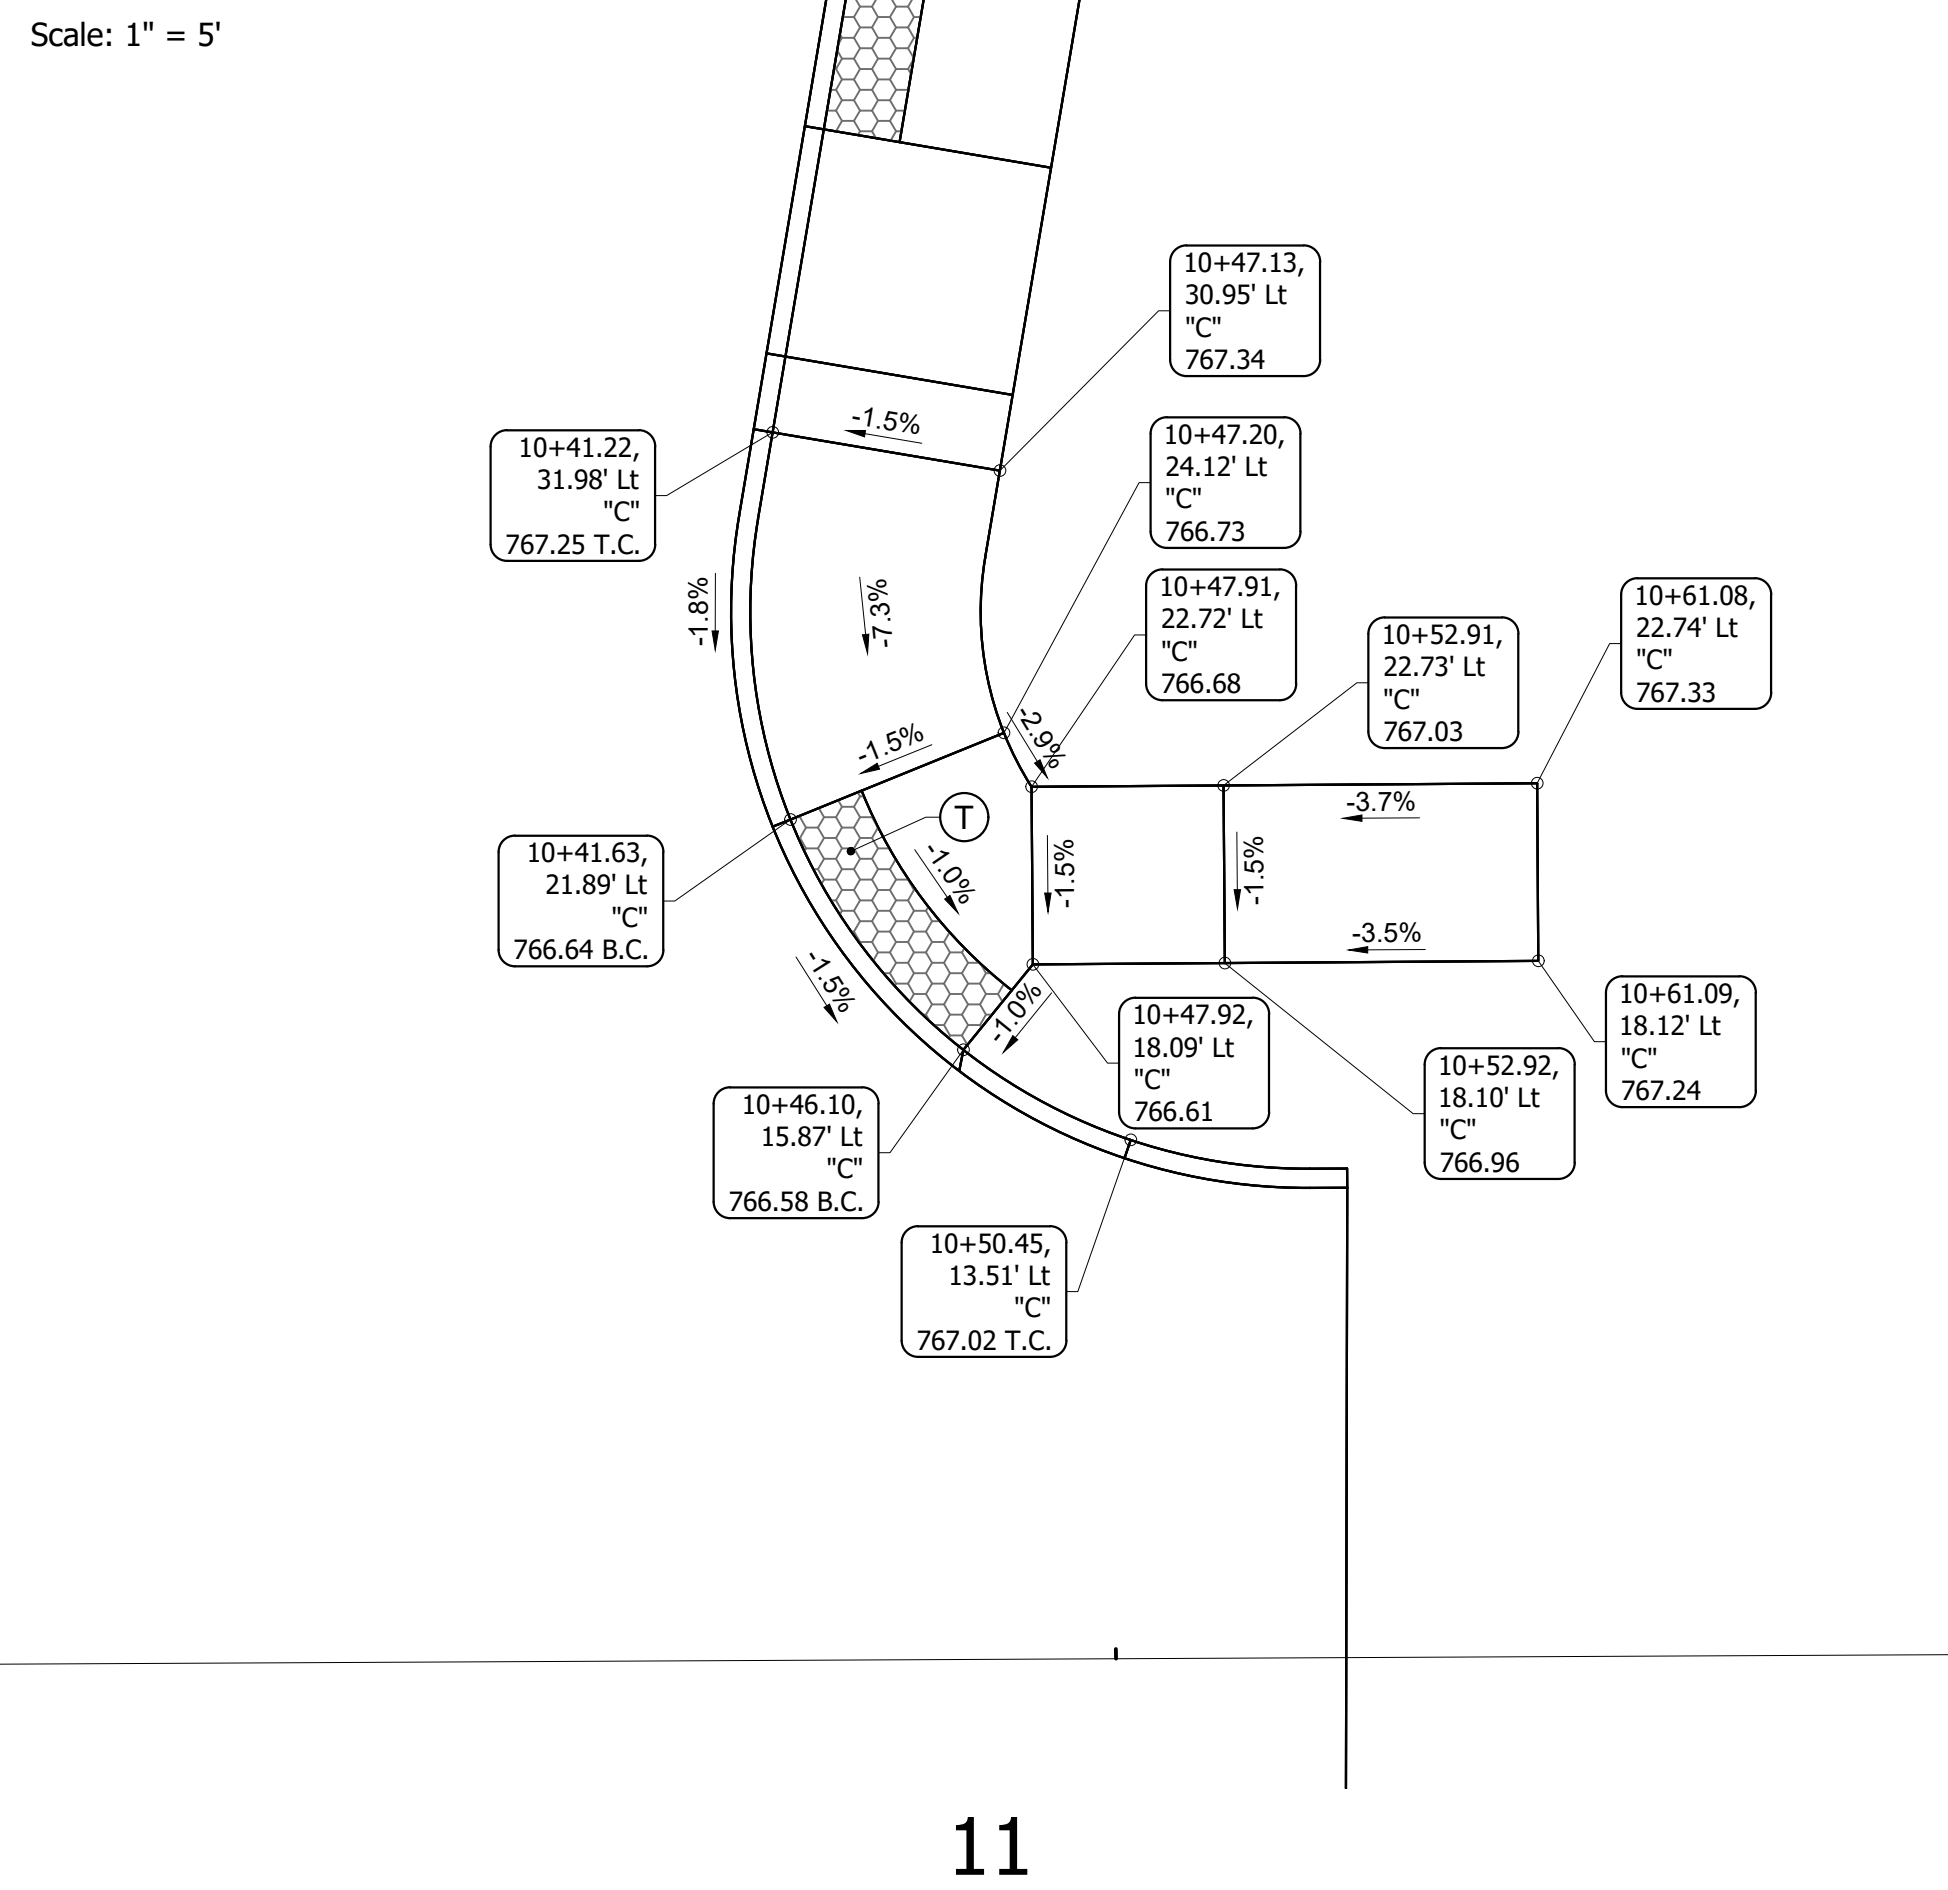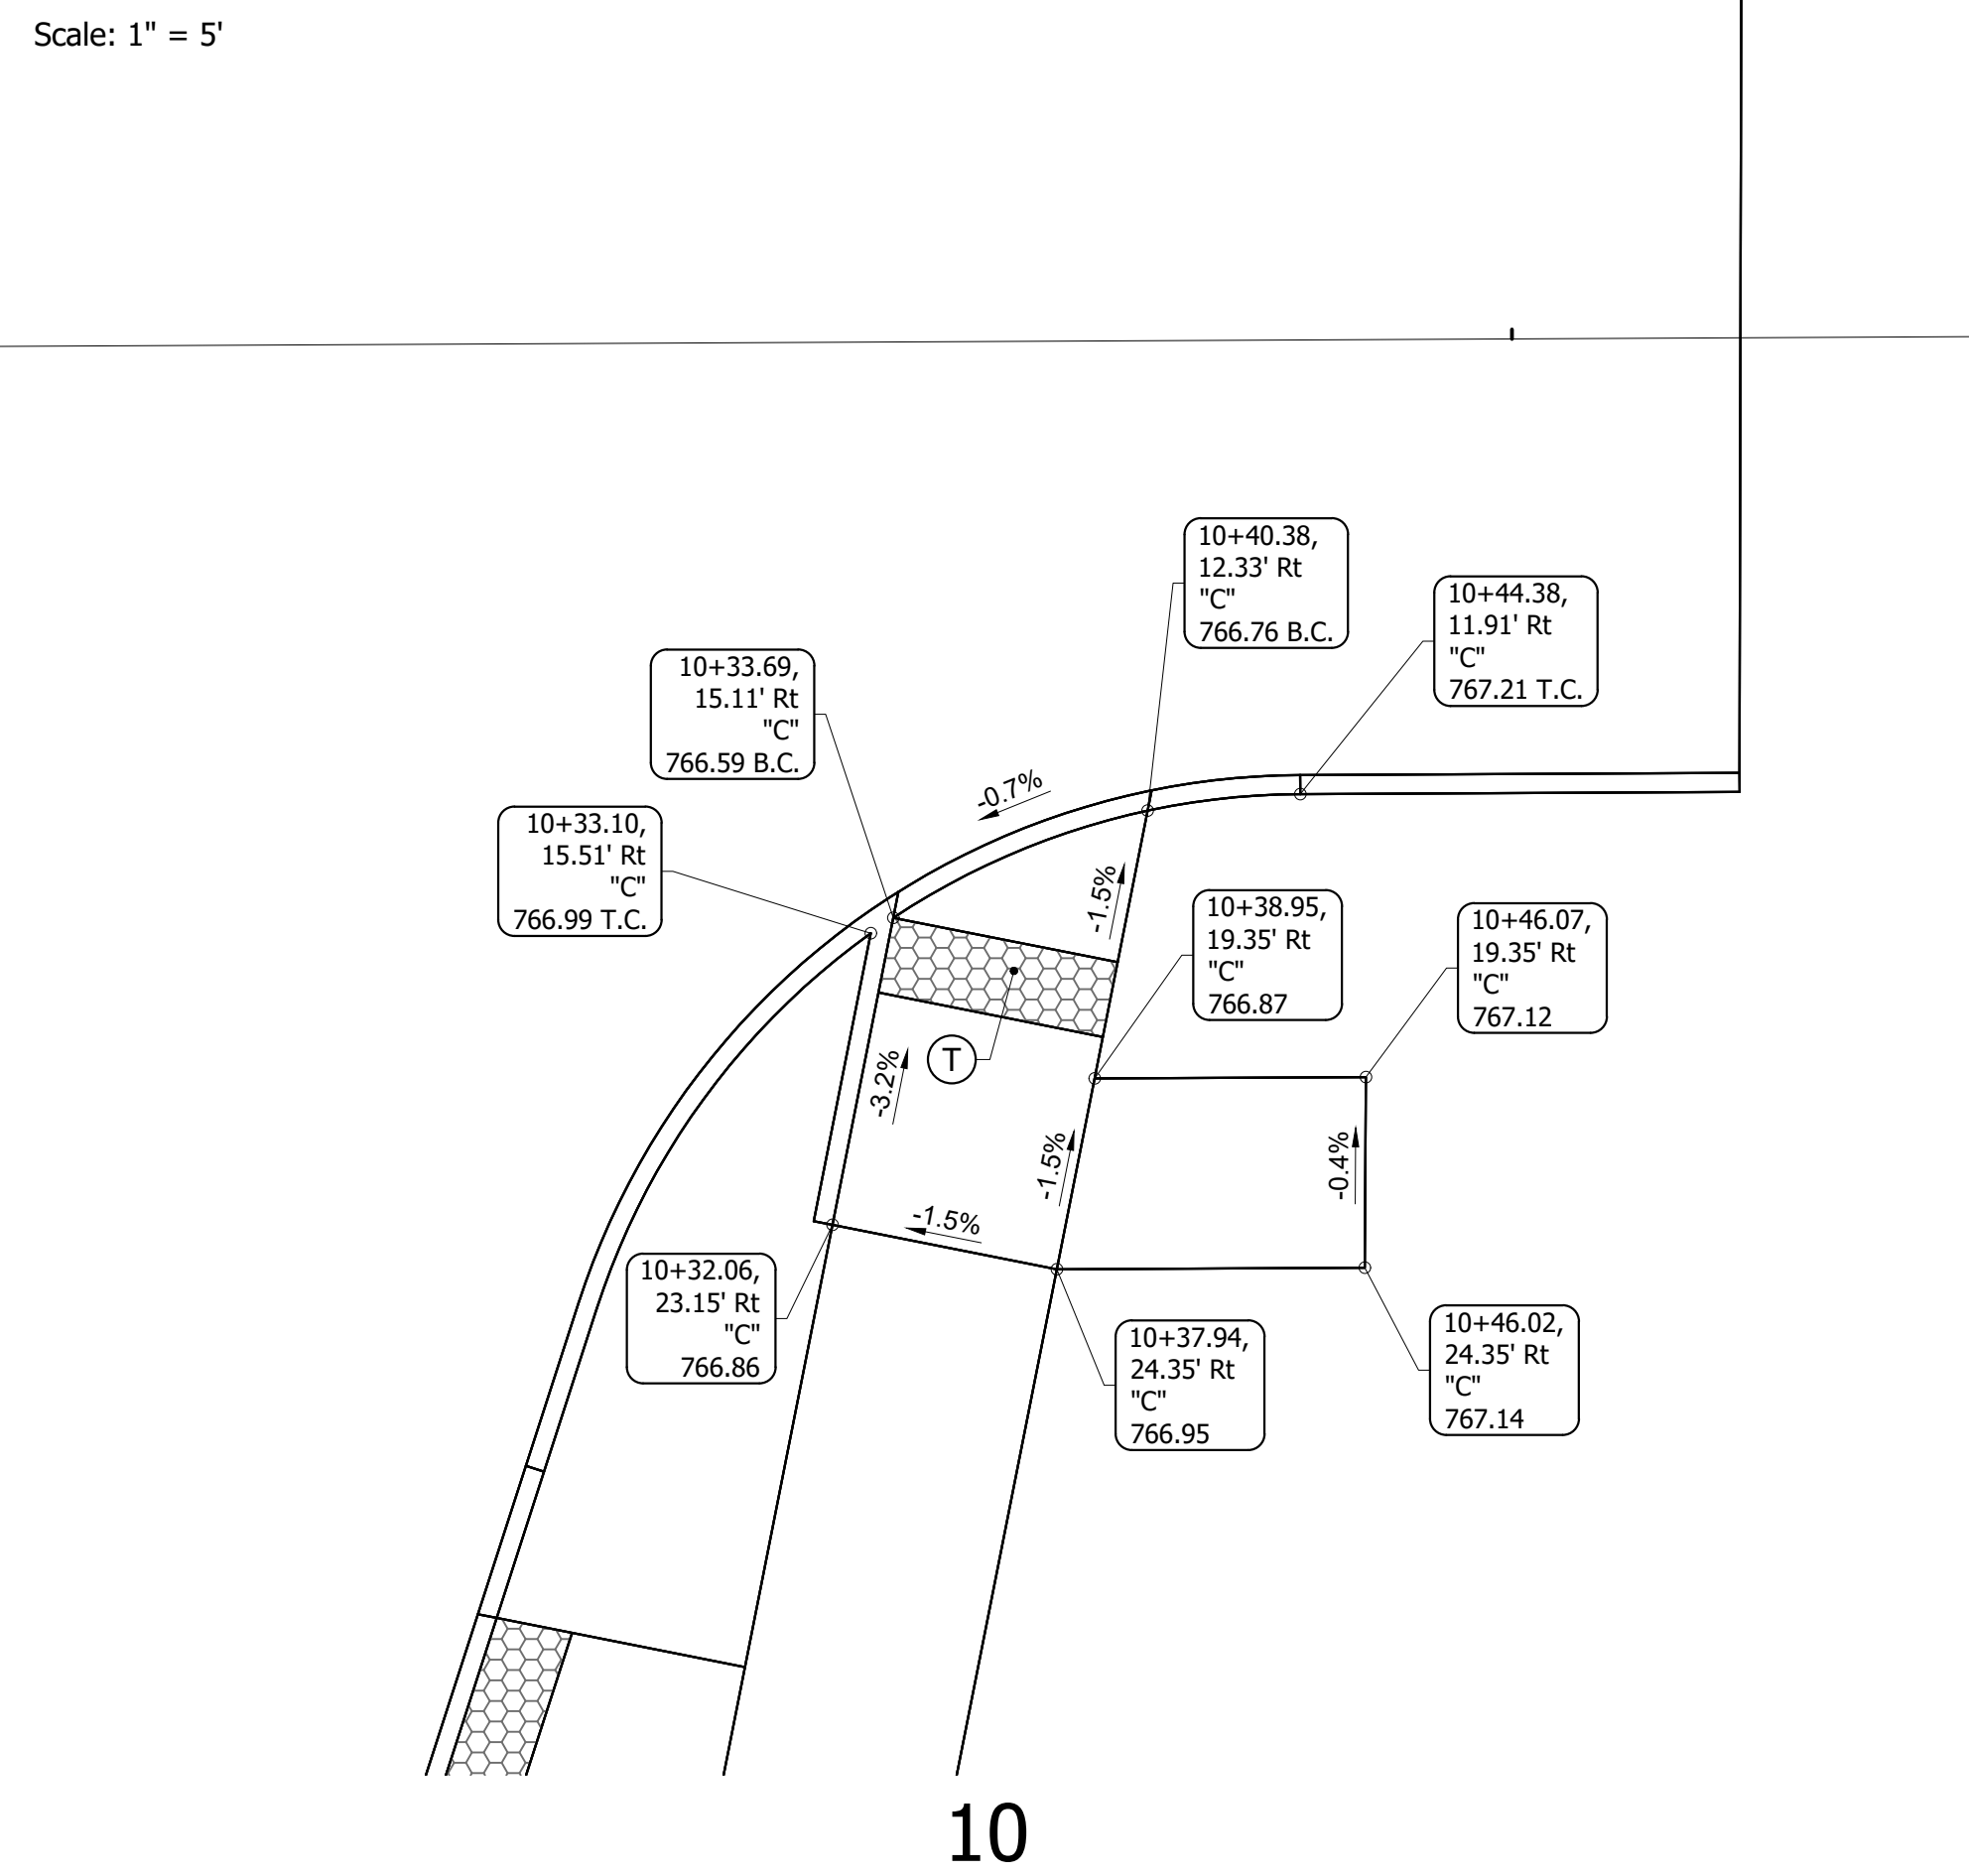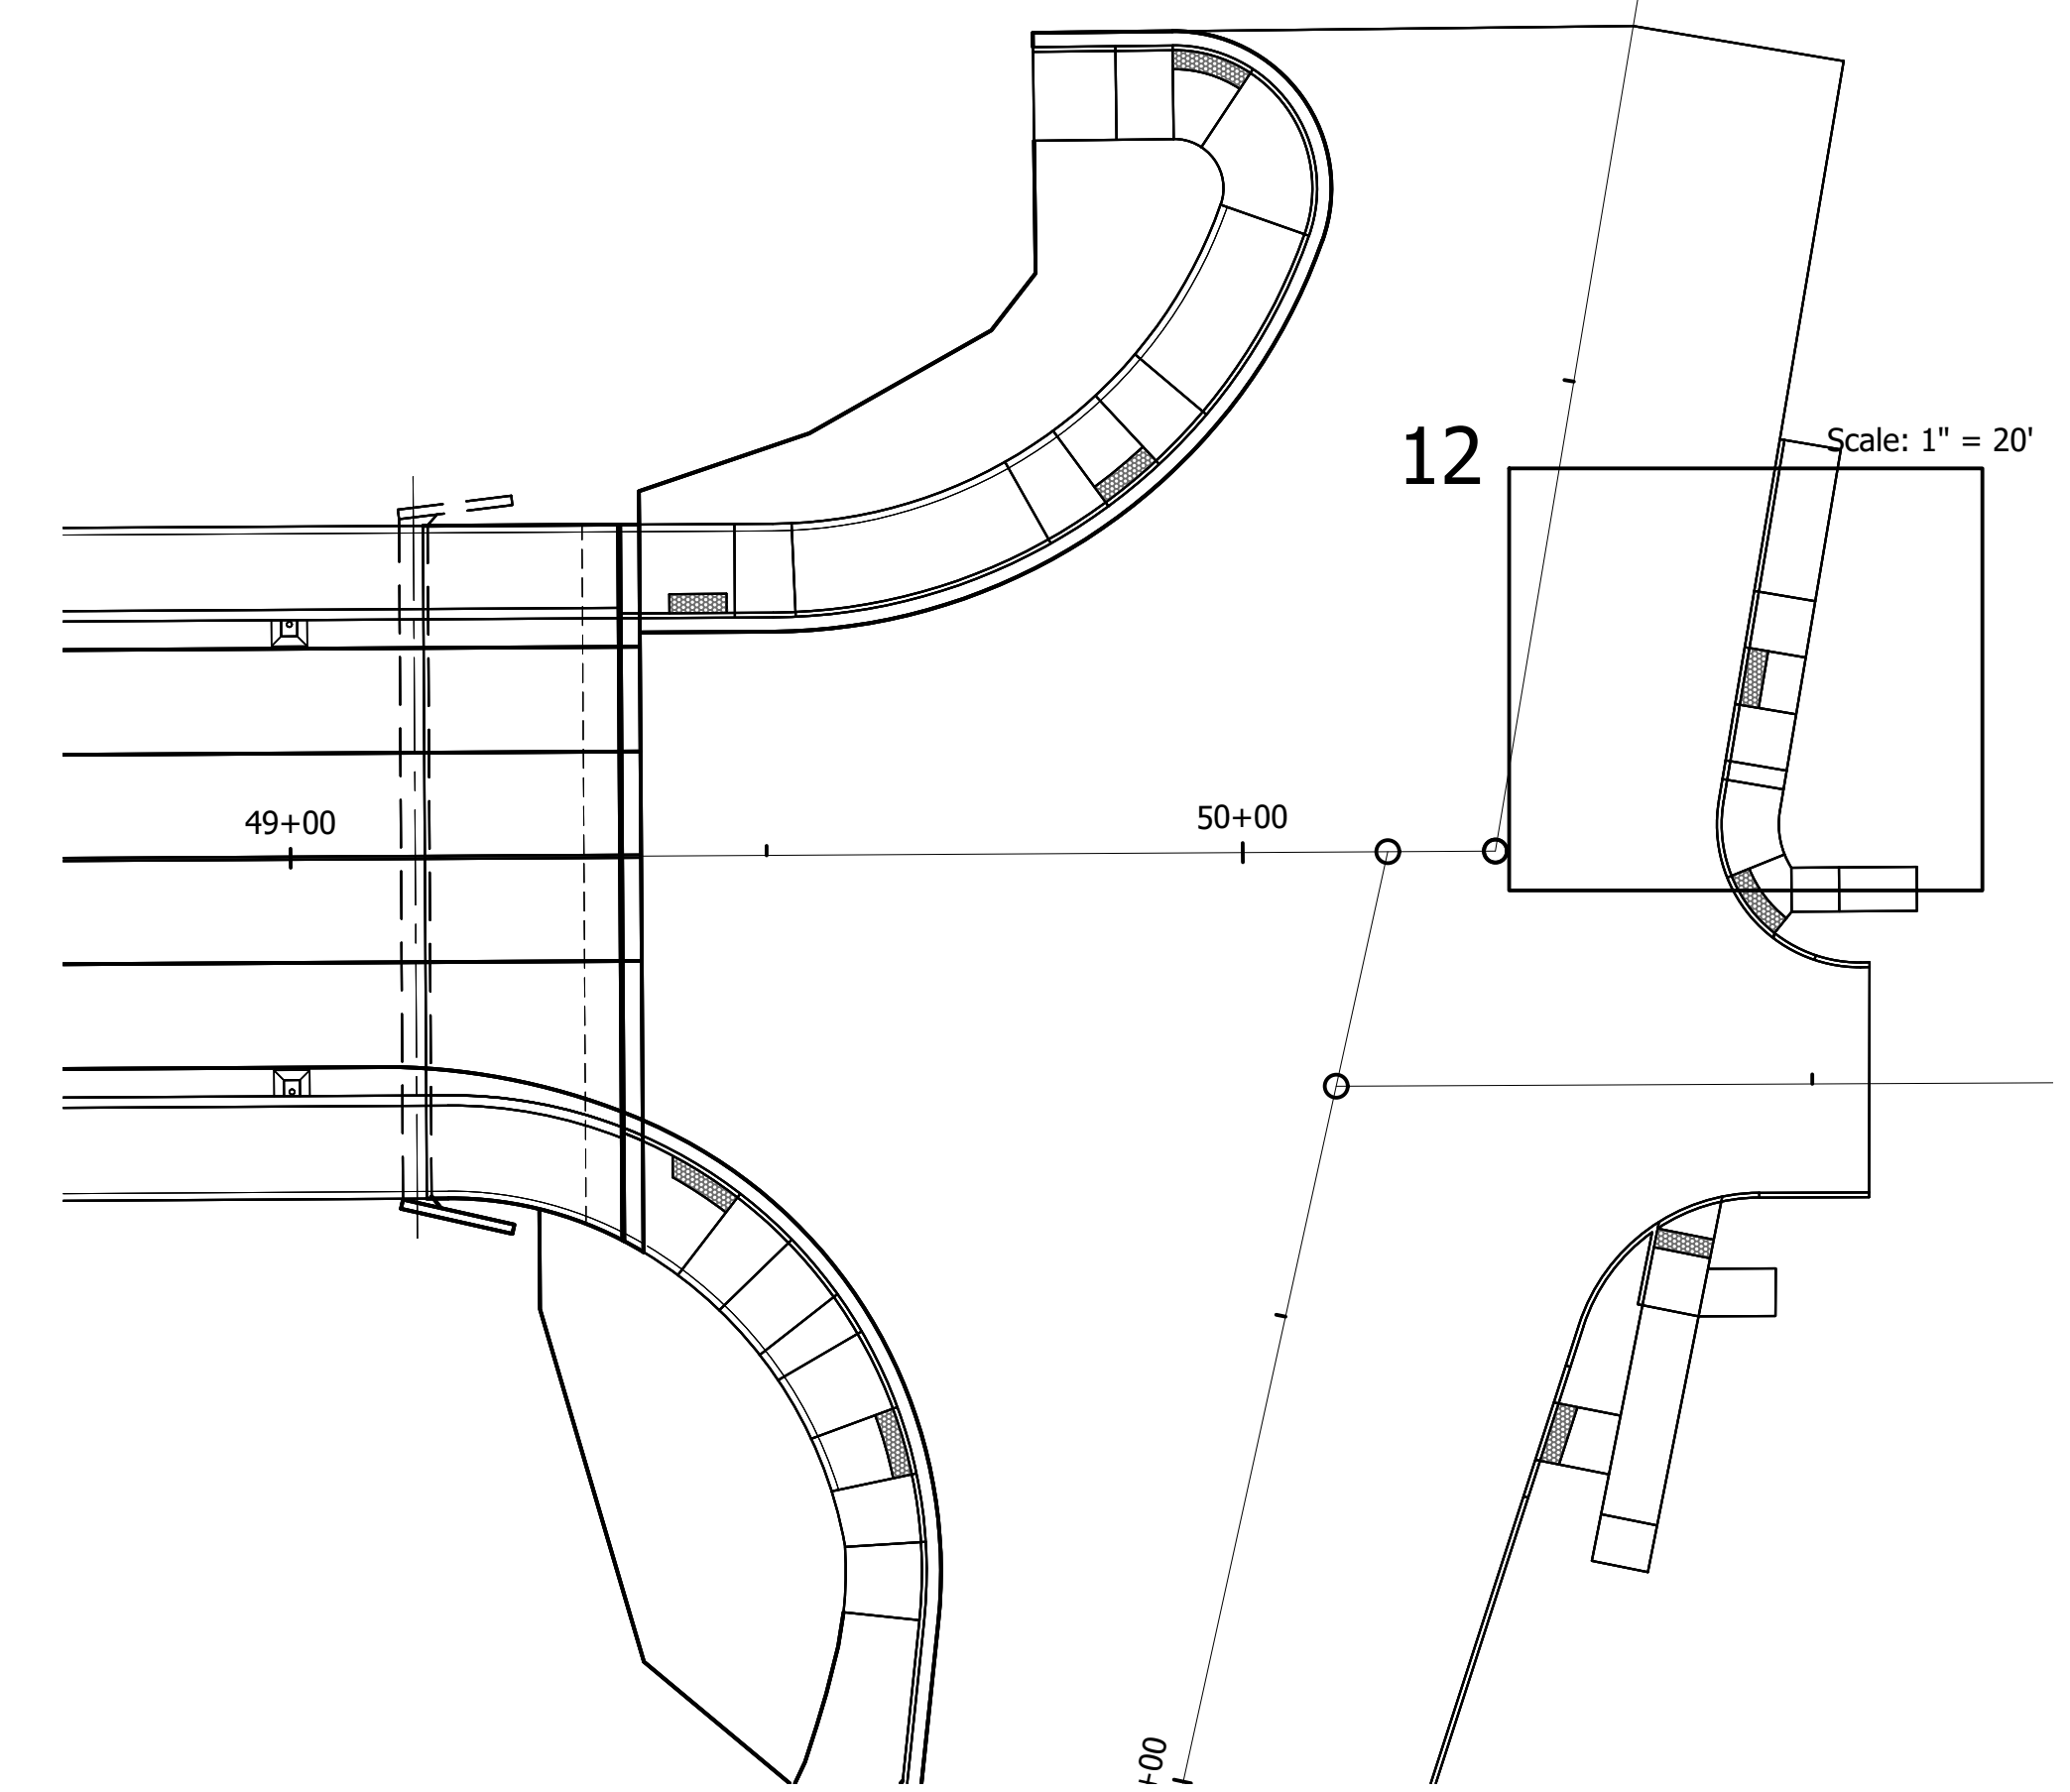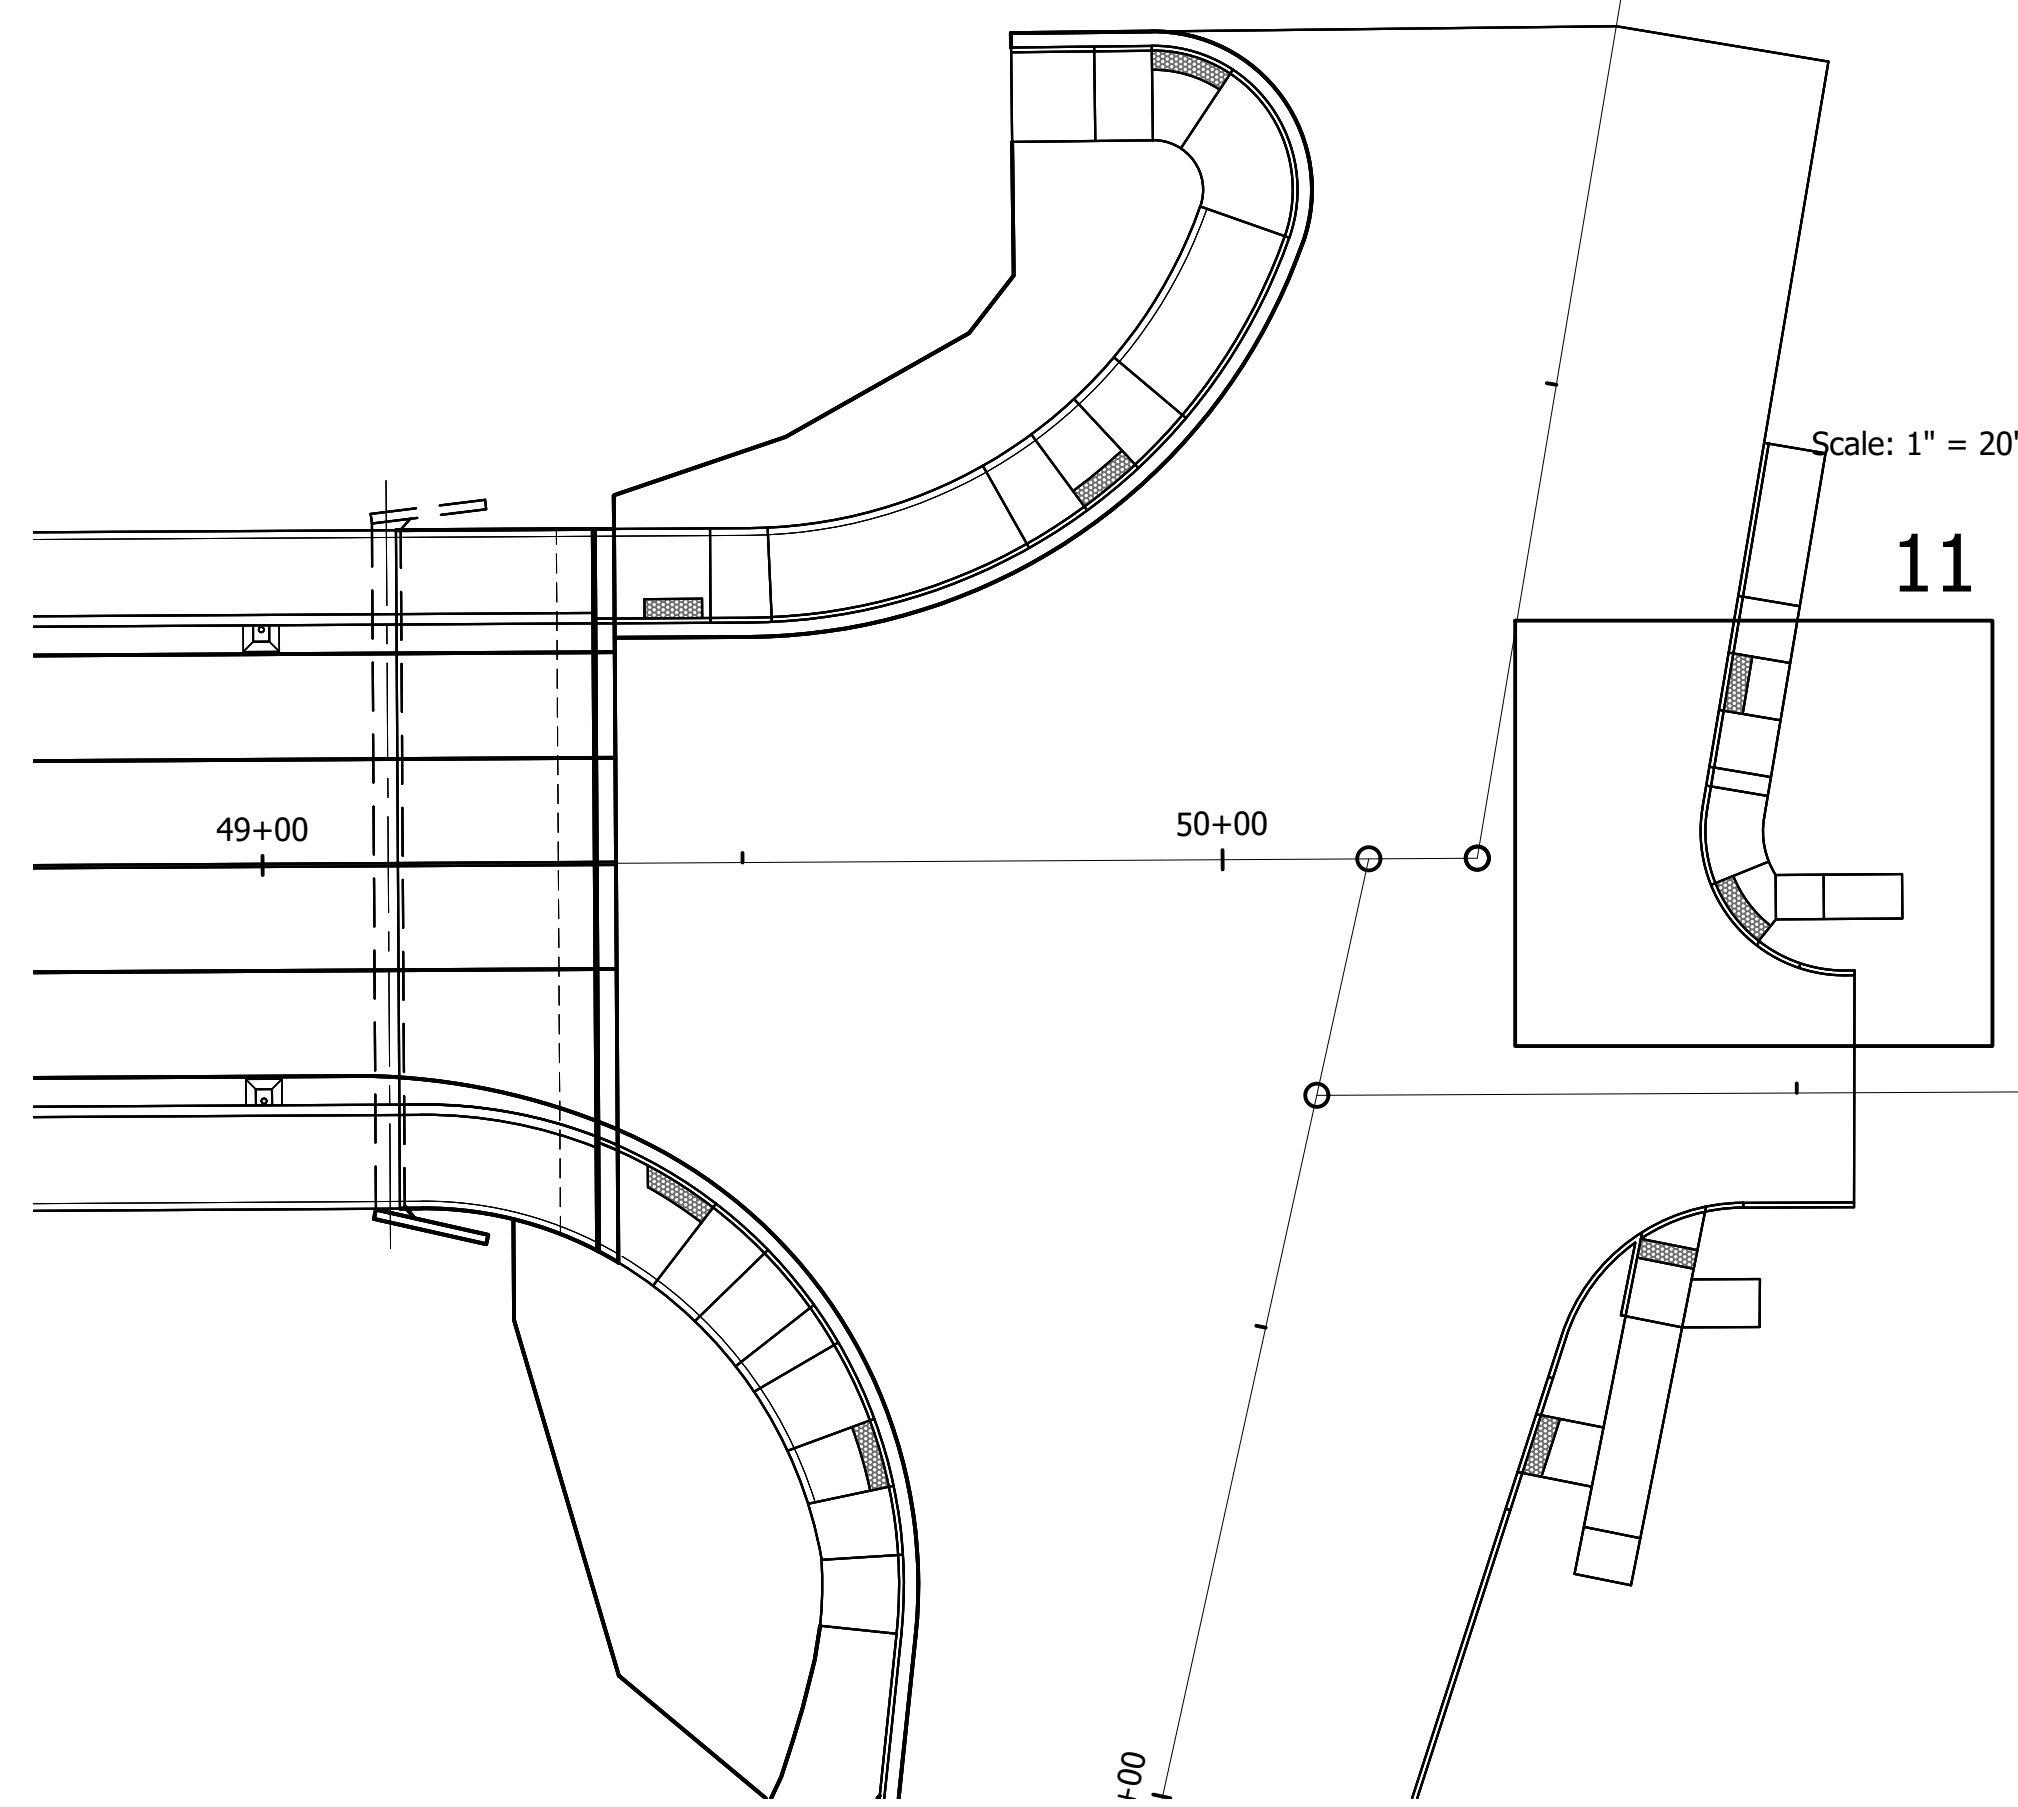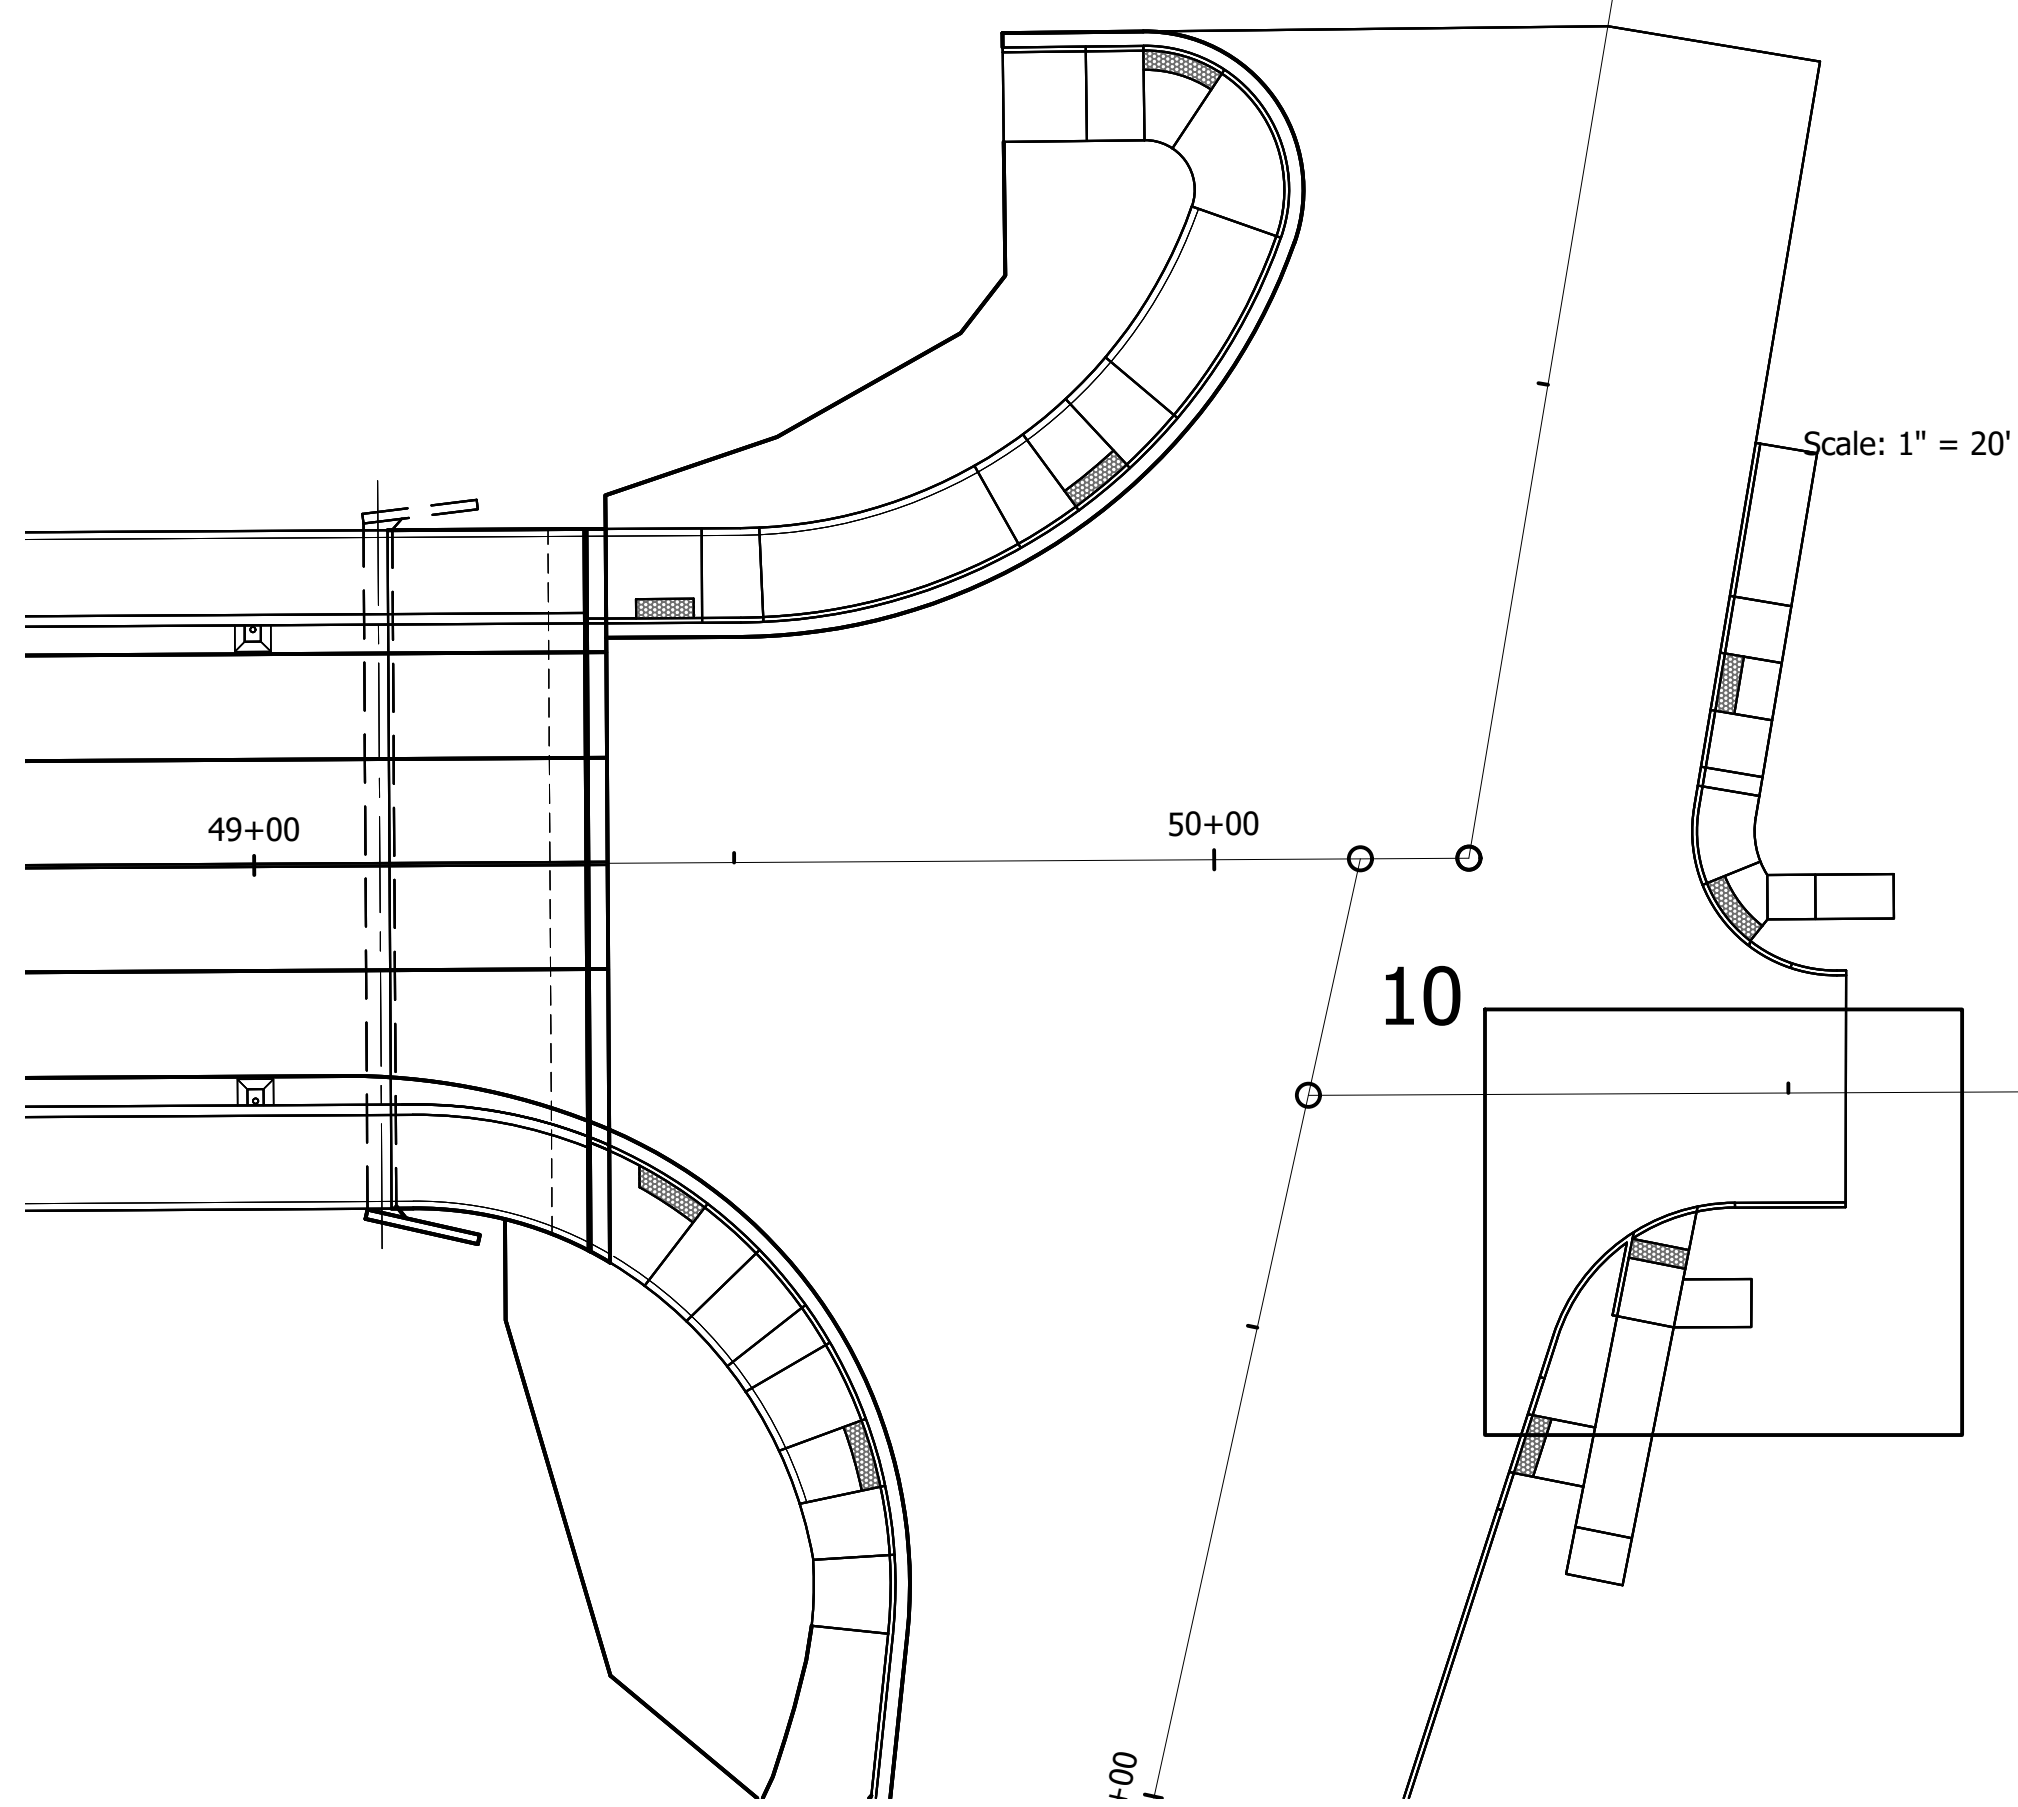

- LEGEND**
- (T) Detectable Warning Surface
 - (C) Required Curb
 - E.P. = Edge of Pavement
 - B.C. = Bottom of Curb
 - T.C. = Top of Curb


NOT FOR CONSTRUCTION

DESIGNED: BMA	DRAWN: CNC
CHECKED: KAM	CHECKED: BMA

**INDIANA
DEPARTMENT OF TRANSPORTATION**

**CURB RAMP DETAILS
BLUFFTON RD / BROADWAY**

HORIZONTAL SCALE AS NOTED	BRIDGE FILE ALLEN 358
VERTICAL SCALE N/A	DESIGNATION 1902834
SURVEY BOOK ----	SHEETS 24 of 63
CONTRACT B-42844	PROJECT 1902834

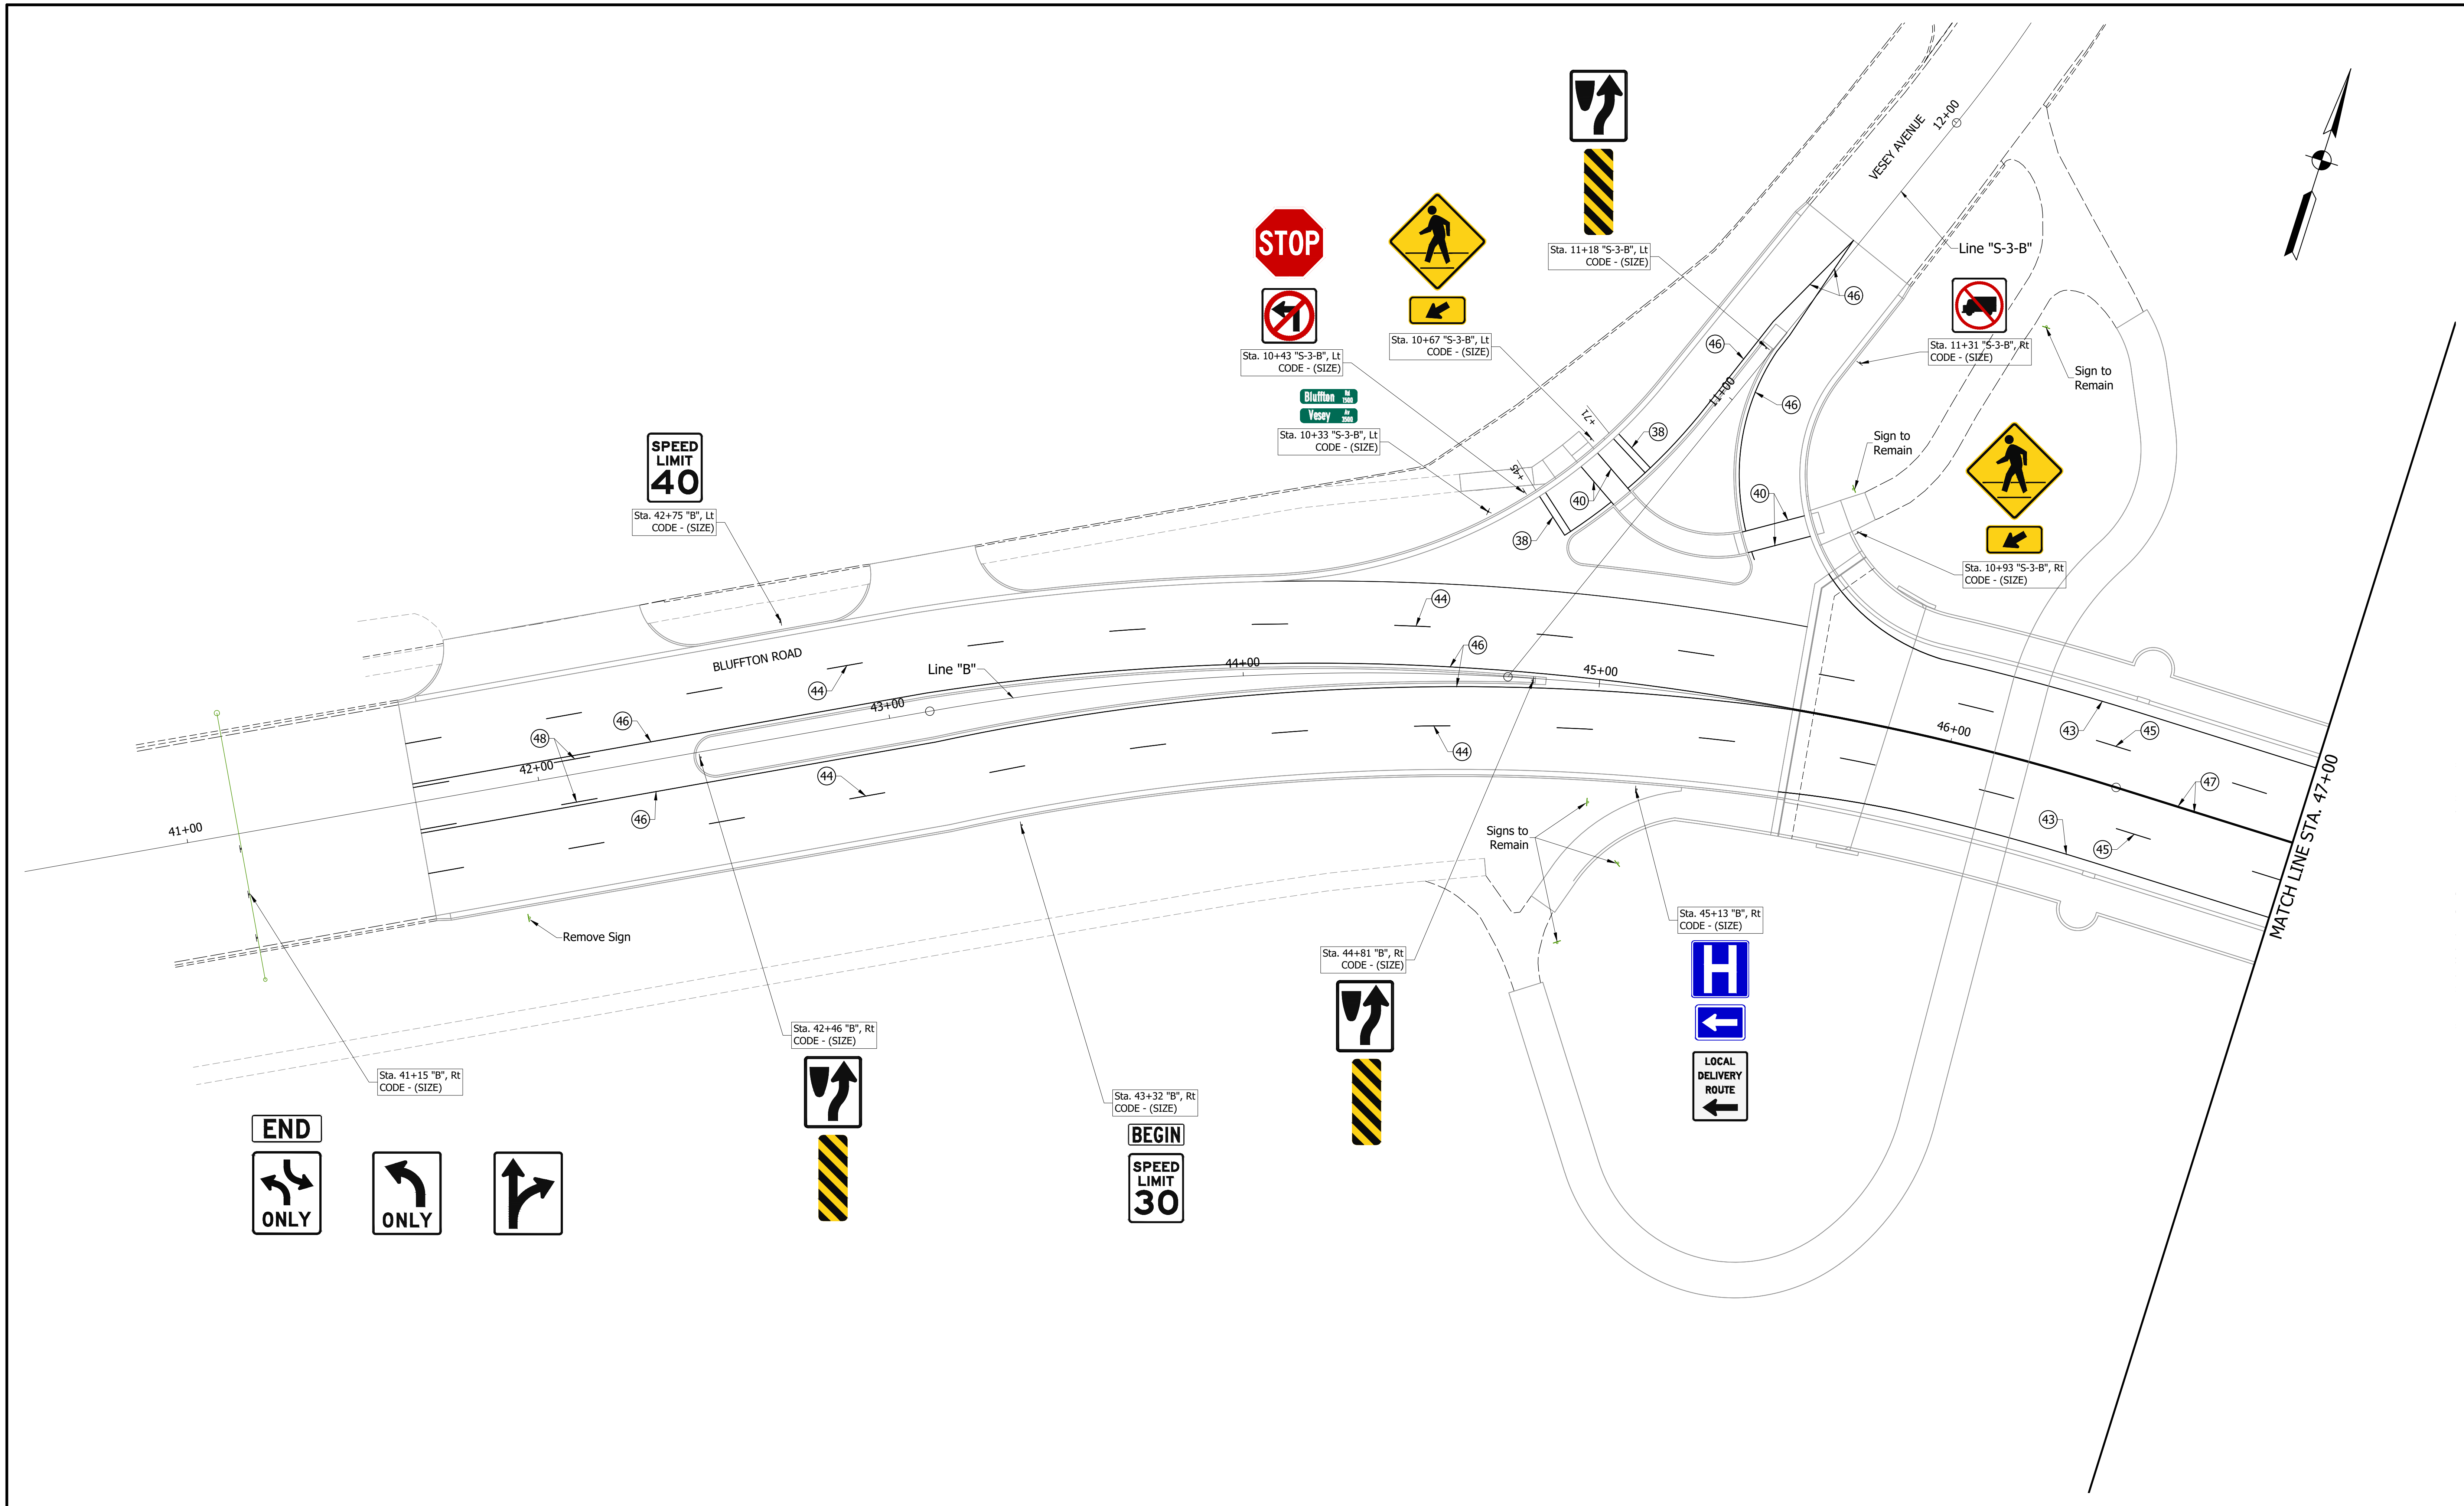

- | | | |
|--|--|--|
| ③⑥ Pavement Message Marking, Thermoplastic, Lane Indication Arrow | ④① Transverse Marking, Thermoplastic, Crosswalk Line, 6" | ④⑤ Line, Pre-Formed Plastic, Broken, White, 4" |
| ③⑦ Pavement Message Marking, Pre-Formed Plastic, Lane Indication Arrow | ④② Line, Thermoplastic, Solid, White, 4" | ④⑥ Line, Thermoplastic, Solid, Yellow, 4" |
| ③⑧ Transverse Marking, Thermoplastic, Stop Line, 24" | ④③ Line, Pre-Formed Plastic, Solid, White, 4" | ④⑦ Line, Pre-Formed Plastic, Solid, Yellow, 4" |
| ③⑨ Transverse Marking, Pre-Formed Plastic, Stop Line, 24" | ④④ Line, Thermoplastic, Broken, White, 4" | ④⑧ Line, Thermoplastic, Broken, Yellow, 4" |
| | | ④⑨ Line, Thermoplastic, Dotted, White, 8" |



NOT FOR CONSTRUCTION

DESIGNED: BMA	DRAWN: CNC
CHECKED: KAM	CHECKED: BMA

**INDIANA
DEPARTMENT OF TRANSPORTATION**

**PAVEMENT MARKINGS & SIGNING DETAILS
BLUFFTON RD / BROADWAY**

HORIZONTAL SCALE 1" = 20'	BRIDGE FILE ALLEN 358
VERTICAL SCALE N/A	DESIGNATION 1902834
SURVEY BOOK ---	SHEETS 25 of 63
CONTRACT B-42844	PROJECT 1902834

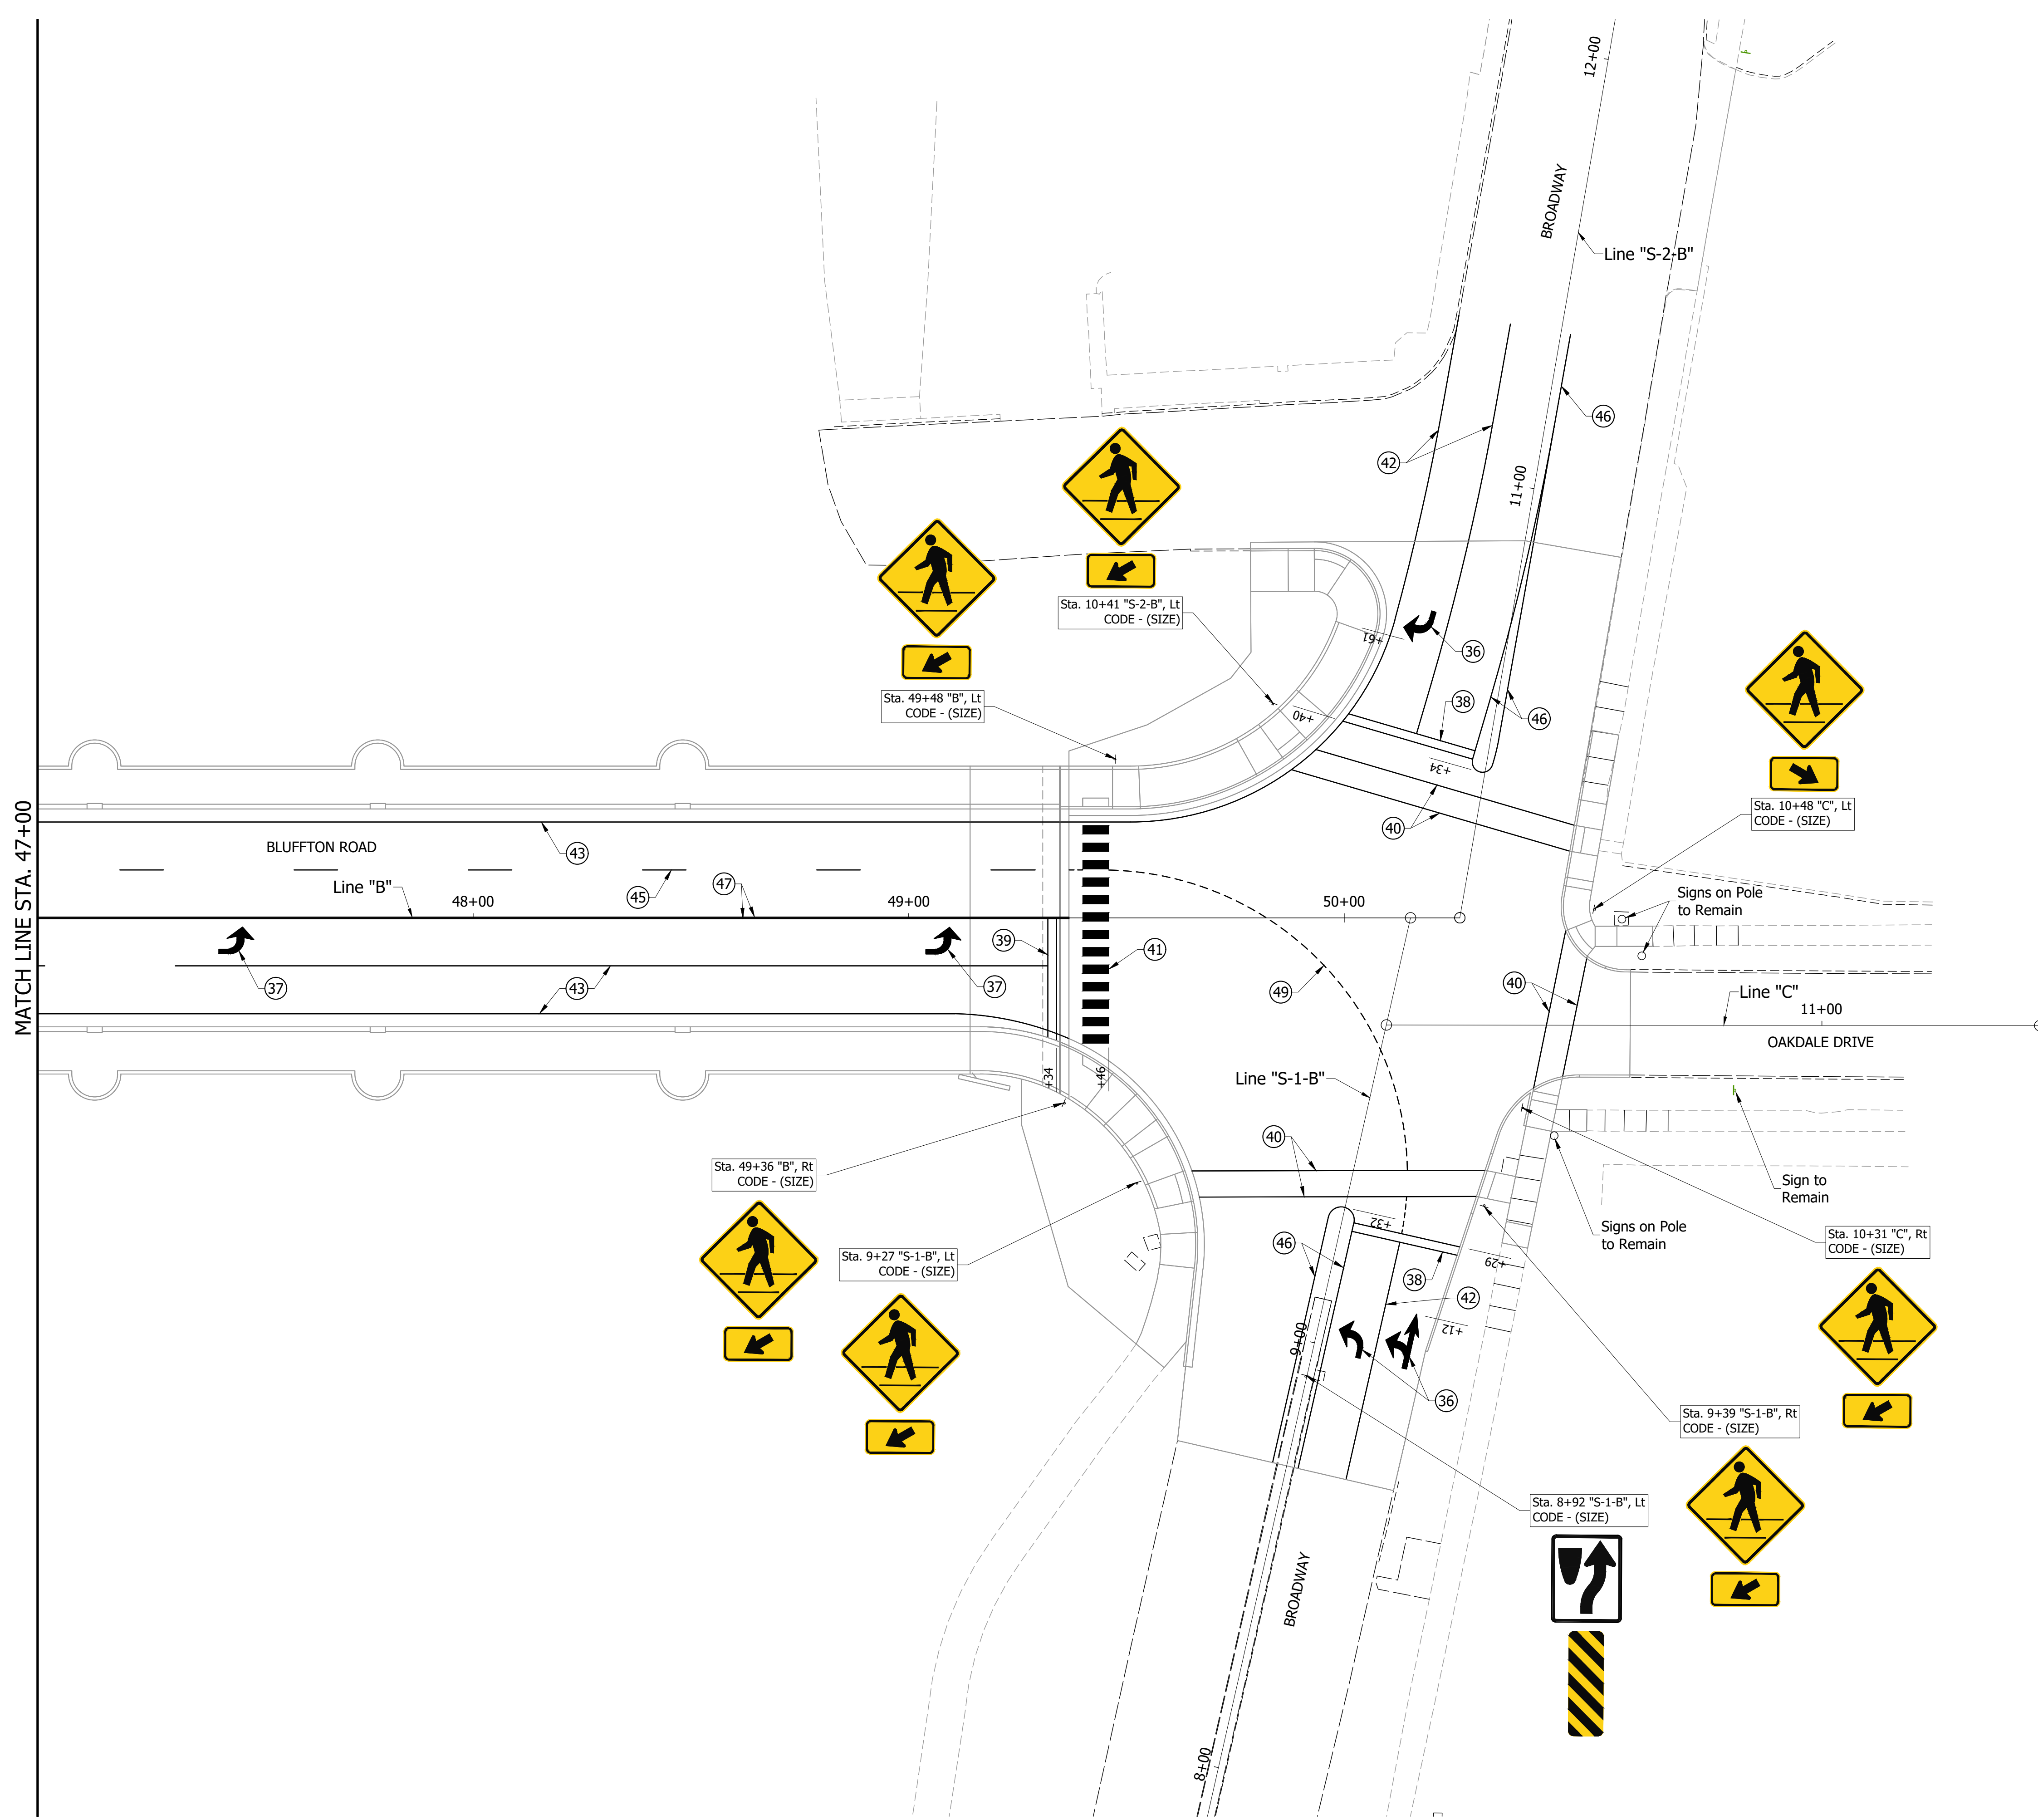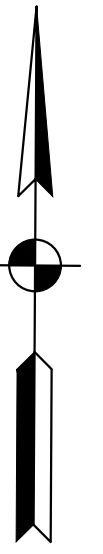

MATCH LINE STA. 47+00

- | | | |
|--|---|--|
| <ul style="list-style-type: none"> ③6 Pavement Message Marking, Thermoplastic, Lane Indication Arrow ③7 Pavement Message Marking, Pre-Formed Plastic, Lane Indication Arrow ③8 Transverse Marking, Thermoplastic, Stop Line, 24" ③9 Transverse Marking, Pre-Formed Plastic, Stop Line, 24" | <ul style="list-style-type: none"> ④0 Transverse Marking, Thermoplastic, Crosswalk Line, 6" ④1 Transverse Marking, Thermoplastic, Crosswalk Line, 24" ④2 Line, Thermoplastic, Solid, White, 4" ④3 Line, Pre-Formed Plastic, Solid, White, 4" ④4 Line, Thermoplastic, Broken, White, 4" | <ul style="list-style-type: none"> ④5 Line, Pre-Formed Plastic, Broken, White, 4" ④6 Line, Thermoplastic, Solid, Yellow, 4" ④7 Line, Pre-Formed Plastic, Solid, Yellow, 4" ④8 Line, Thermoplastic, Broken, Yellow, 4" ④9 Line, Thermoplastic, Dotted, White, 8" |
|--|---|--|


NOT FOR CONSTRUCTION

DESIGNED: _____ BMA	DRAWN: _____ CNC
CHECKED: _____ KAM	CHECKED: _____ BMA

**INDIANA
DEPARTMENT OF TRANSPORTATION**

**PAVEMENT MARKINGS & SIGNING DETAILS
BLUFFTON RD / BROADWAY**

HORIZONTAL SCALE 1" = 20'	BRIDGE FILE ALLEN 358
VERTICAL SCALE N/A	DESIGNATION 1902834
SURVEY BOOK ----	SHEETS 26 of 63
CONTRACT B-42844	PROJECT 1902834

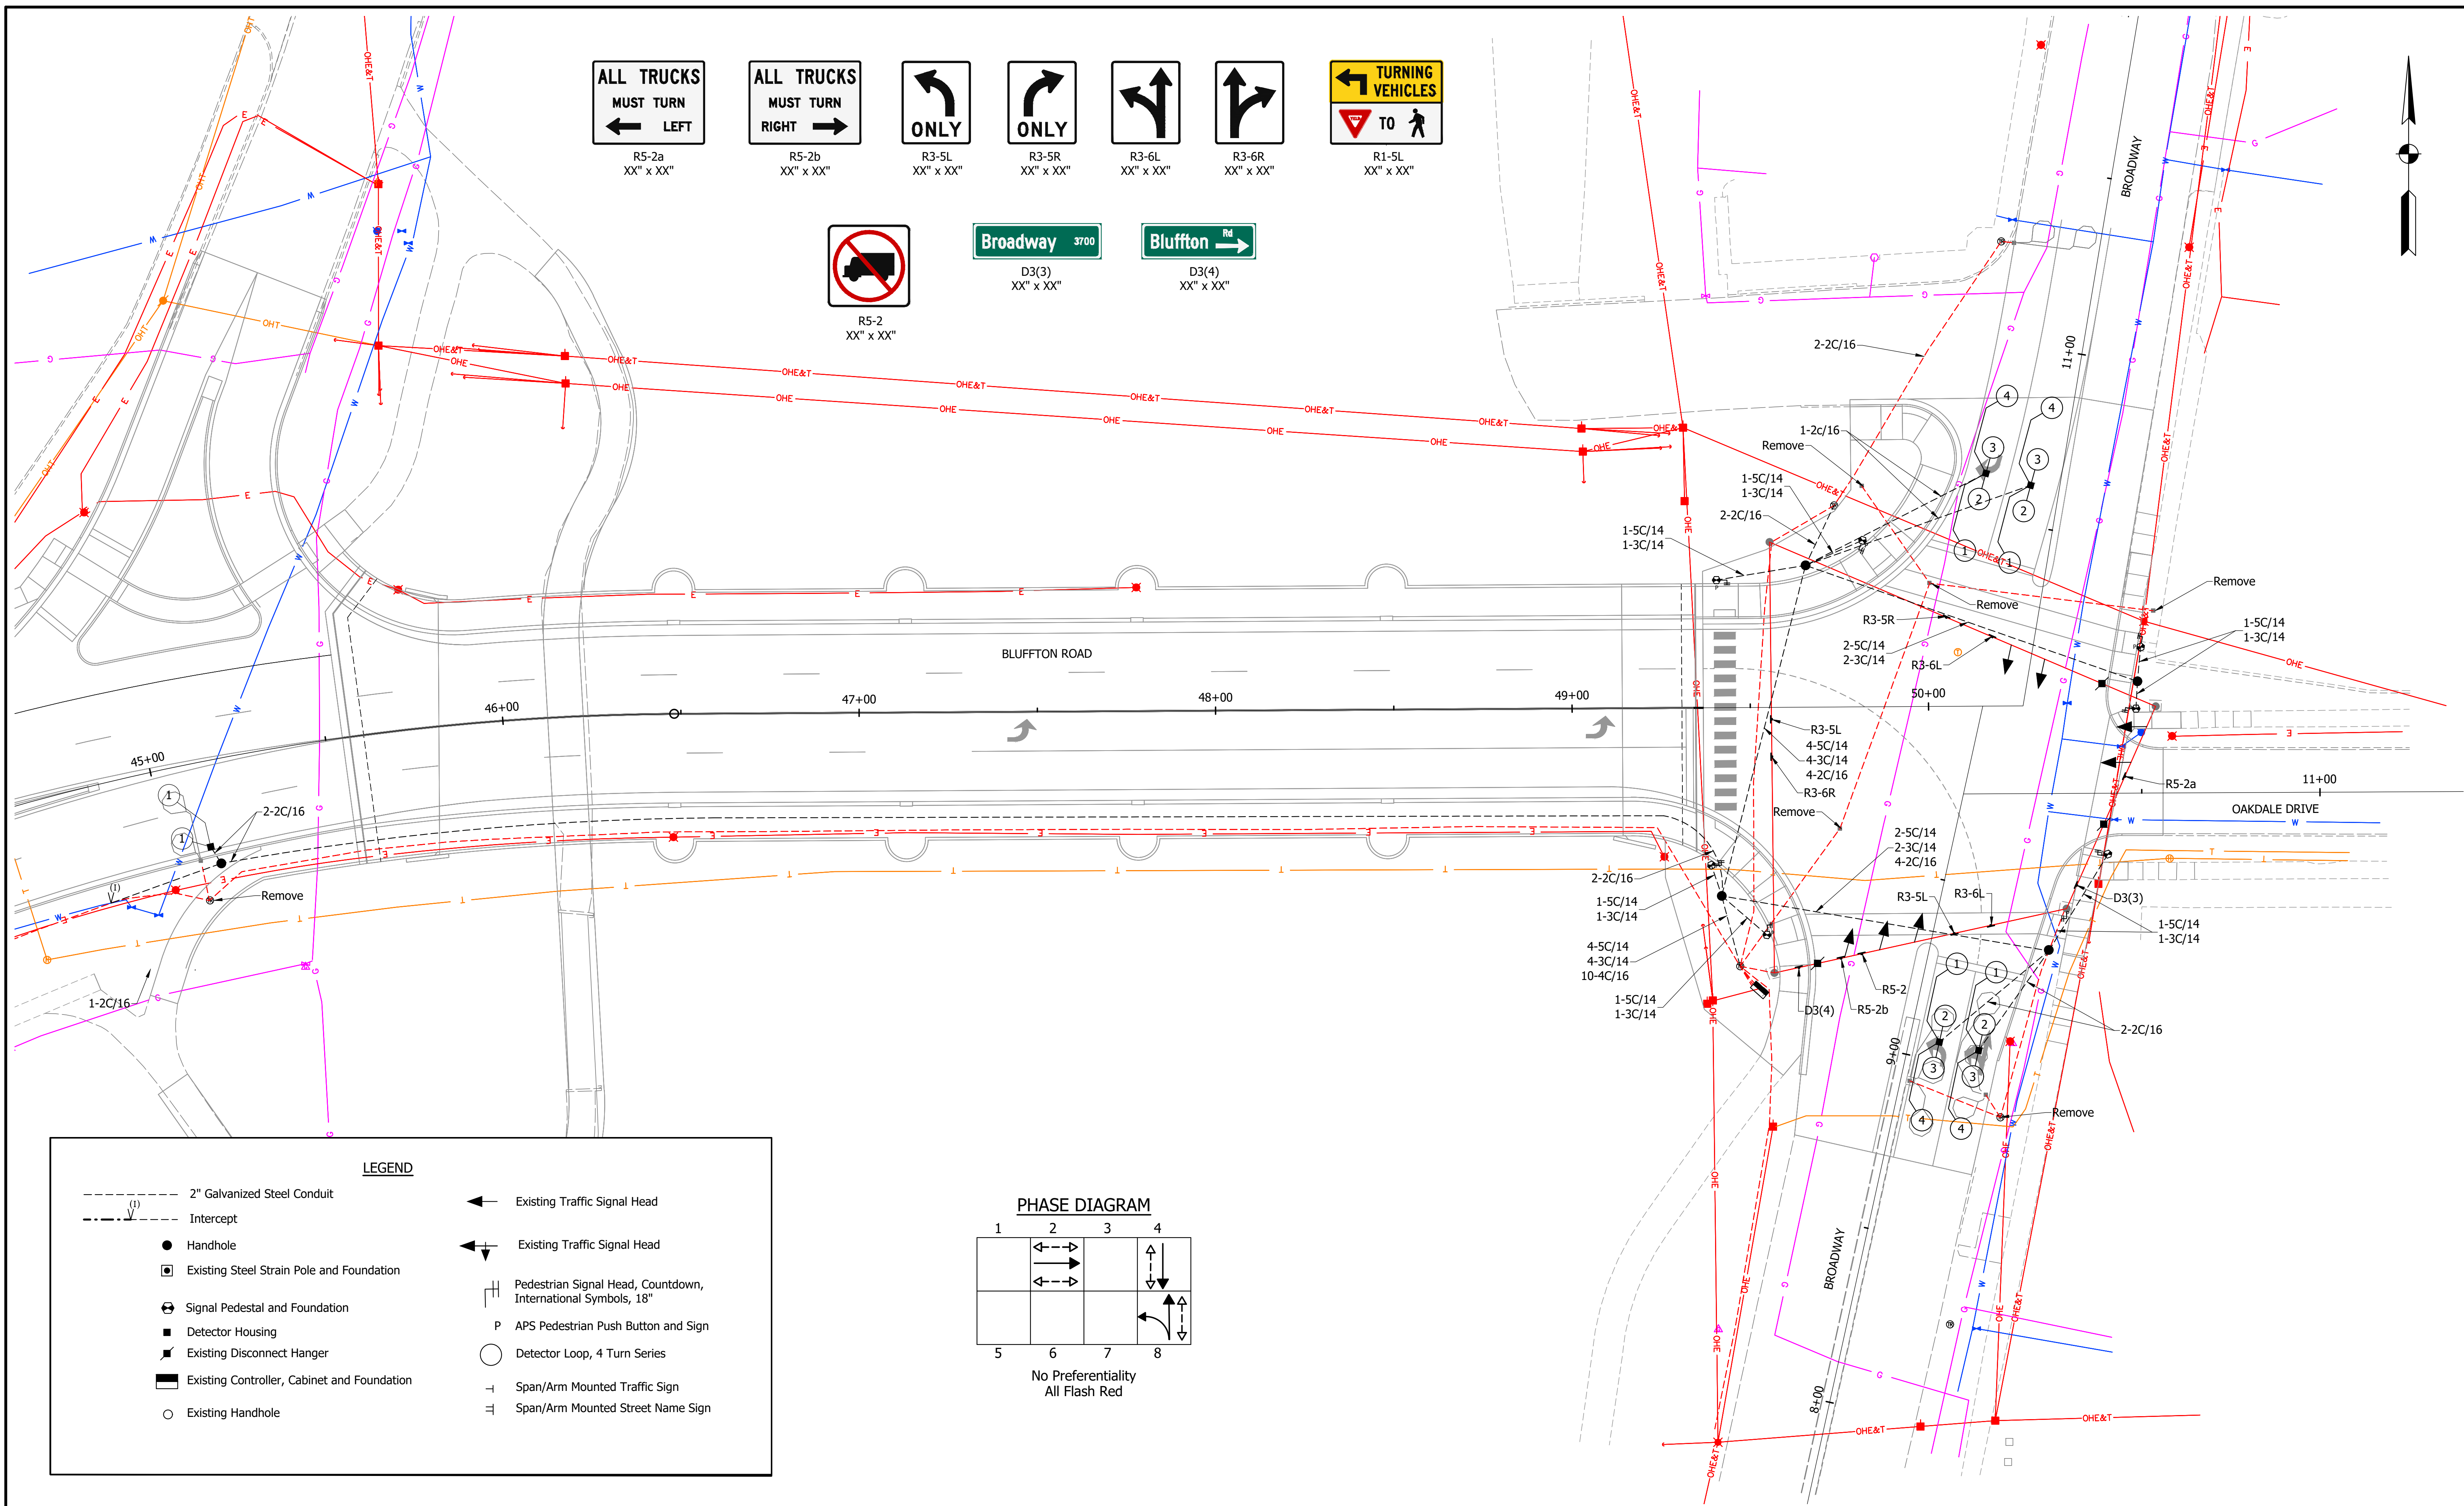

- ALL TRUCKS
MUST TURN
LEFT**

R5-2a
XX" x XX"
- ALL TRUCKS
MUST TURN
RIGHT**

R5-2b
XX" x XX"
- ONLY**

R3-5L
XX" x XX"
- ONLY**

R3-5R
XX" x XX"
- R3-6L
XX" x XX"
- R3-6R
XX" x XX"
- TURNING
VEHICLES
TO**

R1-5L
XX" x XX"


- R5-2
XX" x XX"
- Broadway** 3700

D3(3)
XX" x XX"
- Bluffton Rd**

D3(4)
XX" x XX"

LEGEND

<ul style="list-style-type: none"> 2" Galvanized Steel Conduit Intercept Handhole Existing Steel Strain Pole and Foundation Signal Pedestal and Foundation Detector Housing Existing Disconnect Hanger Existing Controller, Cabinet and Foundation Existing Handhole 	<ul style="list-style-type: none"> Existing Traffic Signal Head Existing Traffic Signal Head Pedestrian Signal Head, Countdown, International Symbols, 18" P APS Pedestrian Push Button and Sign Detector Loop, 4 Turn Series Span/Arm Mounted Traffic Sign Span/Arm Mounted Street Name Sign
--	---

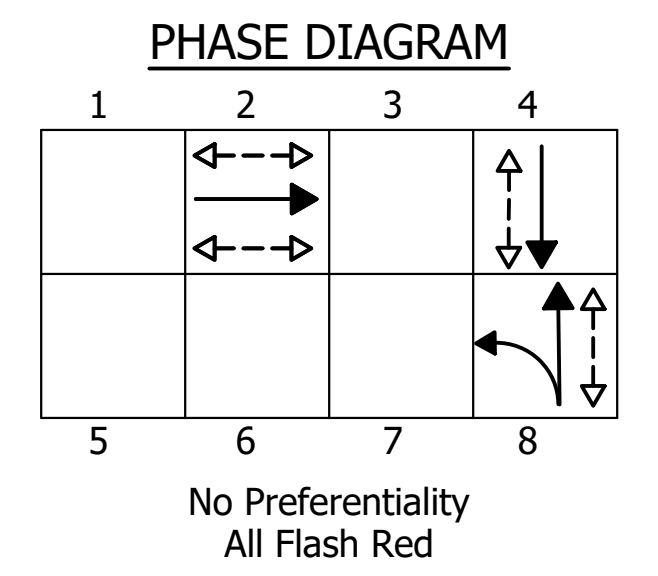

COLOR CODE FOR UTILITY LOCATIONS

ELECTRIC	SEWER (SANITARY)
GAS-OIL-STEAM	SEWER (STORM)
TELEPHONE-CATV	SEWER (COMBINATION)
WATER	PROPOSED CONSTRUCTION

NOT FOR CONSTRUCTION


DESIGNED: BMA	DRAWN: CNC
CHECKED: KAM	CHECKED: BMA

**INDIANA
DEPARTMENT OF TRANSPORTATION**

**SIGNAL PLAN
BLUFFTON RD / BROADWAY**

HORIZONTAL SCALE 1" = 20'	BRIDGE FILE ALLEN 358
VERTICAL SCALE N/A	DESIGNATION 1902834
SURVEY BOOK ----	SHEETS 27 of 63
CONTRACT B-42844	PROJECT 1902834

POLE AND LUMINAIRE SCHEDULE										
Luminaire No.	1	2	3	4	5	6	7	8	9	10
Alignment Designation	"B"	"B"	"B"	"B"	"B"	"B"	"B"	"B"	"B"	"B"
Station	46+48.10	47+13.10	47+78.10	48+48.10	46+48.10	47+13.10	47+78.10	48+48.10	46+17.47	46+17.73
Offset	25.62	25.62	25.62	25.62	25.62	25.62	25.62	25.62	20.32	20.32
Left or Right	Lt	Lt	Lt	Lt	Rt	Rt	Rt	Rt	Lt	Rt
Circuit Label	A-1			A-2			A-3			
Circuit Connection Red (R) or Black (B)	R	B	R	B	B	R	B	R	B	B
Top of Foundation Elevation	Ft. -									
Luminaire Mounting Height	Ft. -									
Mast Arm Length	In. Dual Arms, 17.75									
Pole Size	Ft. 14.0 X 13.0 x 5.0									
Pole Base Type (AN, BK TR, SP)	Anchor Base									Tenon Mount

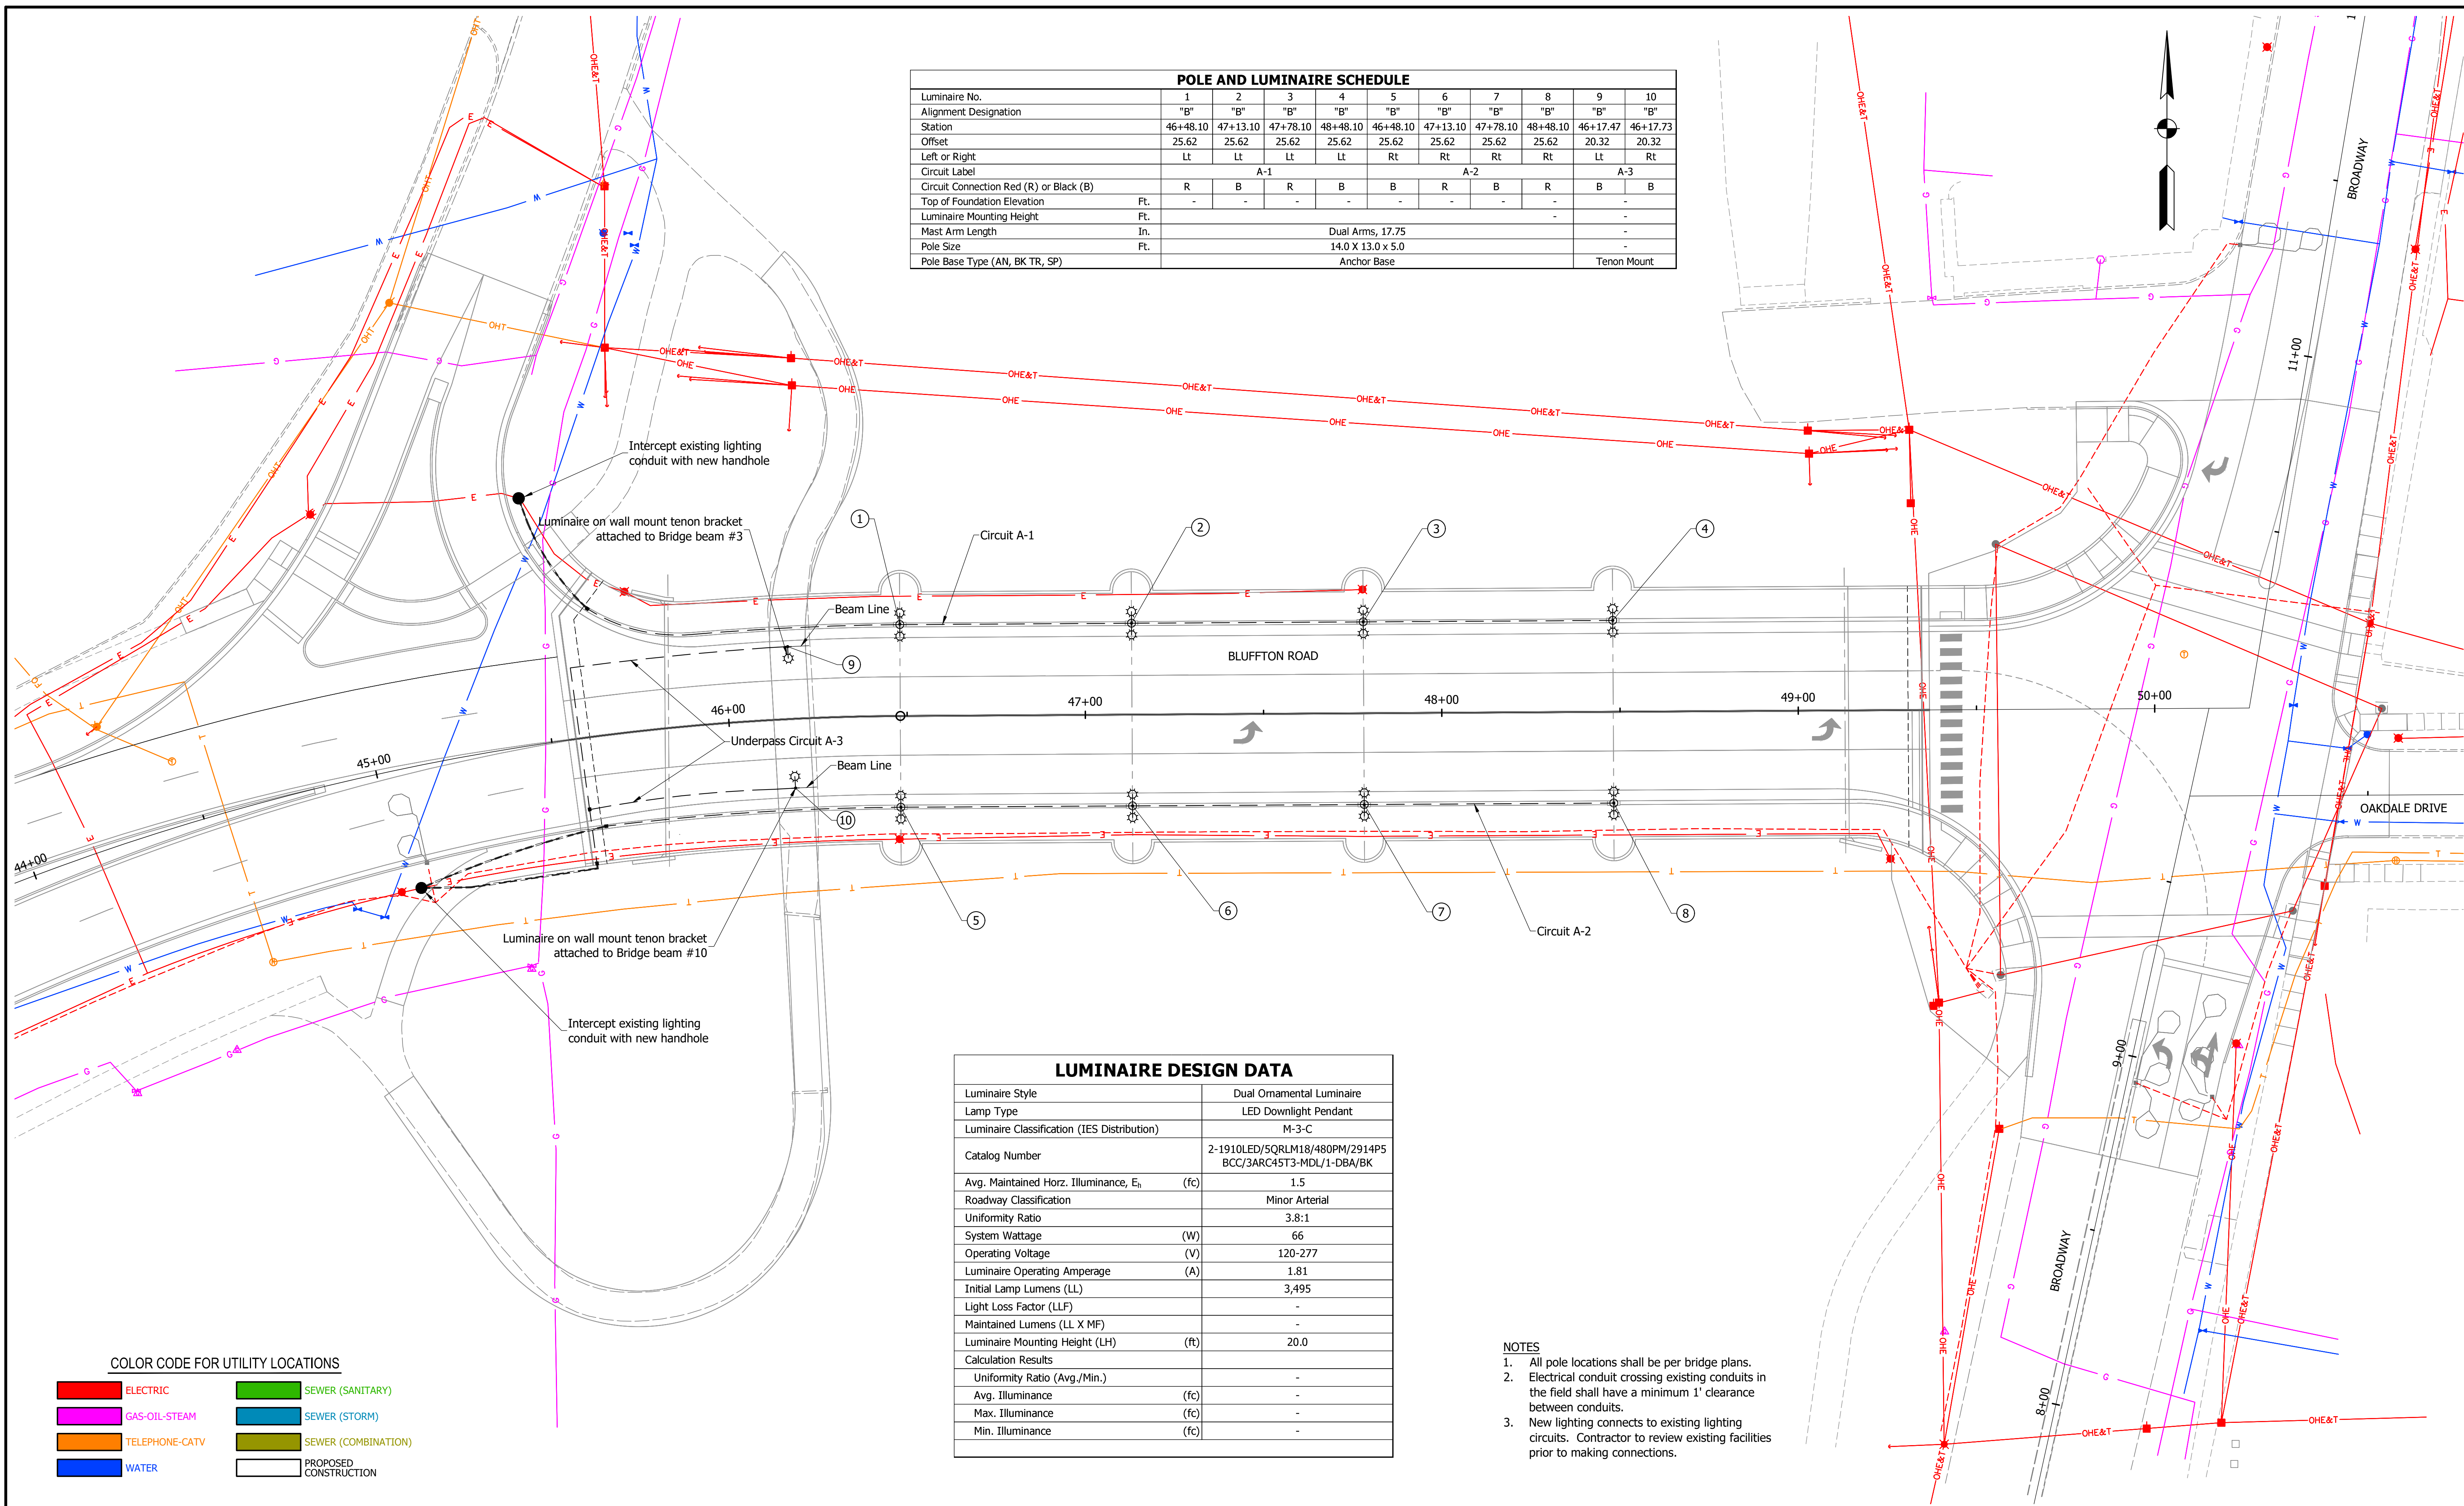

LUMINAIRE DESIGN DATA	
Luminaire Style	Dual Ornamental Luminaire
Lamp Type	LED Downlight Pendant
Luminaire Classification (IES Distribution)	M-3-C
Catalog Number	2-1910LED/SQRLM18/480PM/2914P5 BCC/3ARC45T3-MDL/1-DBA/BK
Avg. Maintained Horz. Illuminance, E _h (fc)	1.5
Roadway Classification	Minor Arterial
Uniformity Ratio	3.8:1
System Wattage (W)	66
Operating Voltage (V)	120-277
Luminaire Operating Amperage (A)	1.81
Initial Lamp Lumens (LL)	3,495
Light Loss Factor (LLF)	-
Maintained Lumens (LL X MF)	-
Luminaire Mounting Height (LH) (ft)	20.0
Calculation Results	
Uniformity Ratio (Avg./Min.)	-
Avg. Illuminance (fc)	-
Max. Illuminance (fc)	-
Min. Illuminance (fc)	-

- NOTES**
- All pole locations shall be per bridge plans.
 - Electrical conduit crossing existing conduits in the field shall have a minimum 1' clearance between conduits.
 - New lighting connects to existing lighting circuits. Contractor to review existing facilities prior to making connections.

COLOR CODE FOR UTILITY LOCATIONS

— ELECTRIC	— SEWER (SANITARY)
— GAS-OIL-STEAM	— SEWER (STORM)
— TELEPHONE-CATV	— SEWER (COMBINATION)
— WATER	 PROPOSED CONSTRUCTION

LEGEND

■ Pull Box, Polymer Concrete in Bridge Railing	⊙ Luminaire and Pole Number
● Handhole, Type II, Polymer Concrete unless noted otherwise	 2" Galvanized Steel Conduit
⊗ Luminaire and Wall Mount Tendon	 4-1/2" #4 Copper Wire in Plastic Duct in Conduit
⊗ Dual Ornamental Luminaires and Pole	



NOT FOR CONSTRUCTION

DESIGNED: BMA	DRAWN: CNC
CHECKED: KAM	CHECKED: BMA

INDIANA DEPARTMENT OF TRANSPORTATION

**LIGHTING PLAN
BLUFFTON RD / BROADWAY**

HORIZONTAL SCALE 1" = 20'	BRIDGE FILE ALLEN 358
VERTICAL SCALE N/A	DESIGNATION 1902834
SURVEY BOOK ---	SHEETS 28 of 63
CONTRACT B-42844	PROJECT 1902834

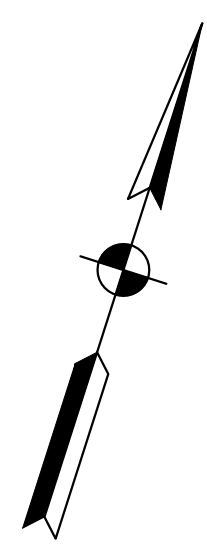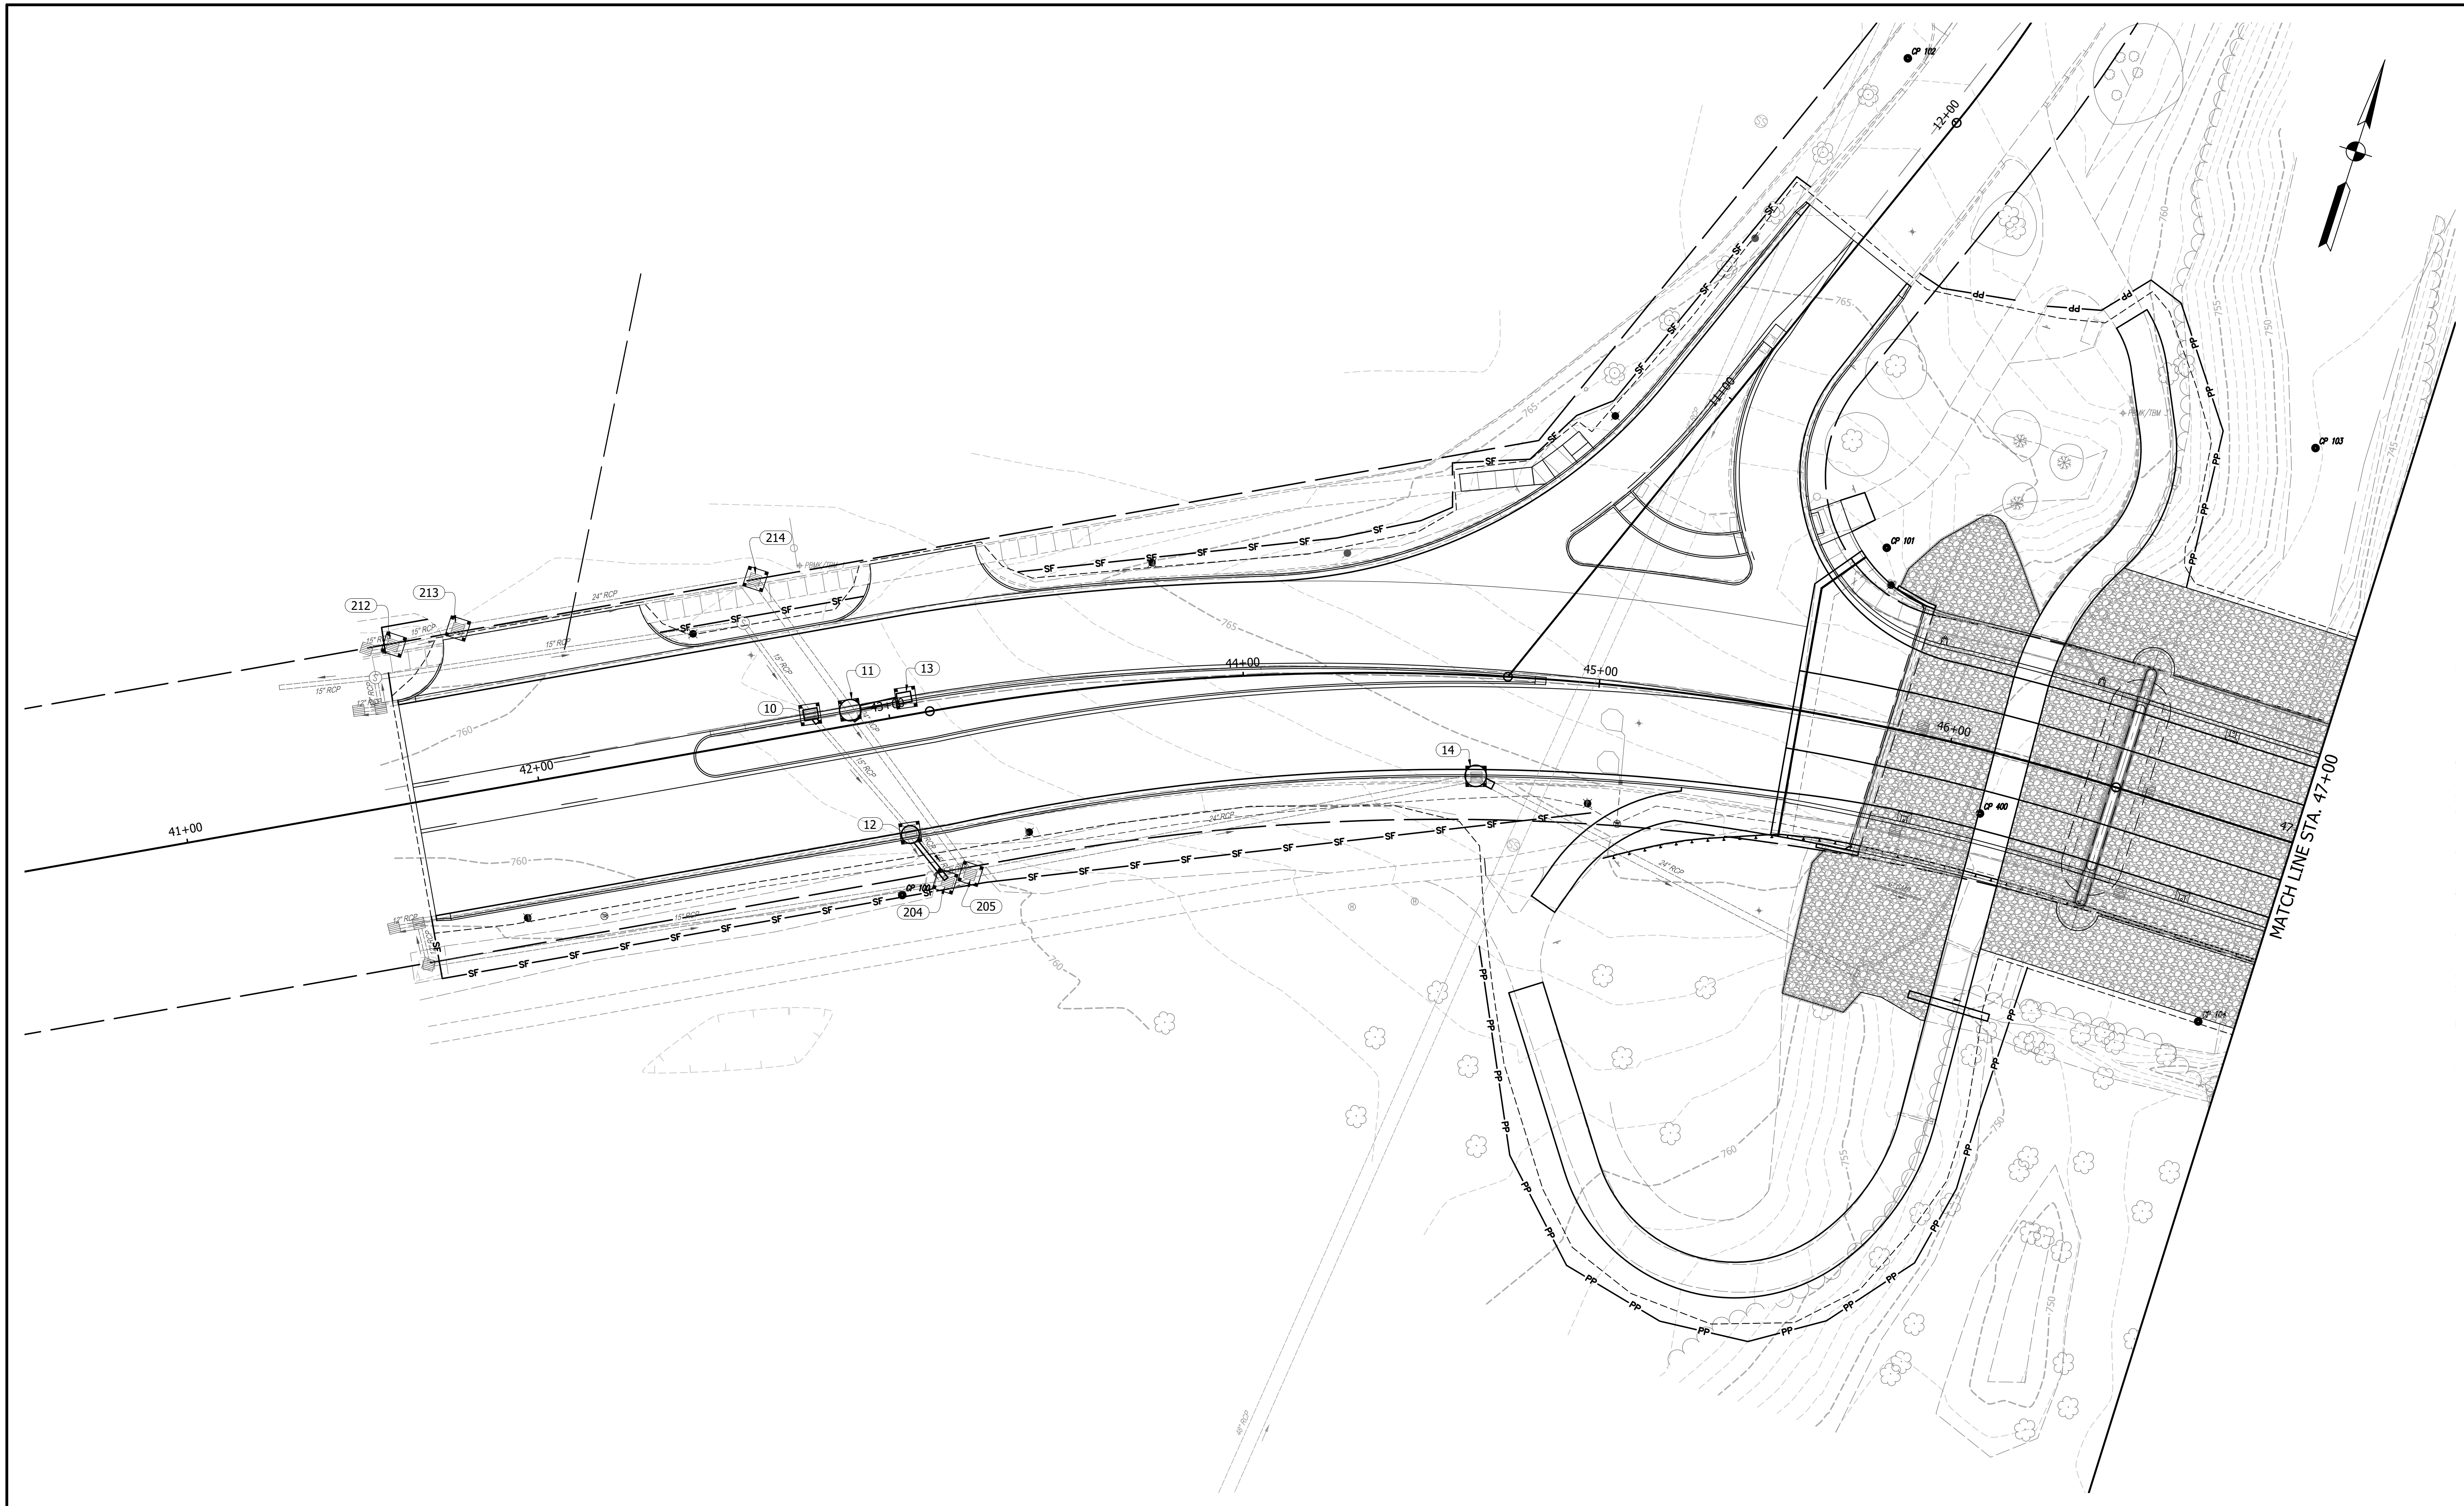

LEGEND

- Temporary Inlet Protection
- Silt Fence
- Filter Sock



NOT FOR CONSTRUCTION

DESIGNED: BMA	DRAWN: CNC
CHECKED: KAM	CHECKED: BMA

INDIANA
DEPARTMENT OF TRANSPORTATION

EROSION CONTROL DETAILS
BLUFFTON RD / BROADWAY

HORIZONTAL SCALE 1" = 20'	BRIDGE FILE ALLEN 358
VERTICAL SCALE N/A	DESIGNATION 1902834
SURVEY BOOK ---	SHEETS 29 of 63
CONTRACT B-42844	PROJECT 1902834

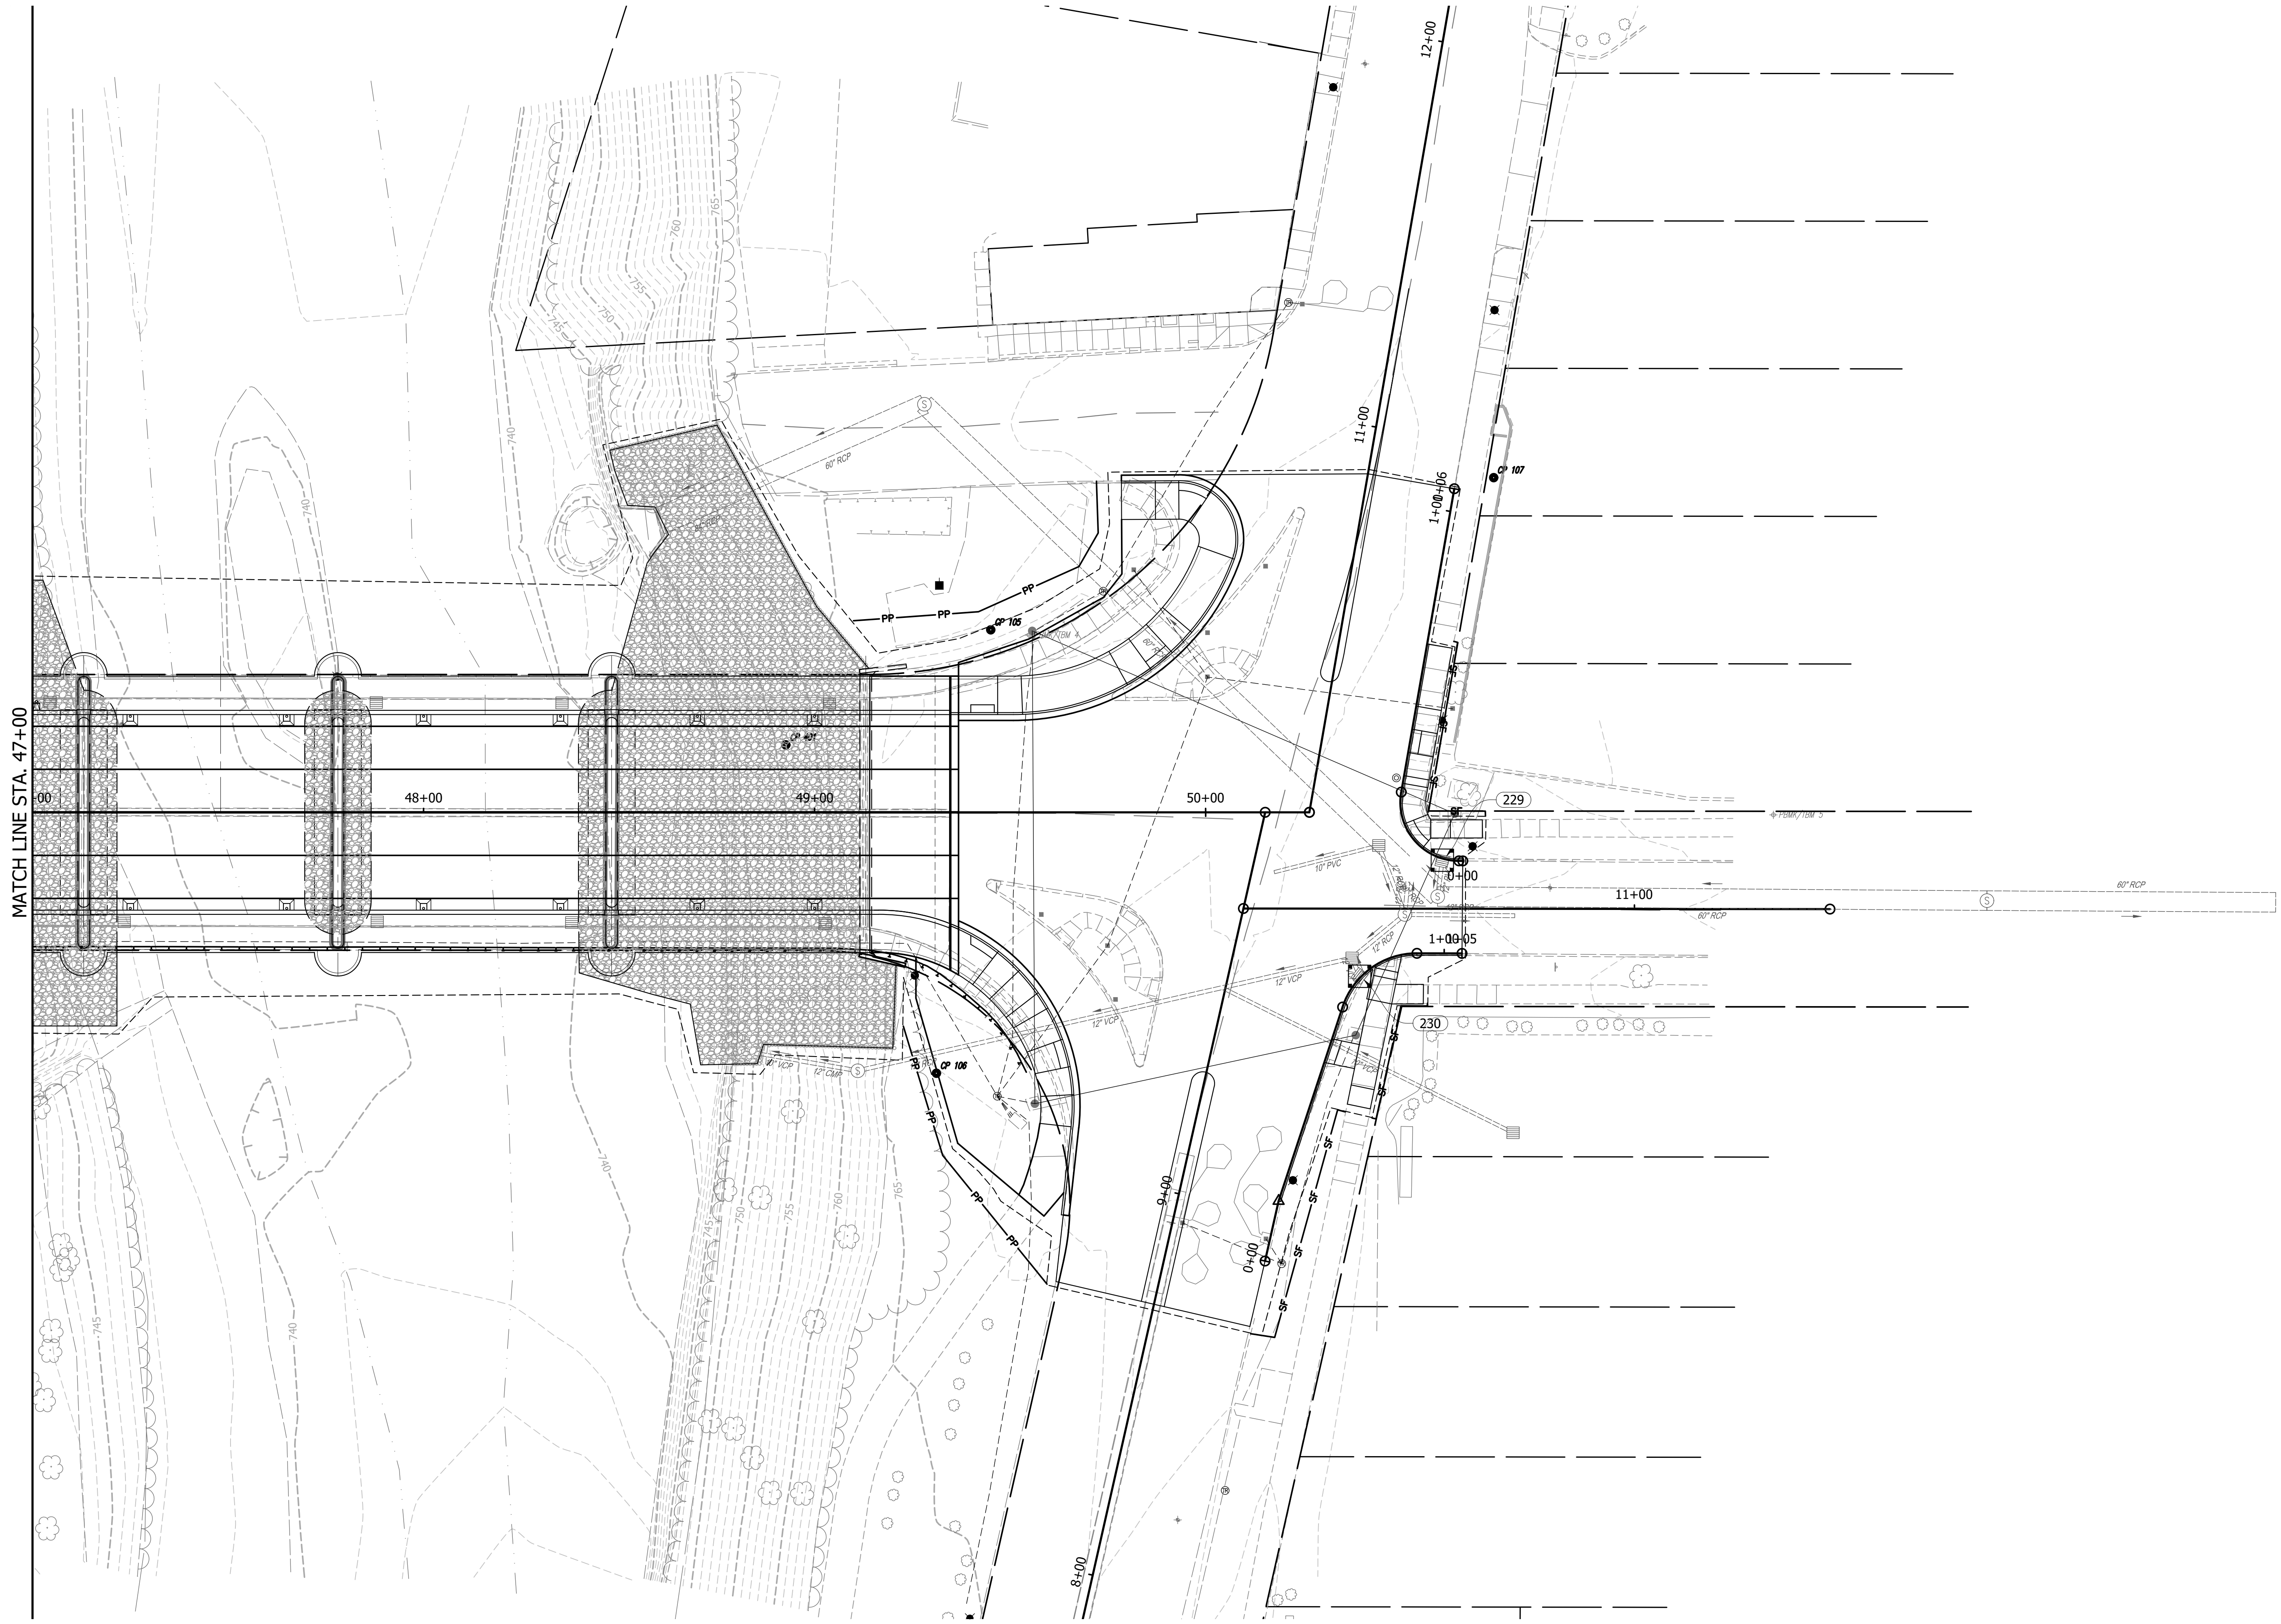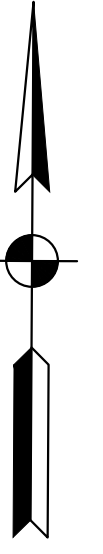


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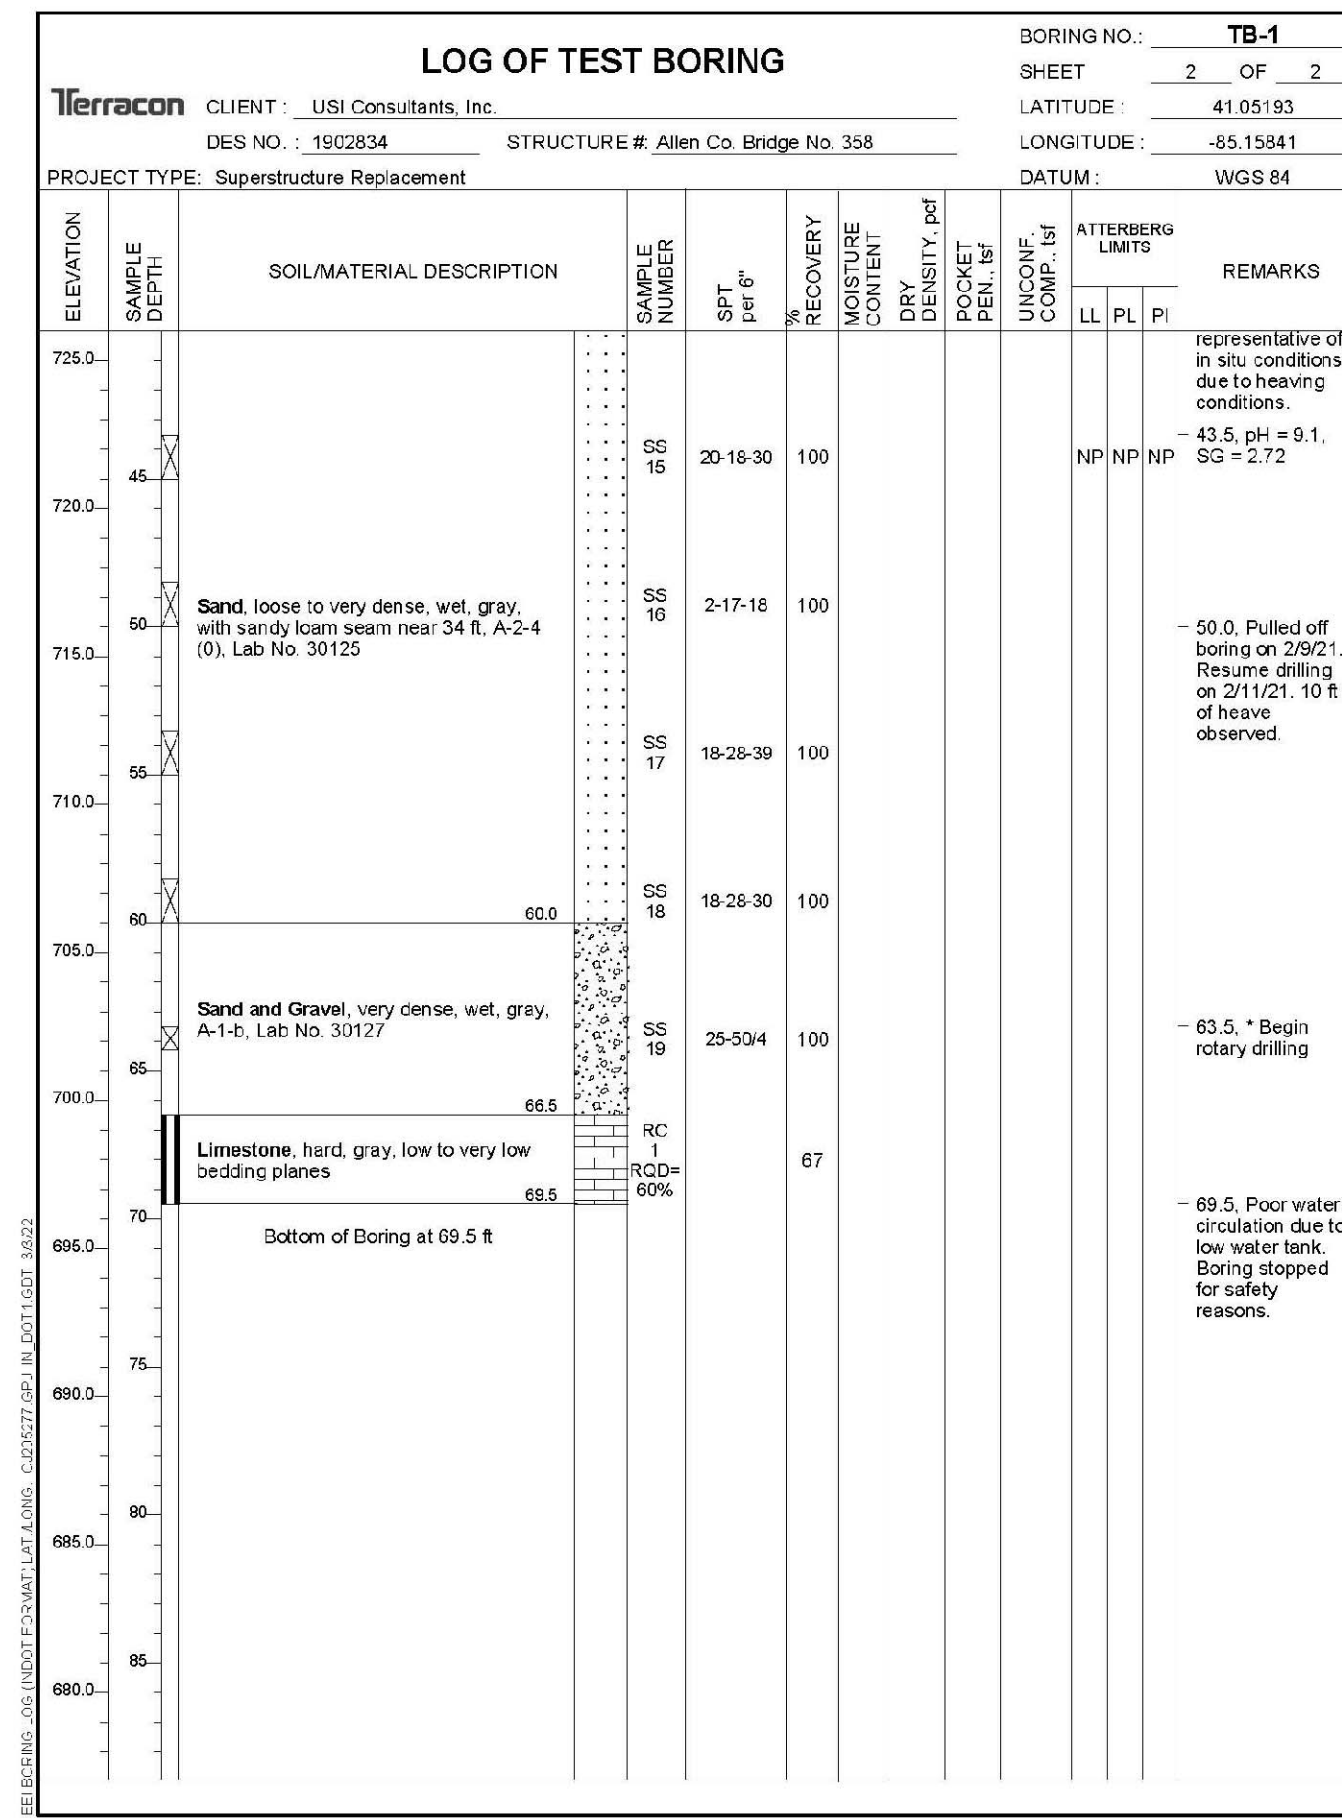
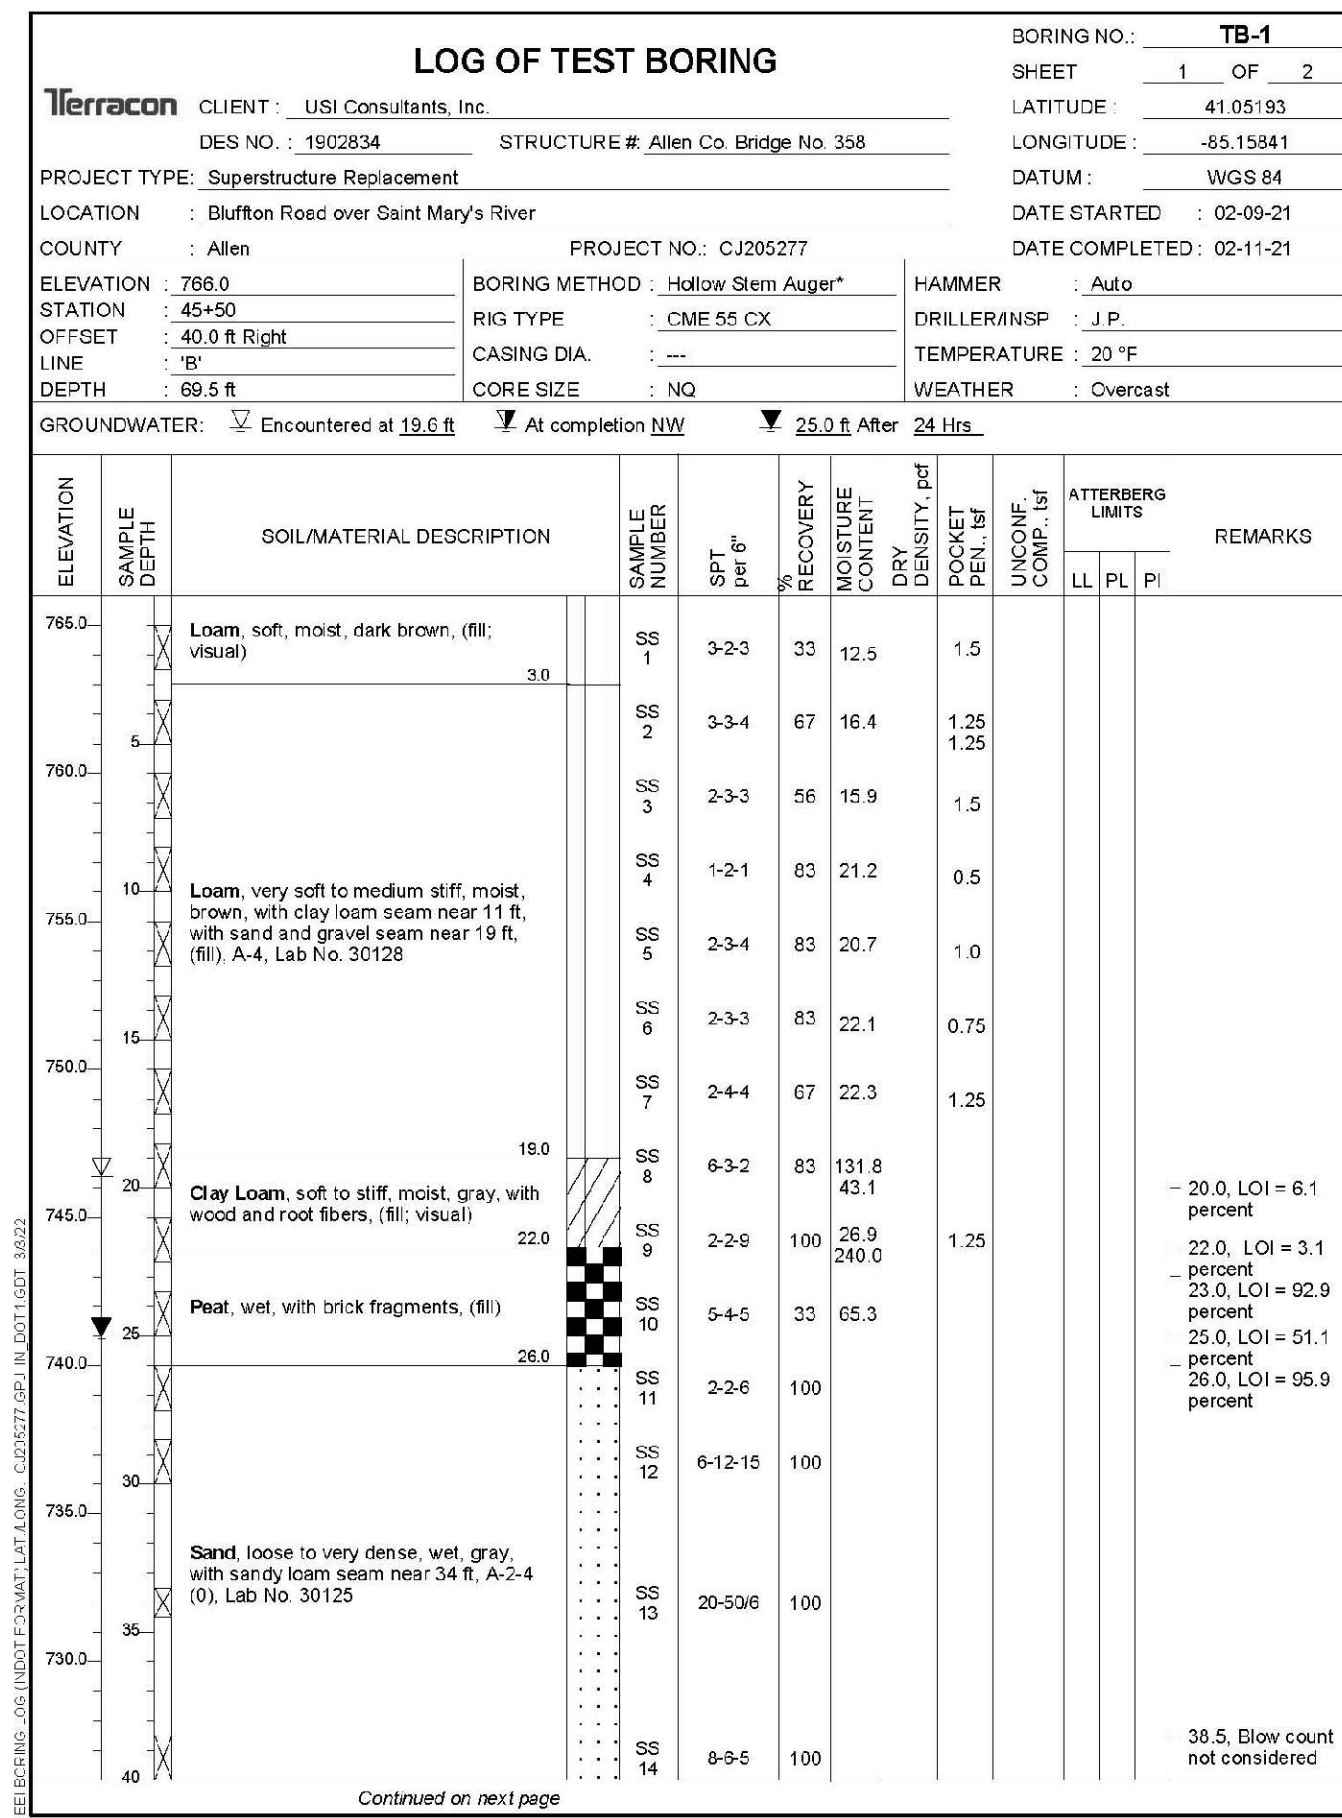
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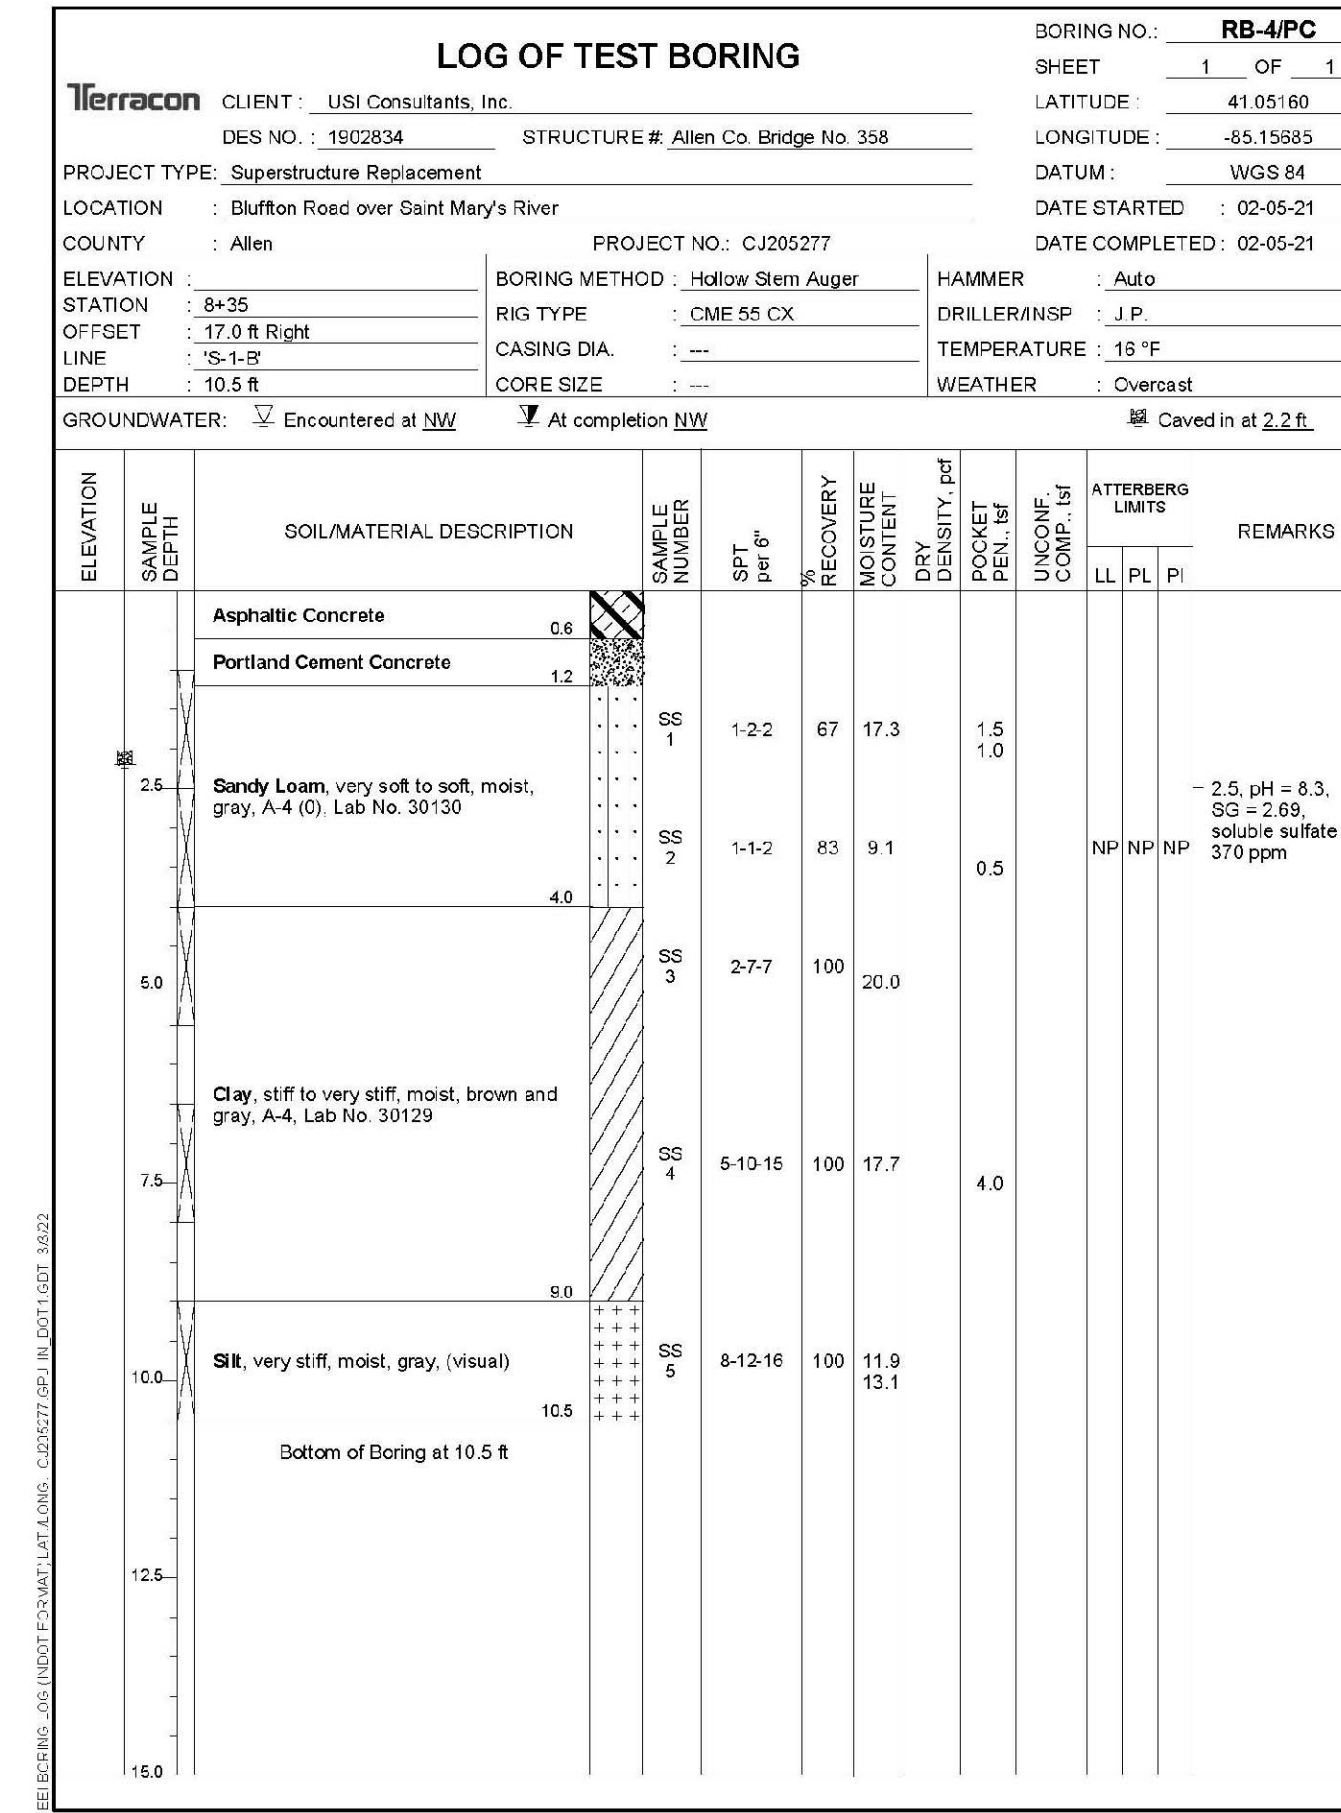
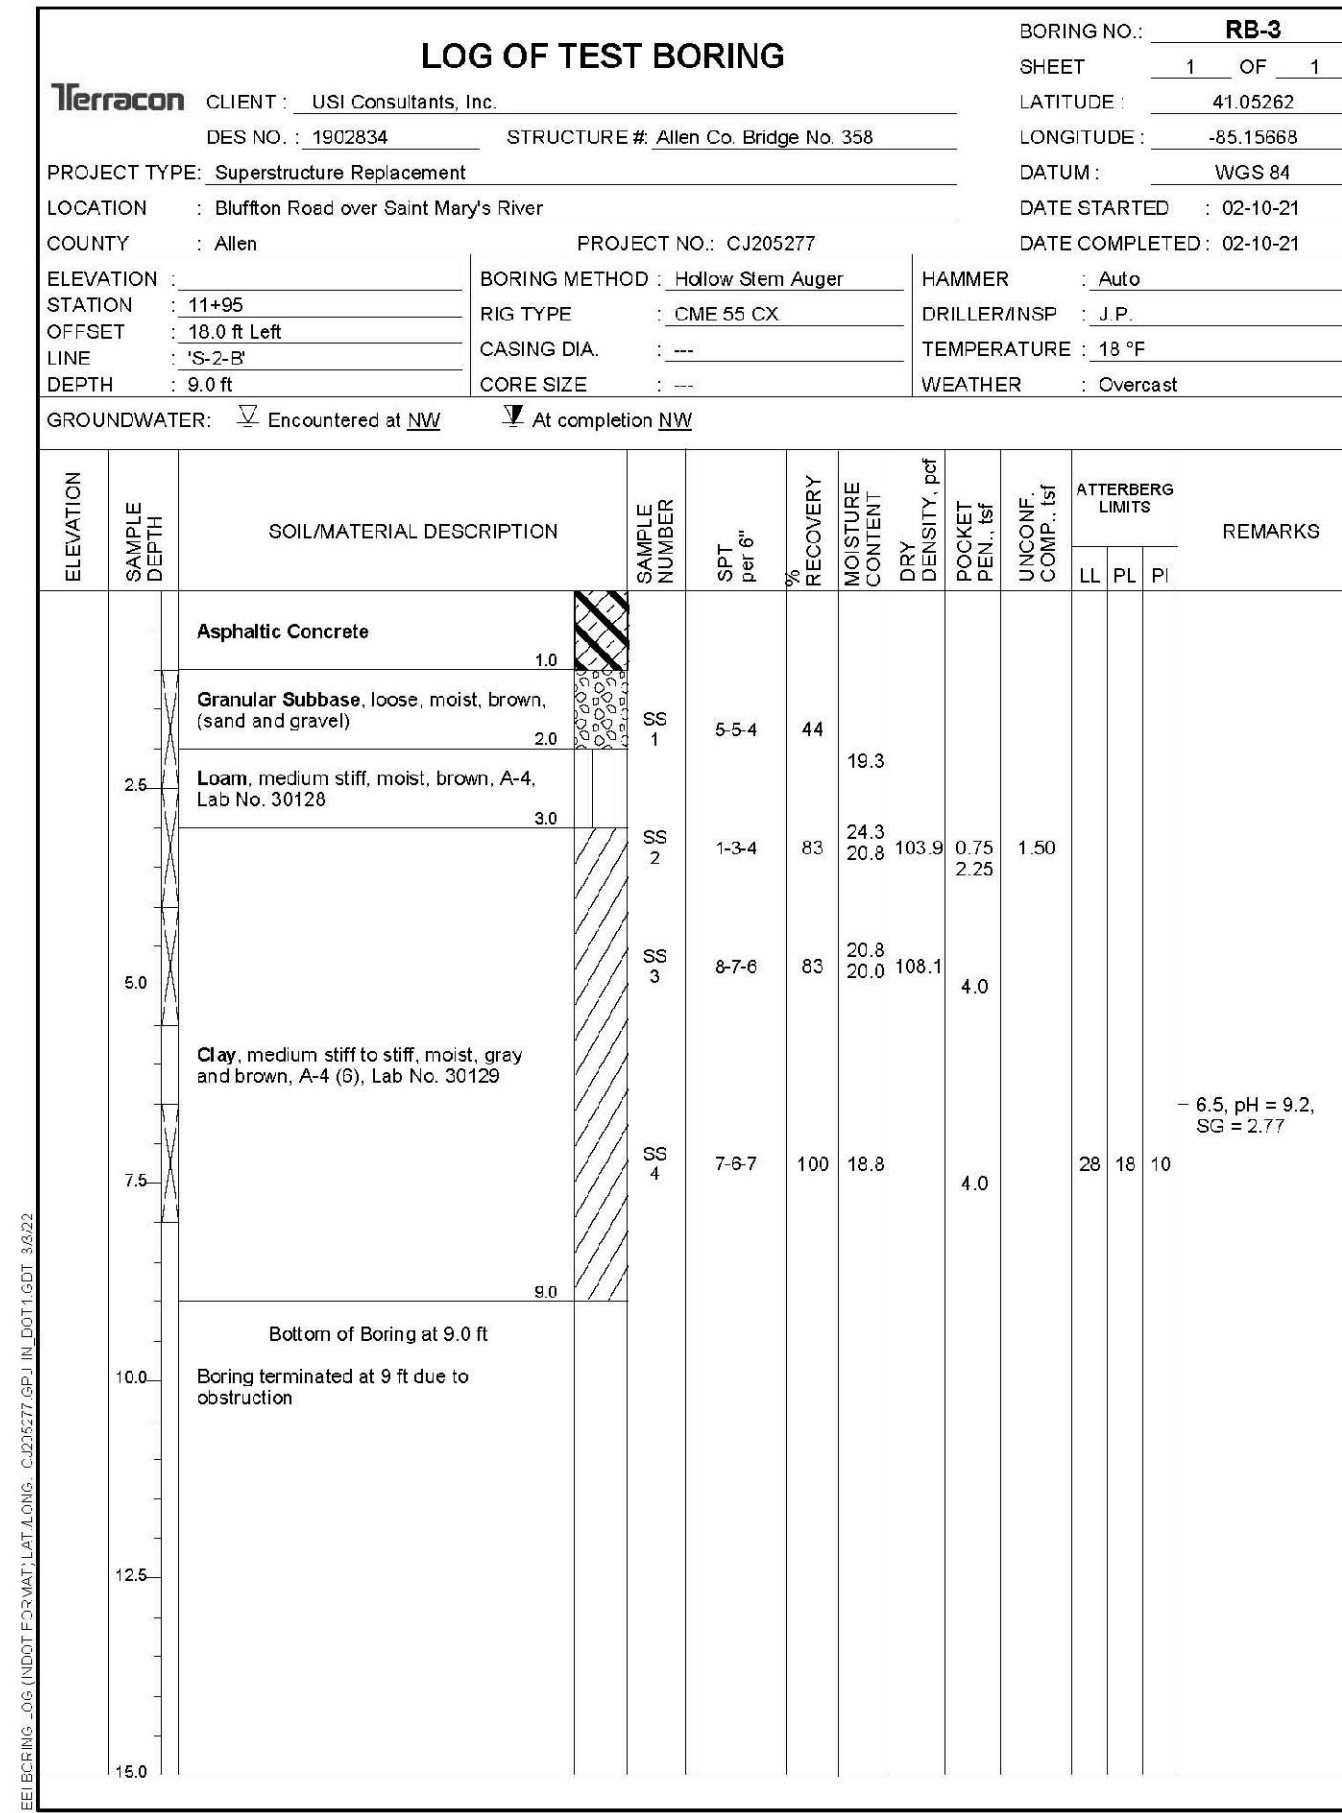
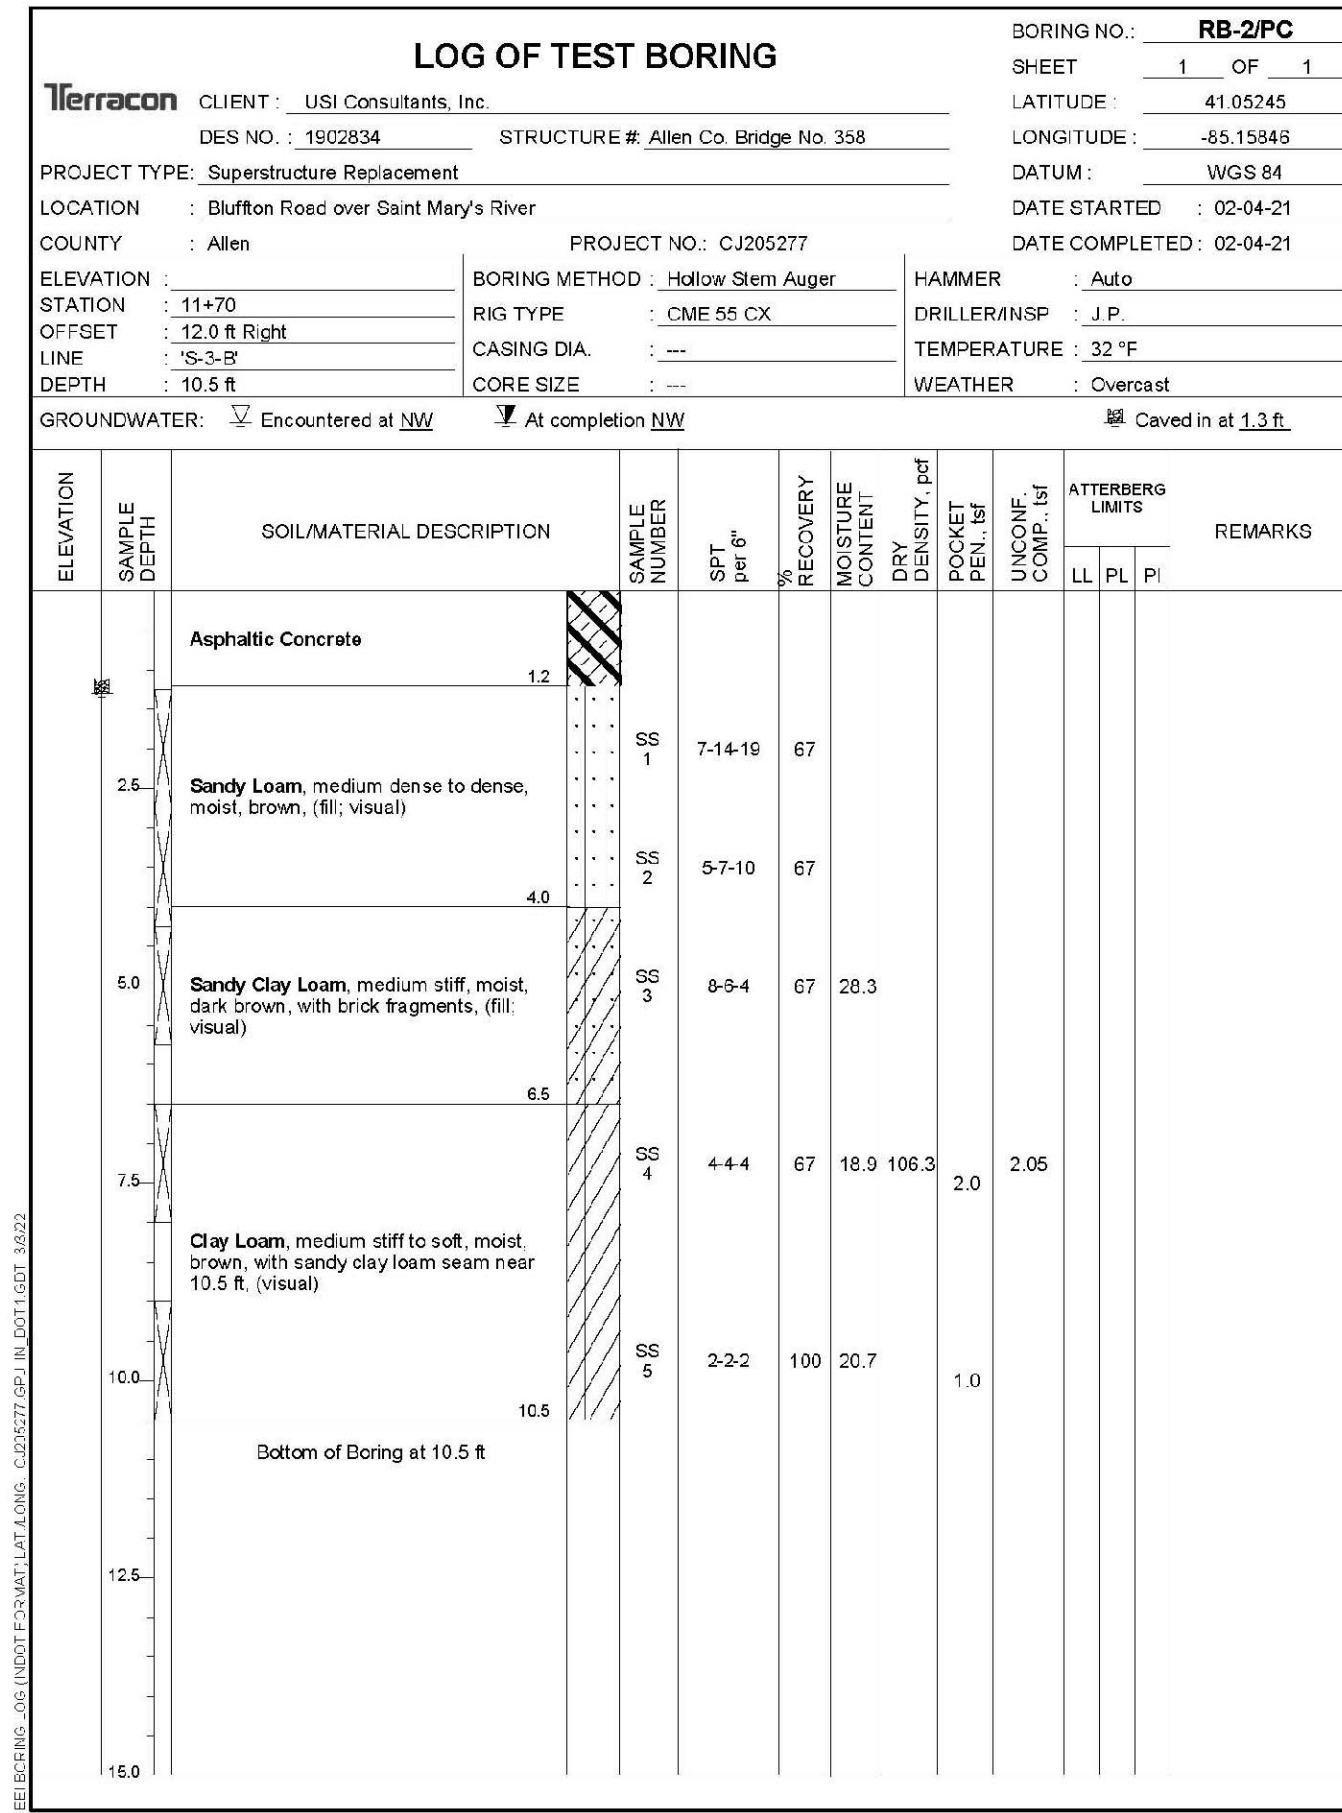
INDIANA
DEPARTMENT OF TRANSPORTATION

EROSION CONTROL DETAILS
BLUFFTON RD / BROADWAY

HORIZONTAL SCALE 1" = 20'	BRIDGE FILE ALLEN 358
VERTICAL SCALE N/A	DESIGNATION 1902834
SURVEY BOOK ---	SHEETS 30 of 63
CONTRACT B-42844	PROJECT 1902834





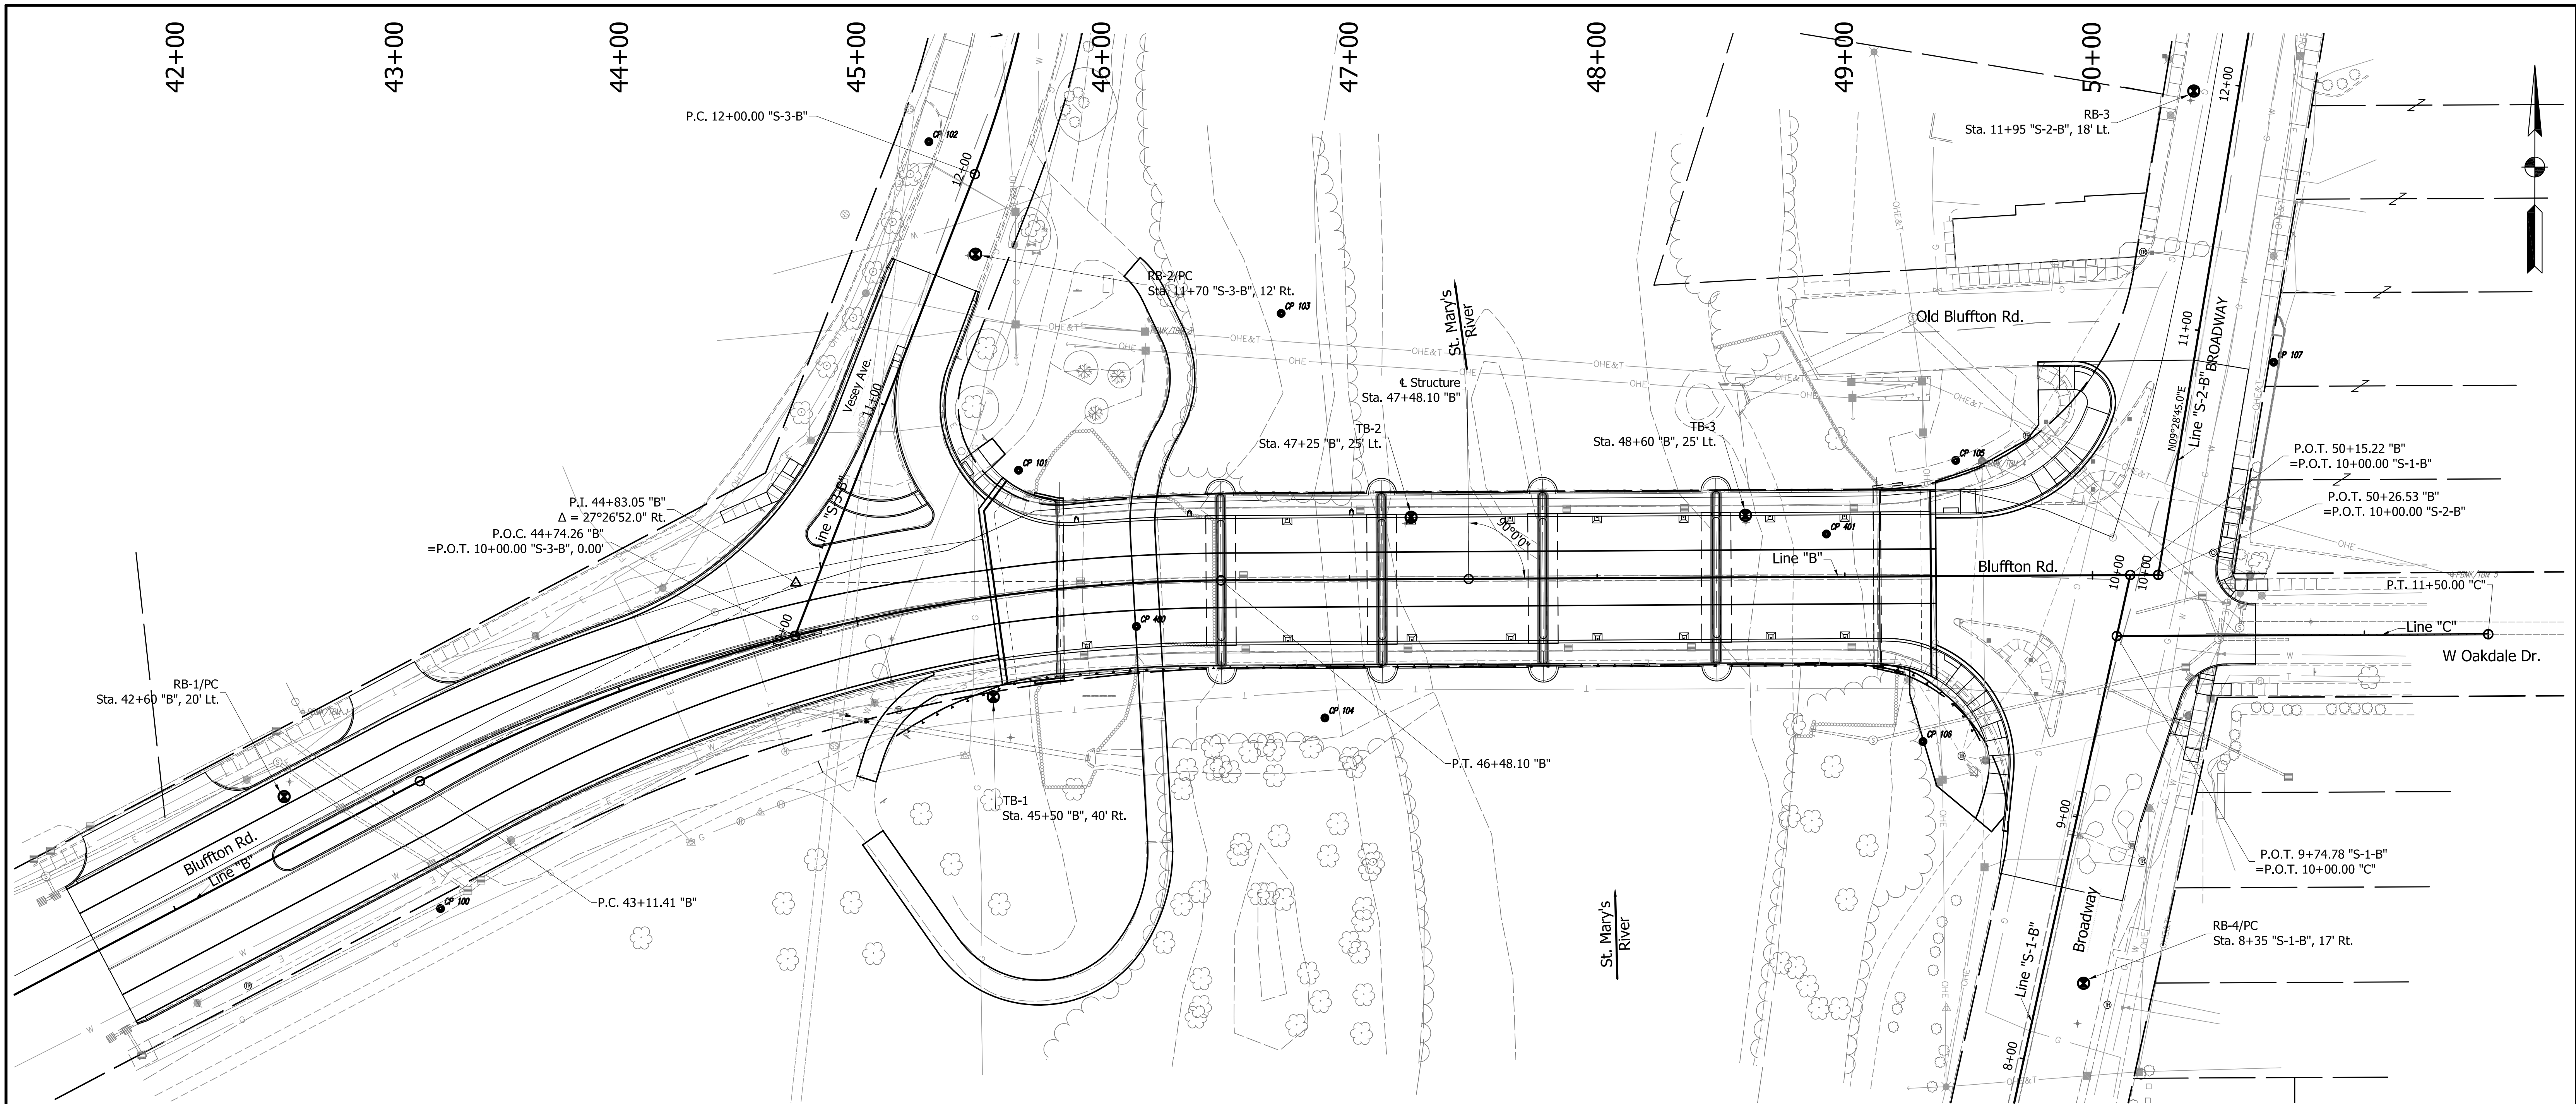

NOTES:
 For soil boring location plan see Sheet No. xx.
 For additional soil boring logs see Sheet No. xx.

NOT FOR CONSTRUCTION

DESIGNED: BMA DRAWN: BDC
 CHECKED: KAM CHECKED: BMA

INDIANA DEPARTMENT OF TRANSPORTATION
 SOIL BORINGS


HORIZONTAL SCALE	BRIDGE FILE
N/A	ALLEN 358
VERTICAL SCALE	DESIGNATION
N/A	1902834
SURVEY BOOK	SHEETS
---	33 of 63
CONTRACT	PROJECT
B-42844	1902834

43+00
44+00
HALL DRIVE-INS INC.
Section 15, T30N, R12E
Wayne Township
Allen County

CURVE DATA
P.I. 44+83.05 "B"
N = 173539.1531
E = 757413.1739
Δ = 27°26'52.0" Rt.
R = 702.82'
T = 171.64'
L = 336.69'
E = 20.66'
SE = N.C.

P.I. 44+83.05 "B"
Δ = 27°26'52.0" Rt.
P.O.C. 44+74.26 "B"
=P.O.T. 10+00.00 "S-3-B", 0.00'

Section 15, T30N, R12E
Wayne Township
Allen County
Per GIS, Pipe is
Non Reinforced
Concrete


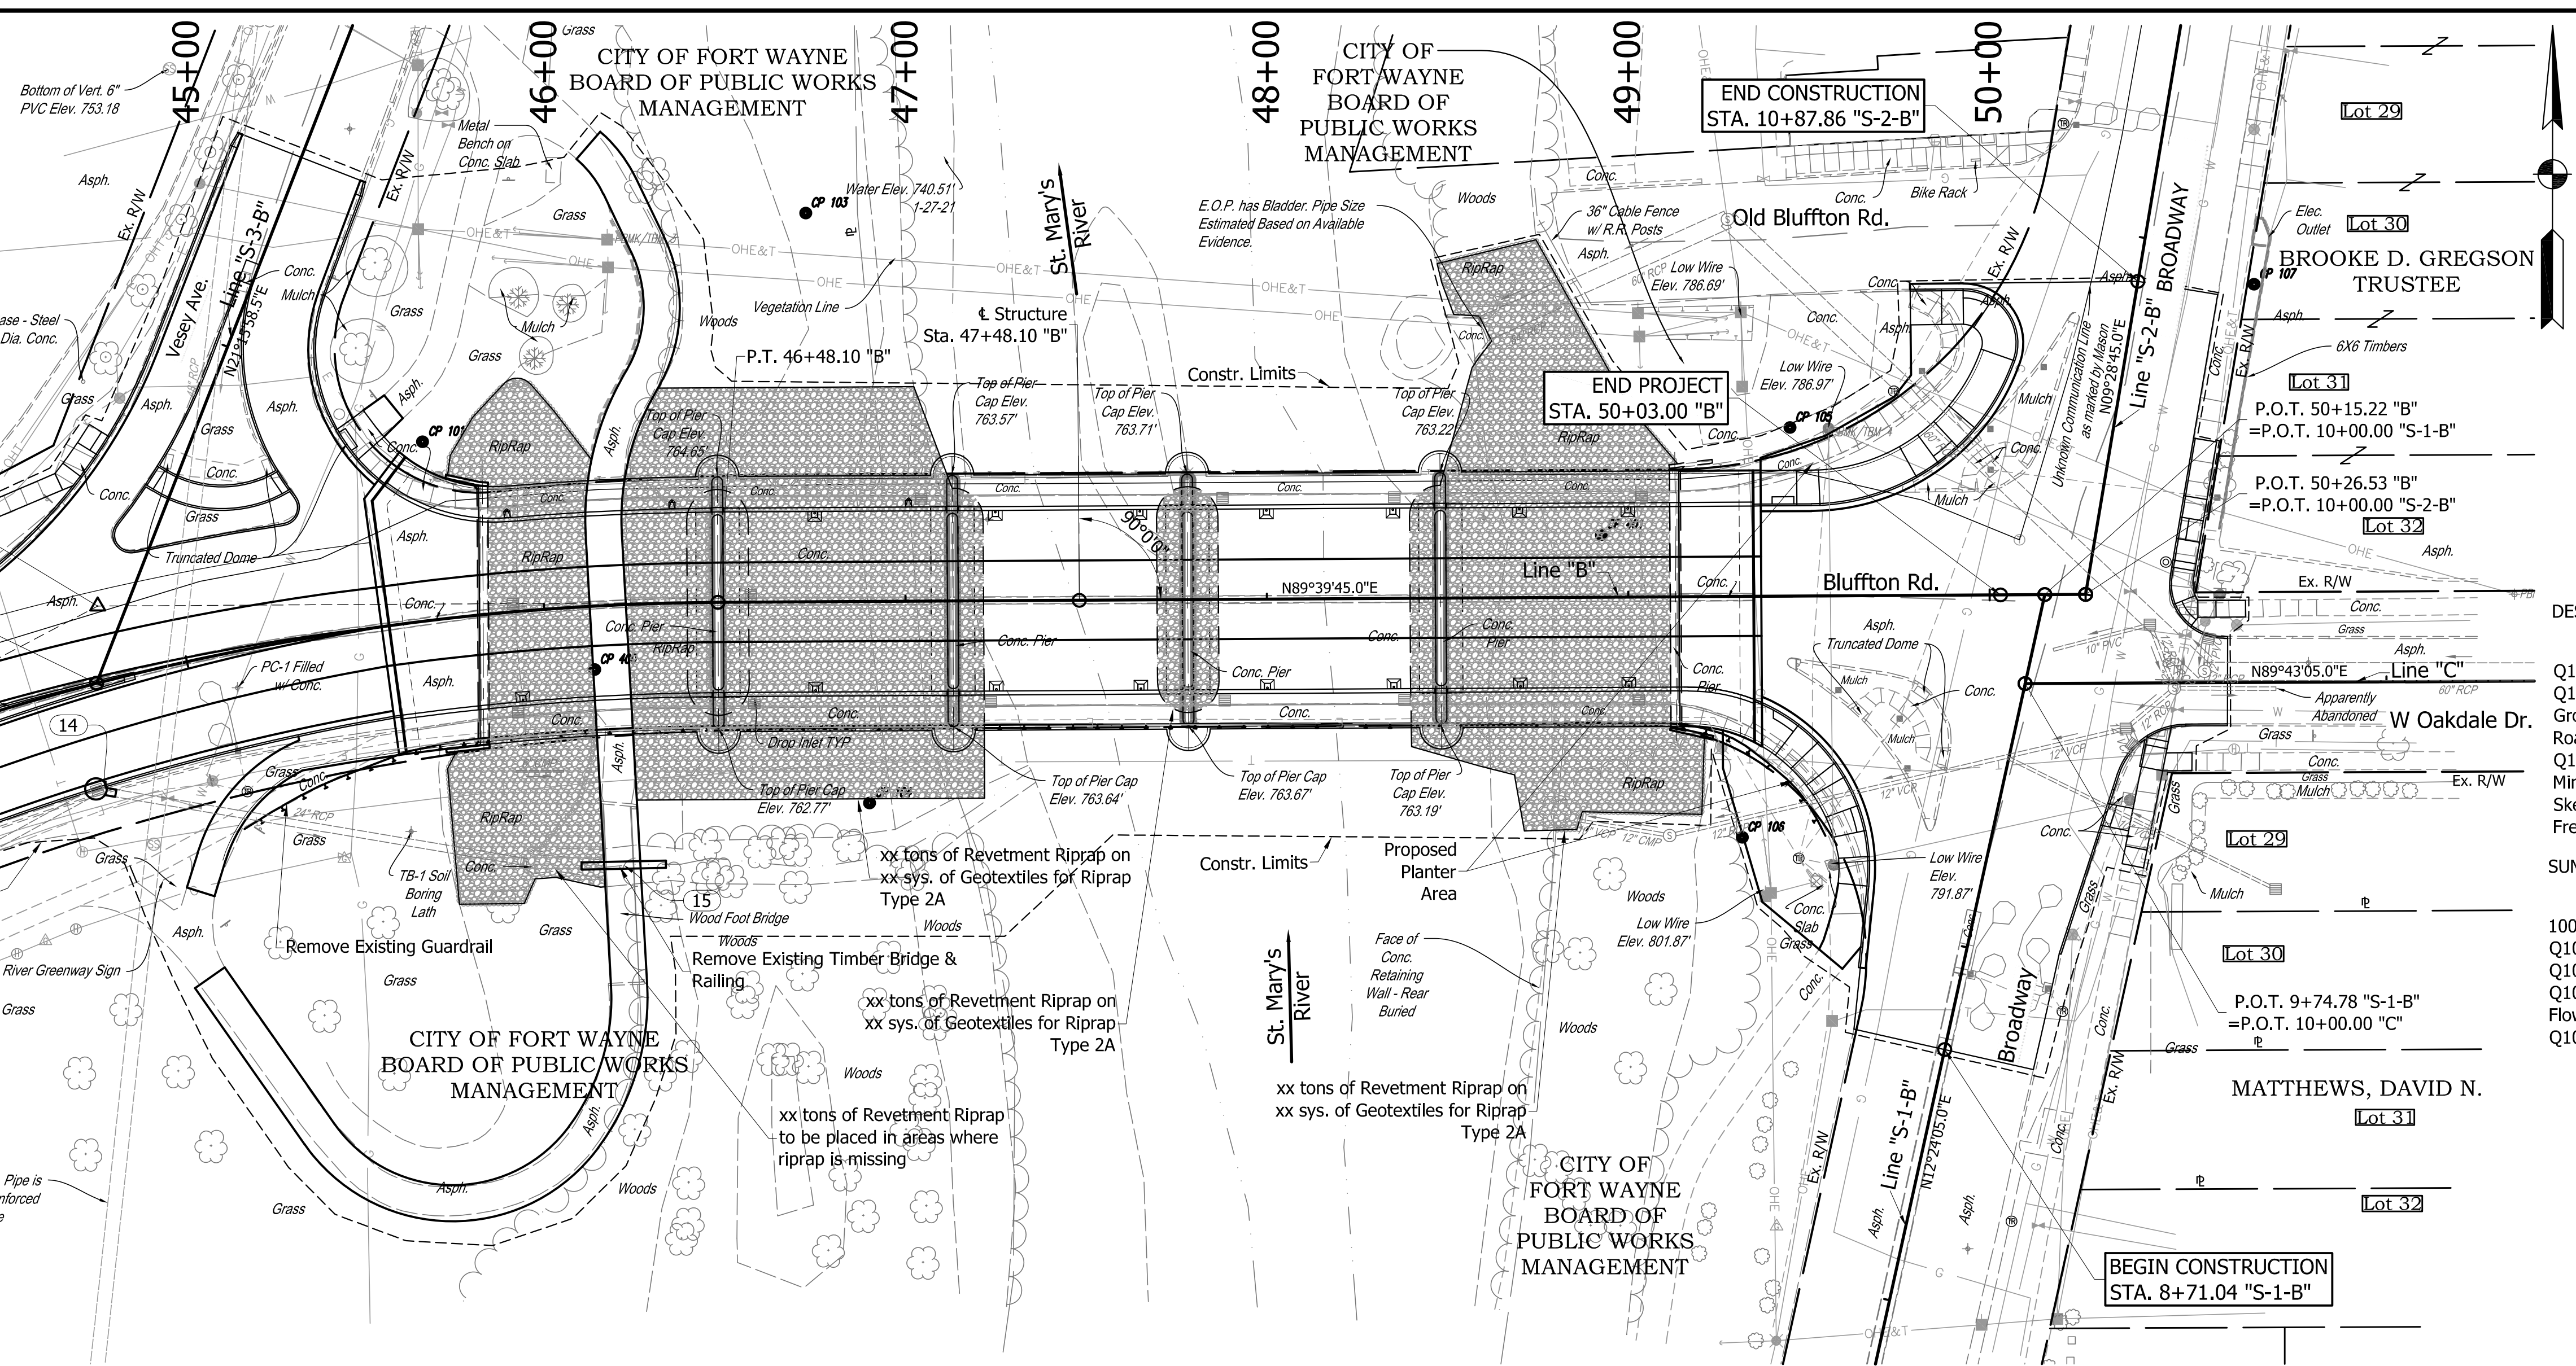


HYDRAULIC DATA

Drainage Area:	808.4 sq. miles
Q100	15,775 cfs
Q100 Elevation	761.96 ft.

DESCRIPTION	Existing Structure	Proposed Structure
Q100 Backwater:	0.17 ft.	0.17 ft.
Q100 Headwater Elev.:	762.18 ft.	762.18 ft.
Gross Waterway Area below Q100:	4057.3 sq. ft.	4057.3 sq. ft.
Road Overflow Waterway Area:	0.00 sq. ft.	0.00 sq. ft.
Q100 Velocity:	4.00 ft./s	4.00 ft./s
Minimum Low Structure Elevation:	761.65 ft.	761.72 ft.
Skew:	0 degrees	0 degrees
Freeboard:	0.00 ft.	0.00 ft.

SUMMARY OF SCOUR DATA	Existing Structure	Proposed Structure
100 Max. Velocity:	N/A ft./s.	5.06 ft./s.
Q100 Contraction Scour Depth:	N/A ft.	16.75 ft.
Q100 Pier Scour Depth:	N/A ft.	6.45 ft.
Q100 Total Scour:	N/A ft.	23.20 ft.
Flowline Elevation:	N/A ft.	739.20 ft.
Q100 Low Scour Elevation:	N/A ft.	716.00 ft.

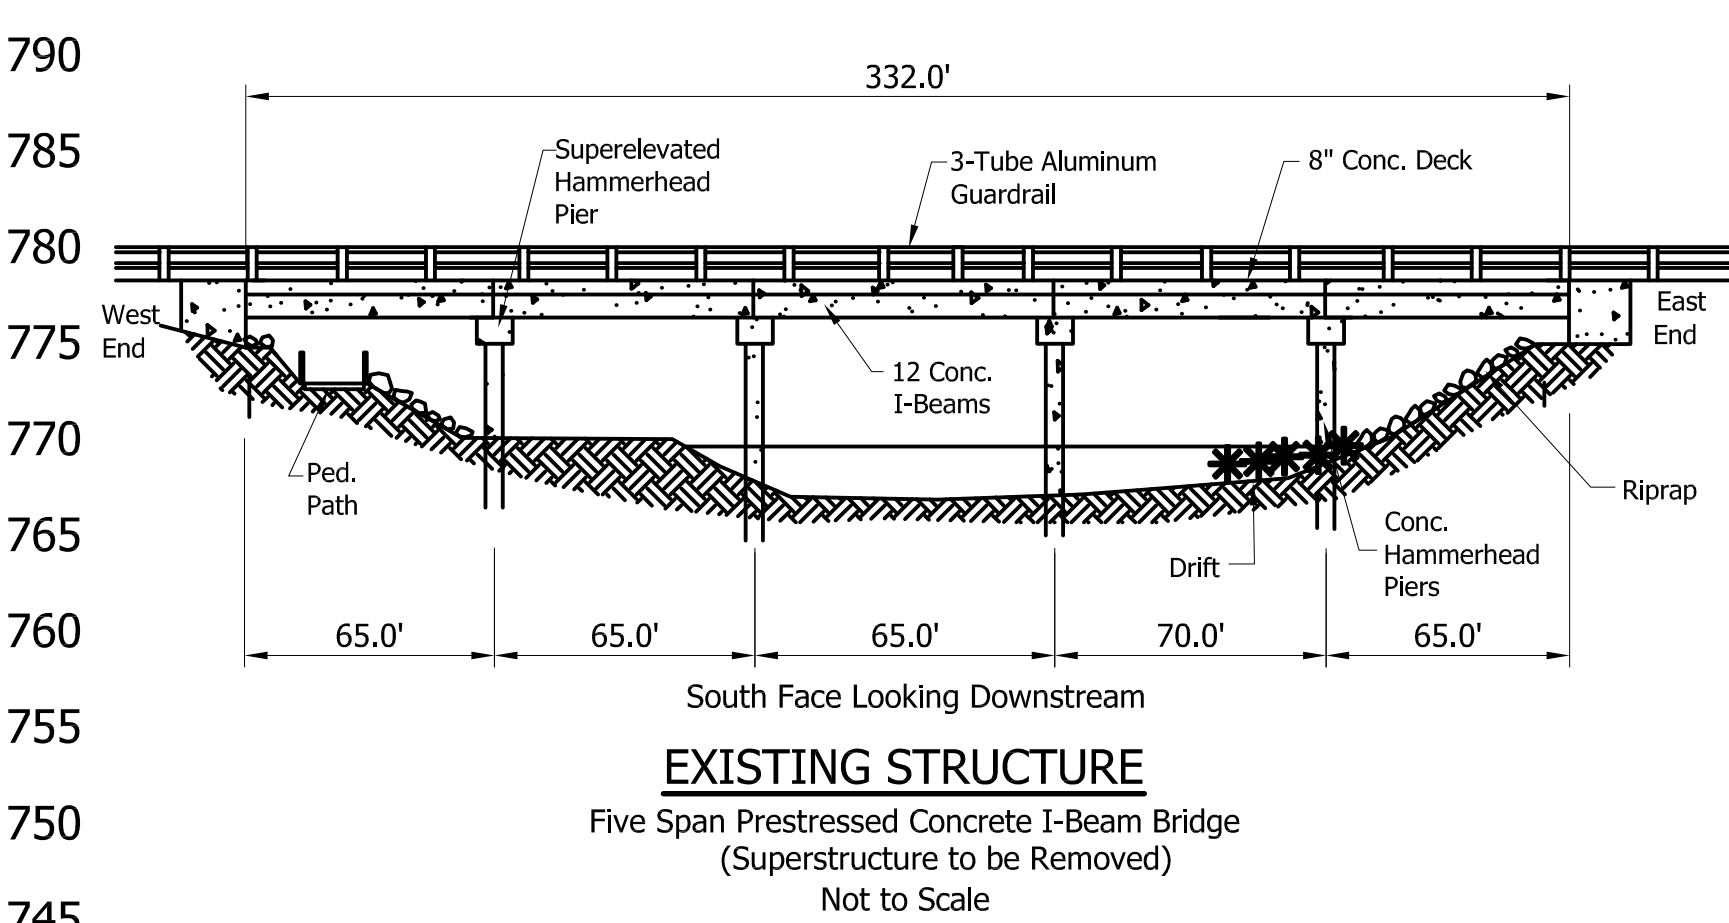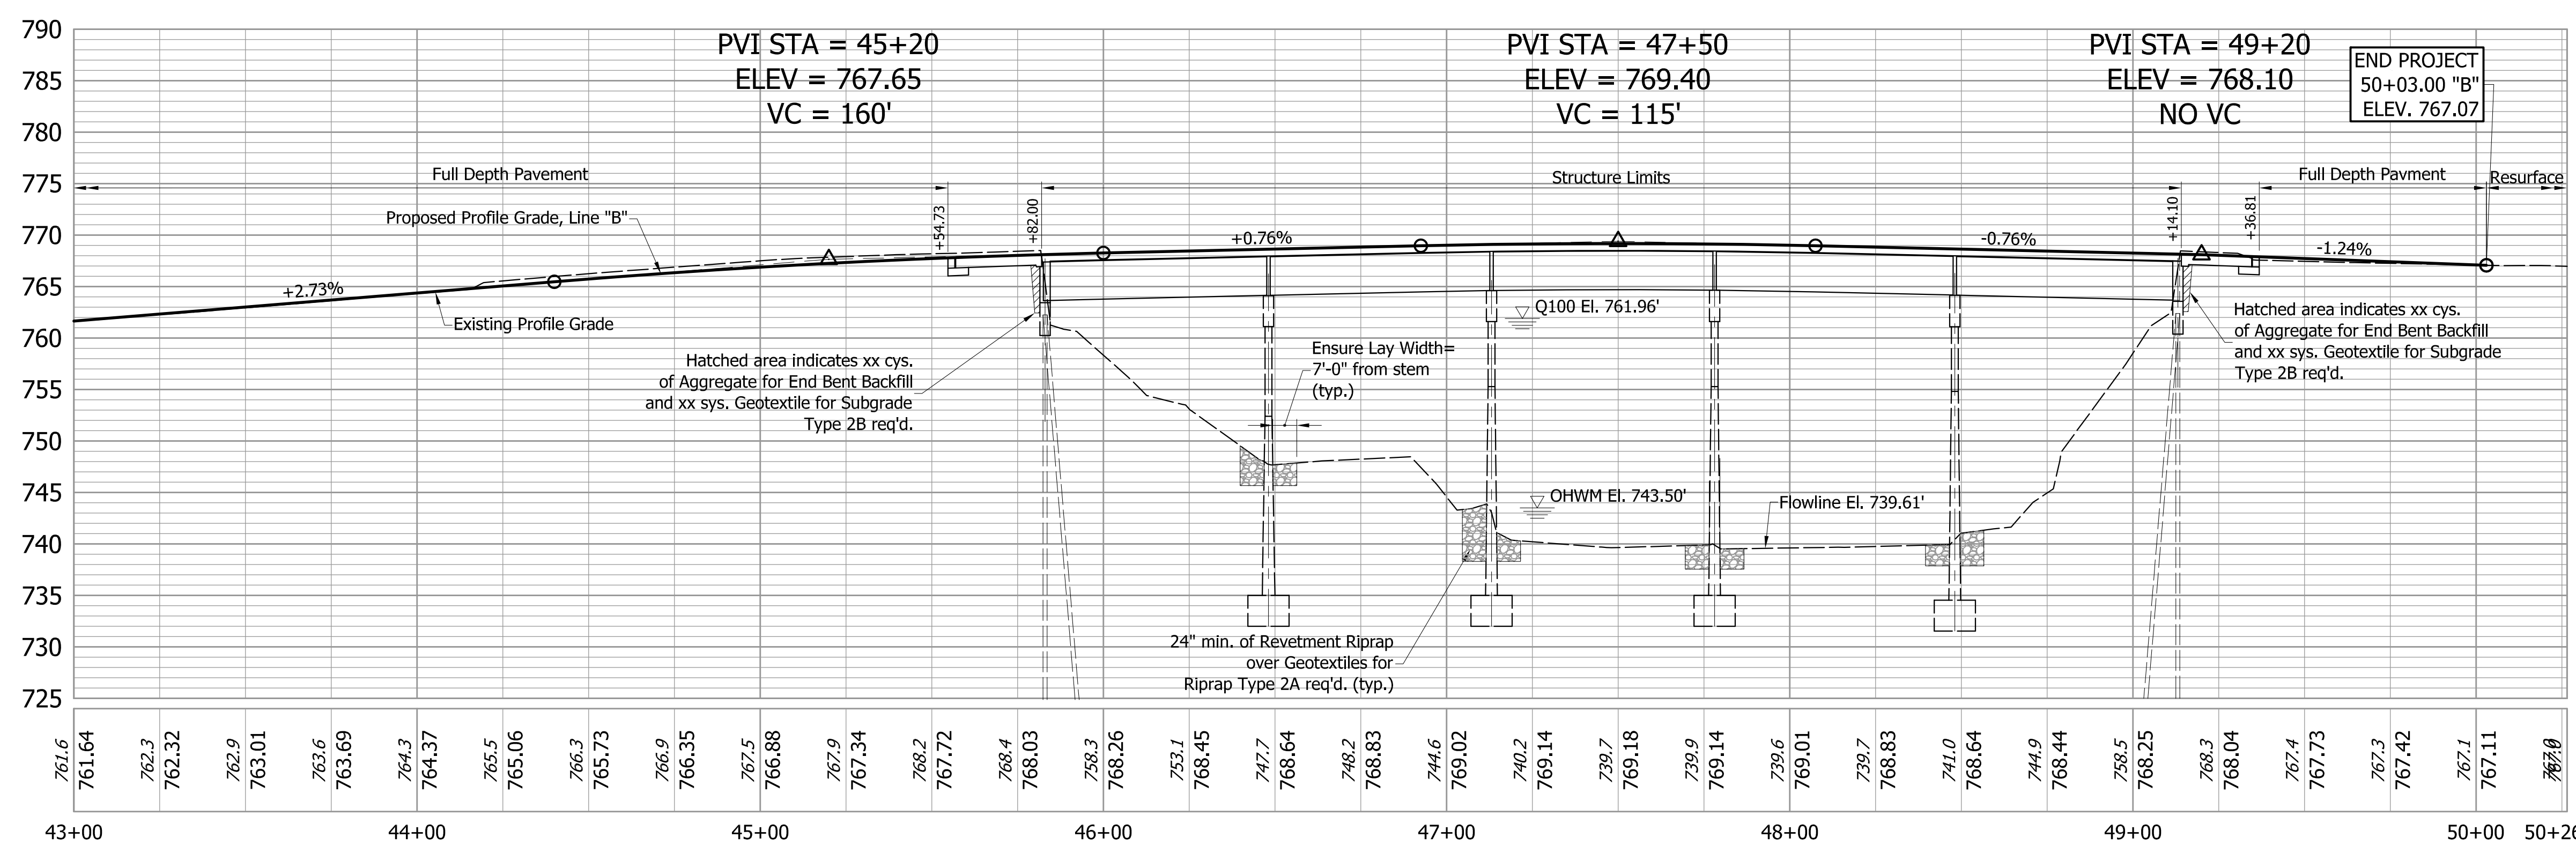


CONTINUOUS COMPOSITE PRESTRESSED CONCRETE I-BEAM BRIDGE
5 SPANS: 65'-0, 65'-0, 65'-0, 70'-0, 65'-0, SQUARE
CLEAR ROADWAY WIDTH: 2 @ 28'-0"
BLUFFTON ROAD OVER ST. MARY'S RIVER
ALLEN COUNTY, INDIANA

NOT FOR CONSTRUCTION

DESIGNED: DWB	DRAWN: DWB
CHECKED: BMA	CHECKED: BMA



INDIANA
DEPARTMENT OF TRANSPORTATION
LAYOUT

HORIZONTAL SCALE 1"=30'	BRIDGE FILE ALLEN 358
VERTICAL SCALE 1"=10'	DESIGNATION 1902834
SURVEY BOOK ---	SHEETS 34 of 63
CONTRACT B-42844	PROJECT 1902834

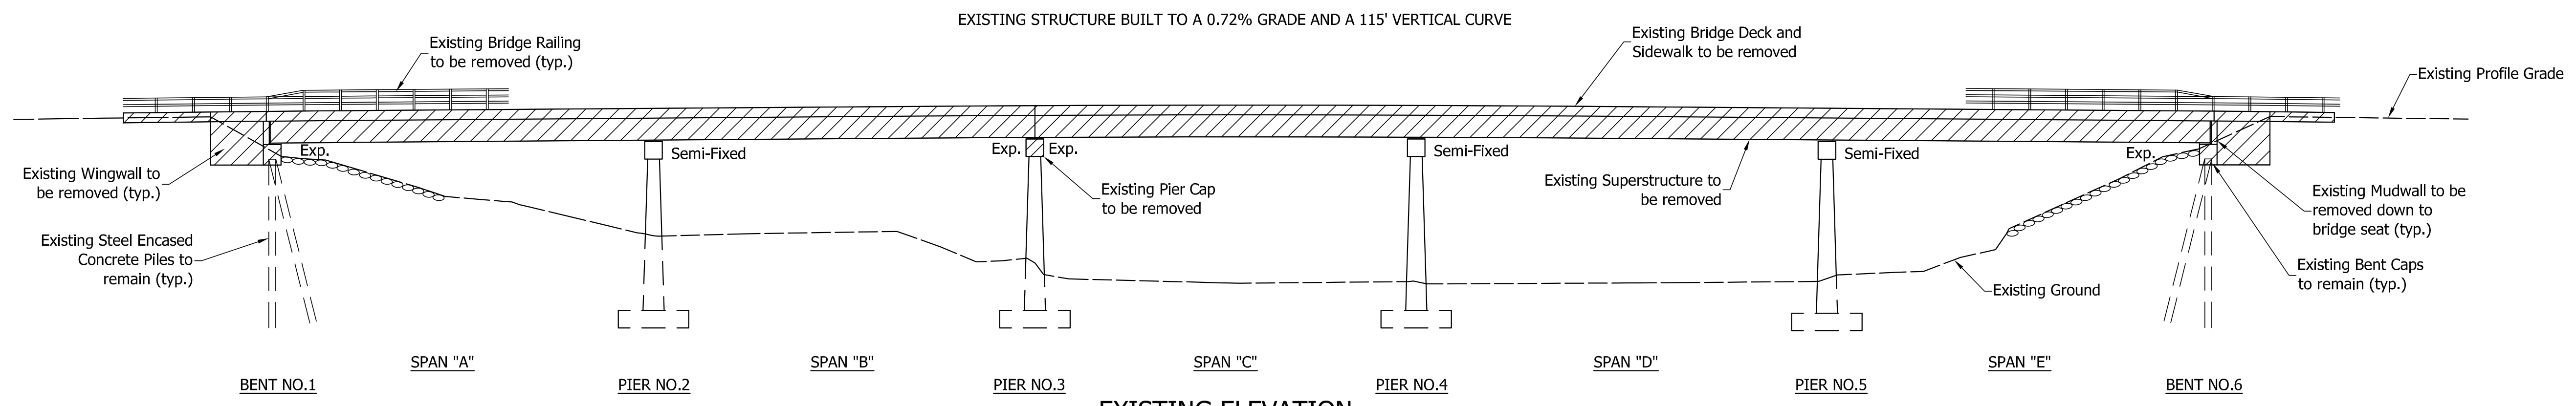

EXISTING ELEVATION
Scale: 1/16"=1'-0"

NOTE: Hatched area indicates Portions to be Removed

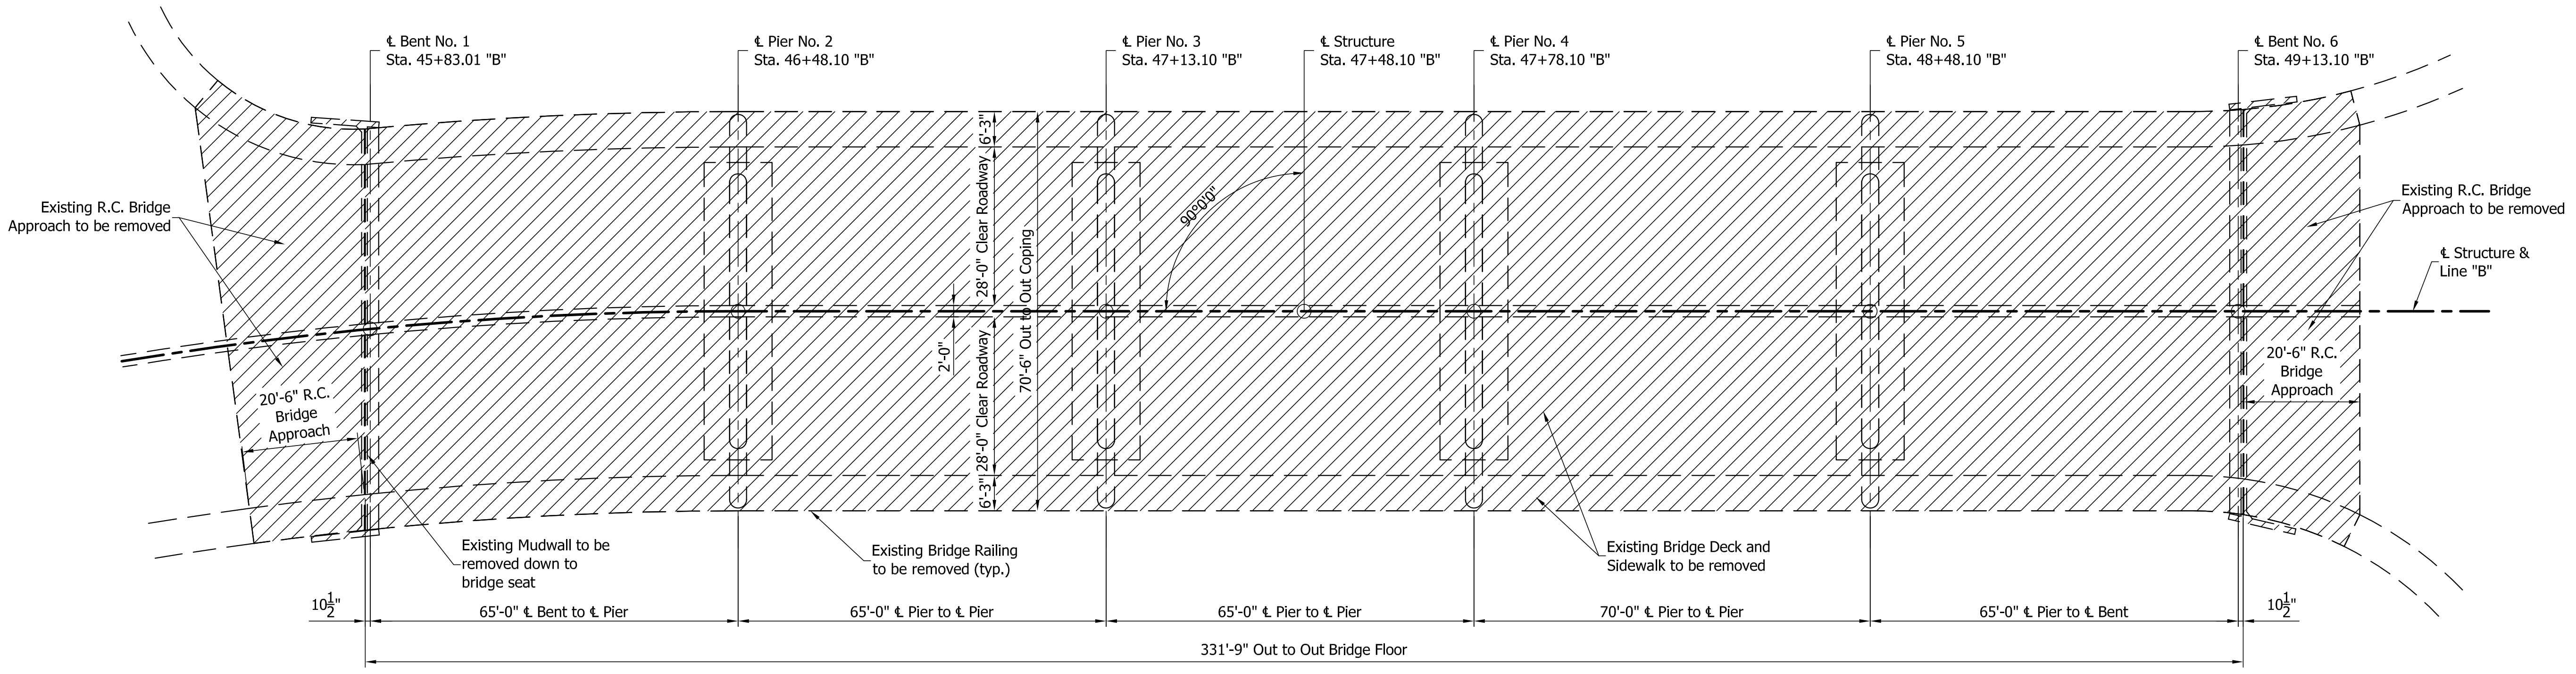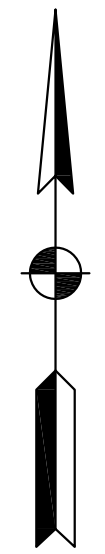

EXISTING PLAN
Scale: 1/16"=1'-0"

**EXISTING
CONTINUOUS COMPOSITE PRESTRESSED
CONCRETE I-BEAM BRIDGE**
5 SPANS: 65'-0", 65'-0", 65'-0", 70'-0", 65'-0", SQUARE
CLEAR ROADWAY WIDTH: 2 @ 28'-0"
BLUFFTON ROAD OVER ST. MARY'S RIVER
ALLEN COUNTY, INDIANA

**NOT FOR
CONSTRUCTION**


DESIGNED: BMA	DRAWN: DWB
CHECKED: KAM	CHECKED: BMA

**INDIANA
DEPARTMENT OF TRANSPORTATION**

**GENERAL PLAN
EXISTING**


HORIZONTAL SCALE AS NOTED	BRIDGE FILE ALLEN 358
VERTICAL SCALE AS NOTED	DESIGNATION 1902834
SURVEY BOOK ---	SHEETS 35 of 63
CONTRACT B-42844	PROJECT 1902834

S:\2019\Proj\2019-0009 Fort Wayne Br 358\Plans\Bridges\Plans\2019-0009 General Plan-Existing.dwg, 3/17/2022 10:54:21 AM, PDF-3624.p3

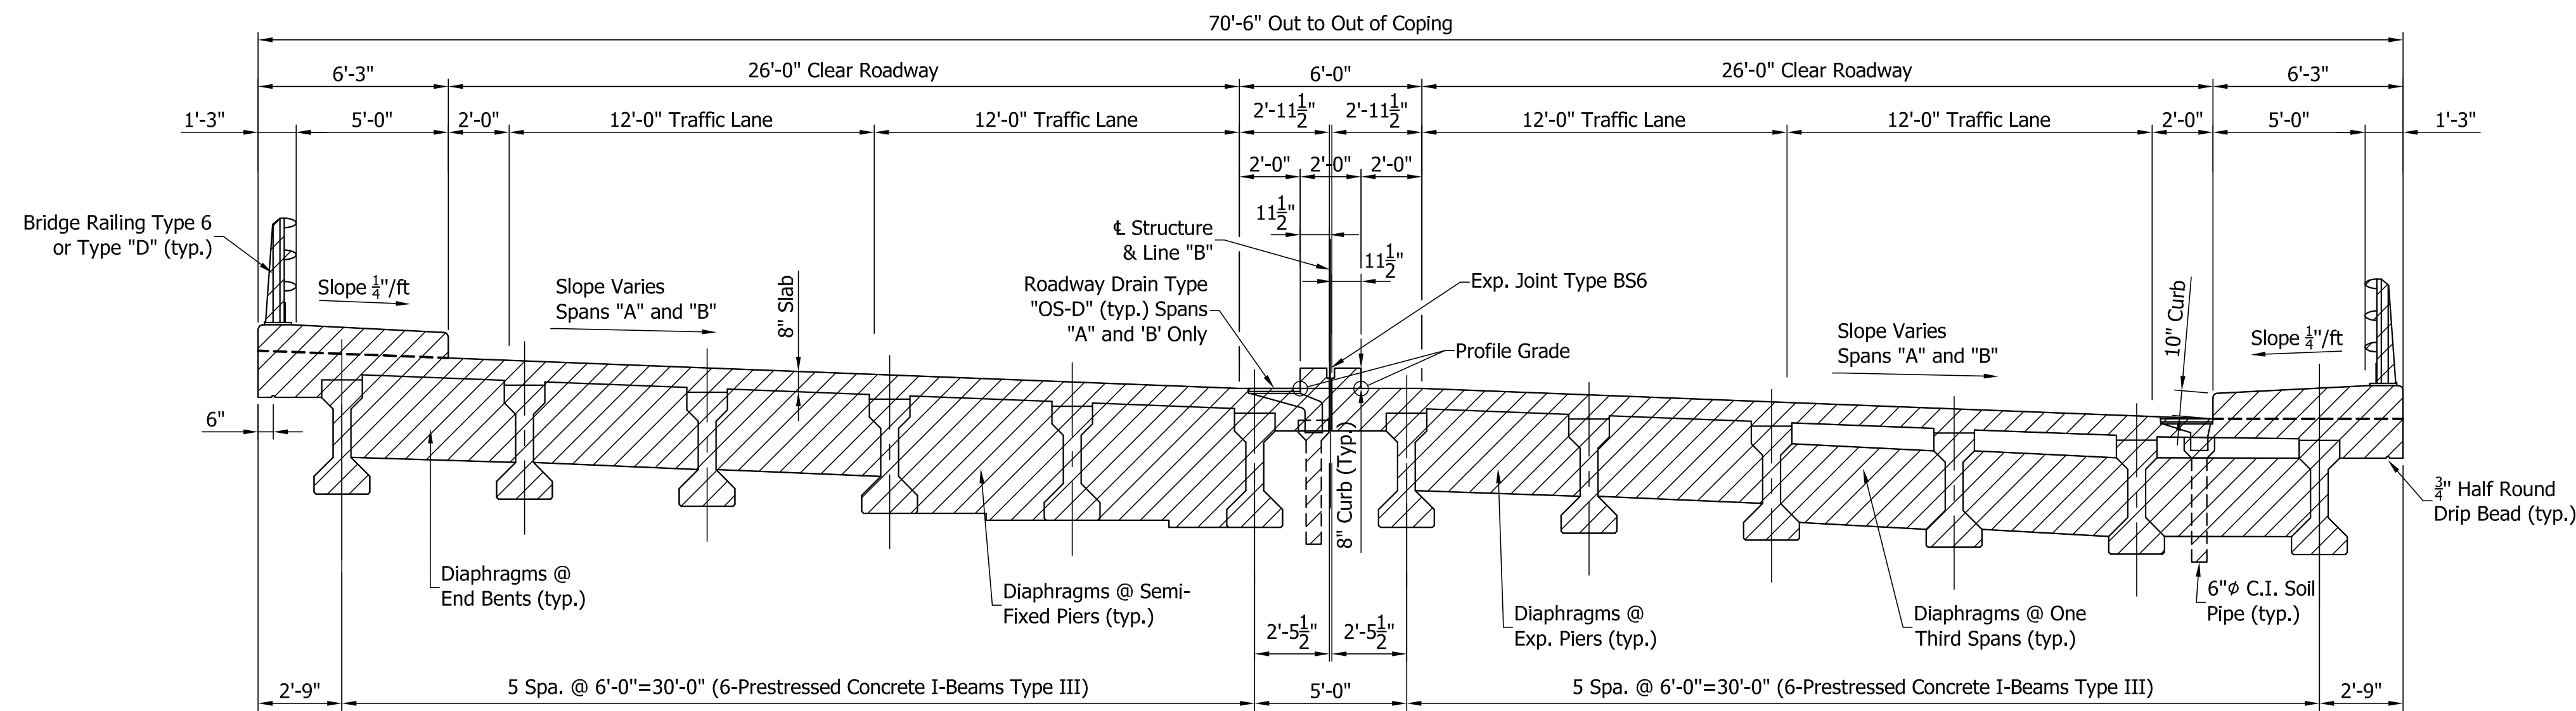

SECTION "A-A" SUPERELEVATED SPANS "A" and "B"
Scale: 1/4"=1'-0"

NOTE: Hatched area indicates entire superstructure to be removed

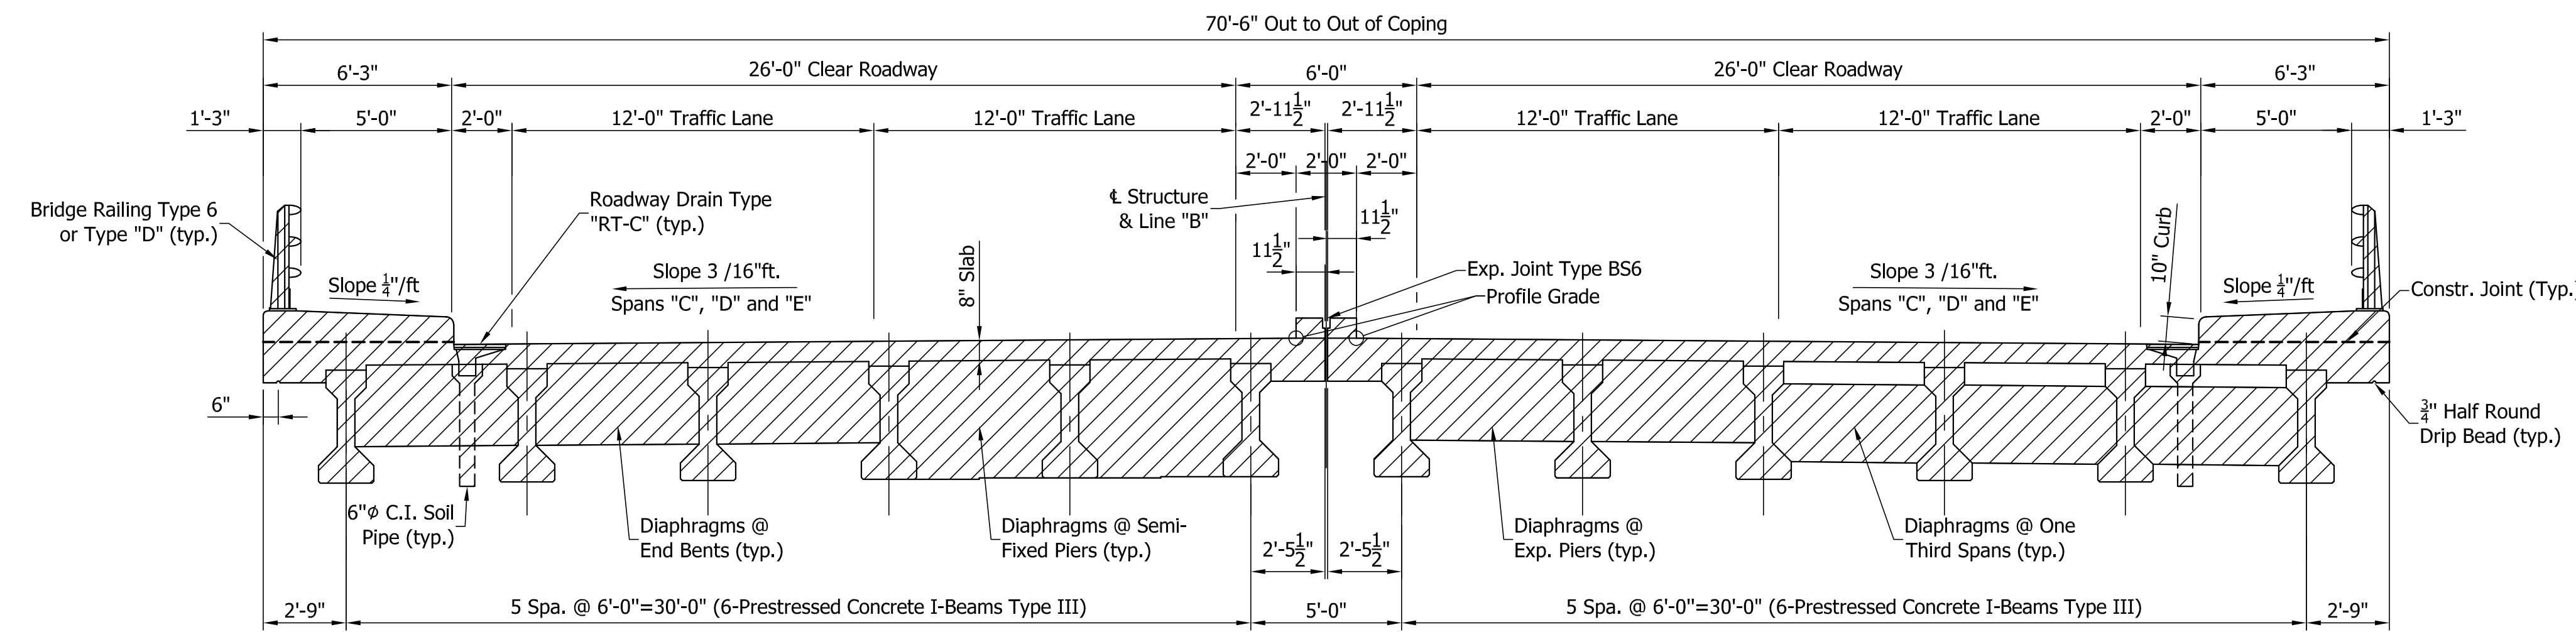

SECTION "A-A" CROWNED SPANS "C", "D" &"E"
Scale: 1/4"=1'-0"

EXISTING
CONTINUOUS COMPOSITE PRESTRESSED
CONCRETE I-BEAM BRIDGE
5 SPANS: 65'-0", 65'-0", 65'-0", 70'-0", 65'-0", SQUARE
CLEAR ROADWAY WIDTH: 2 @ 28'-0"
BLUFFTON ROAD OVER ST. MARY'S RIVER
ALLEN COUNTY, INDIANA


NOT FOR
CONSTRUCTION

DESIGNED: BMA	DRAWN: DWB
CHECKED: KAM	CHECKED: BMA


INDIANA DEPARTMENT OF TRANSPORTATION	
GENERAL PLAN EXISTING	

HORIZONTAL SCALE AS NOTED	BRIDGE FILE ALLEN 358
VERTICAL SCALE AS NOTED	DESIGNATION 1902834
SURVEY BOOK ---	SHEETS 36 of 63
CONTRACT B-42844	PROJECT 1902834

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PROPOSED ELEVATION
Scale: 1/16"=1'-0"

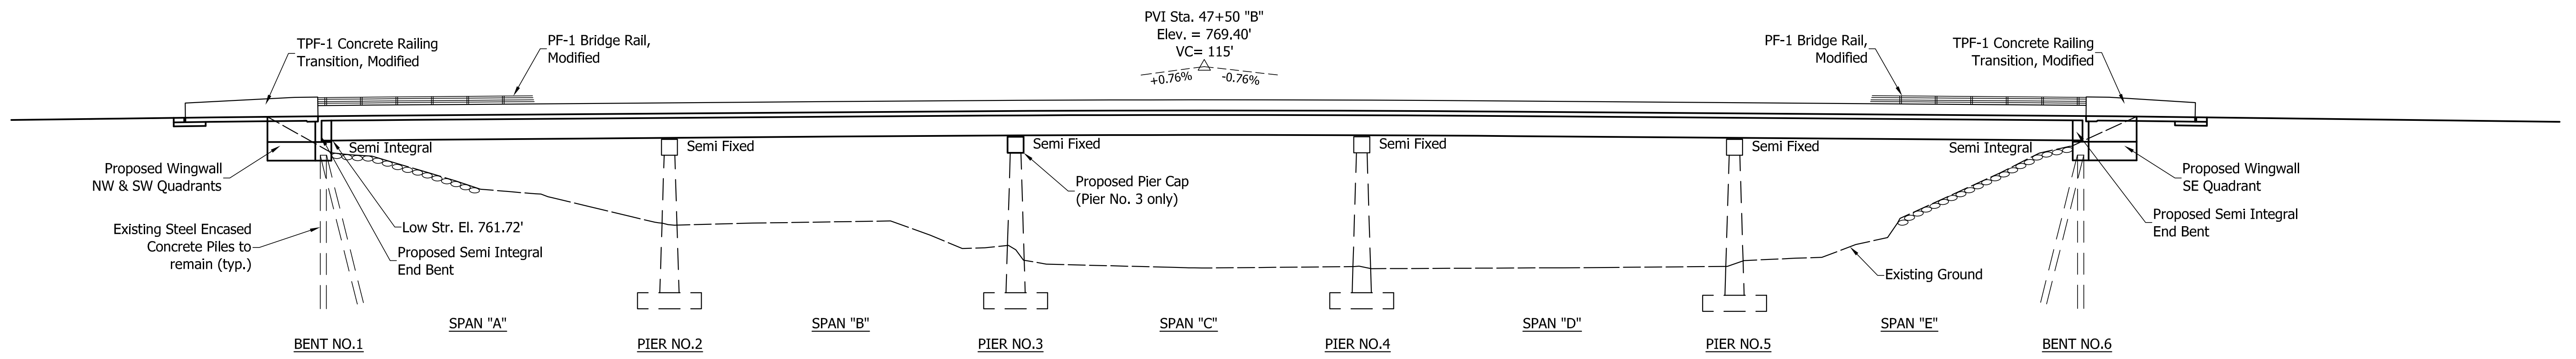

PROPOSED PLAN
Scale: 1/16"=1'-0"

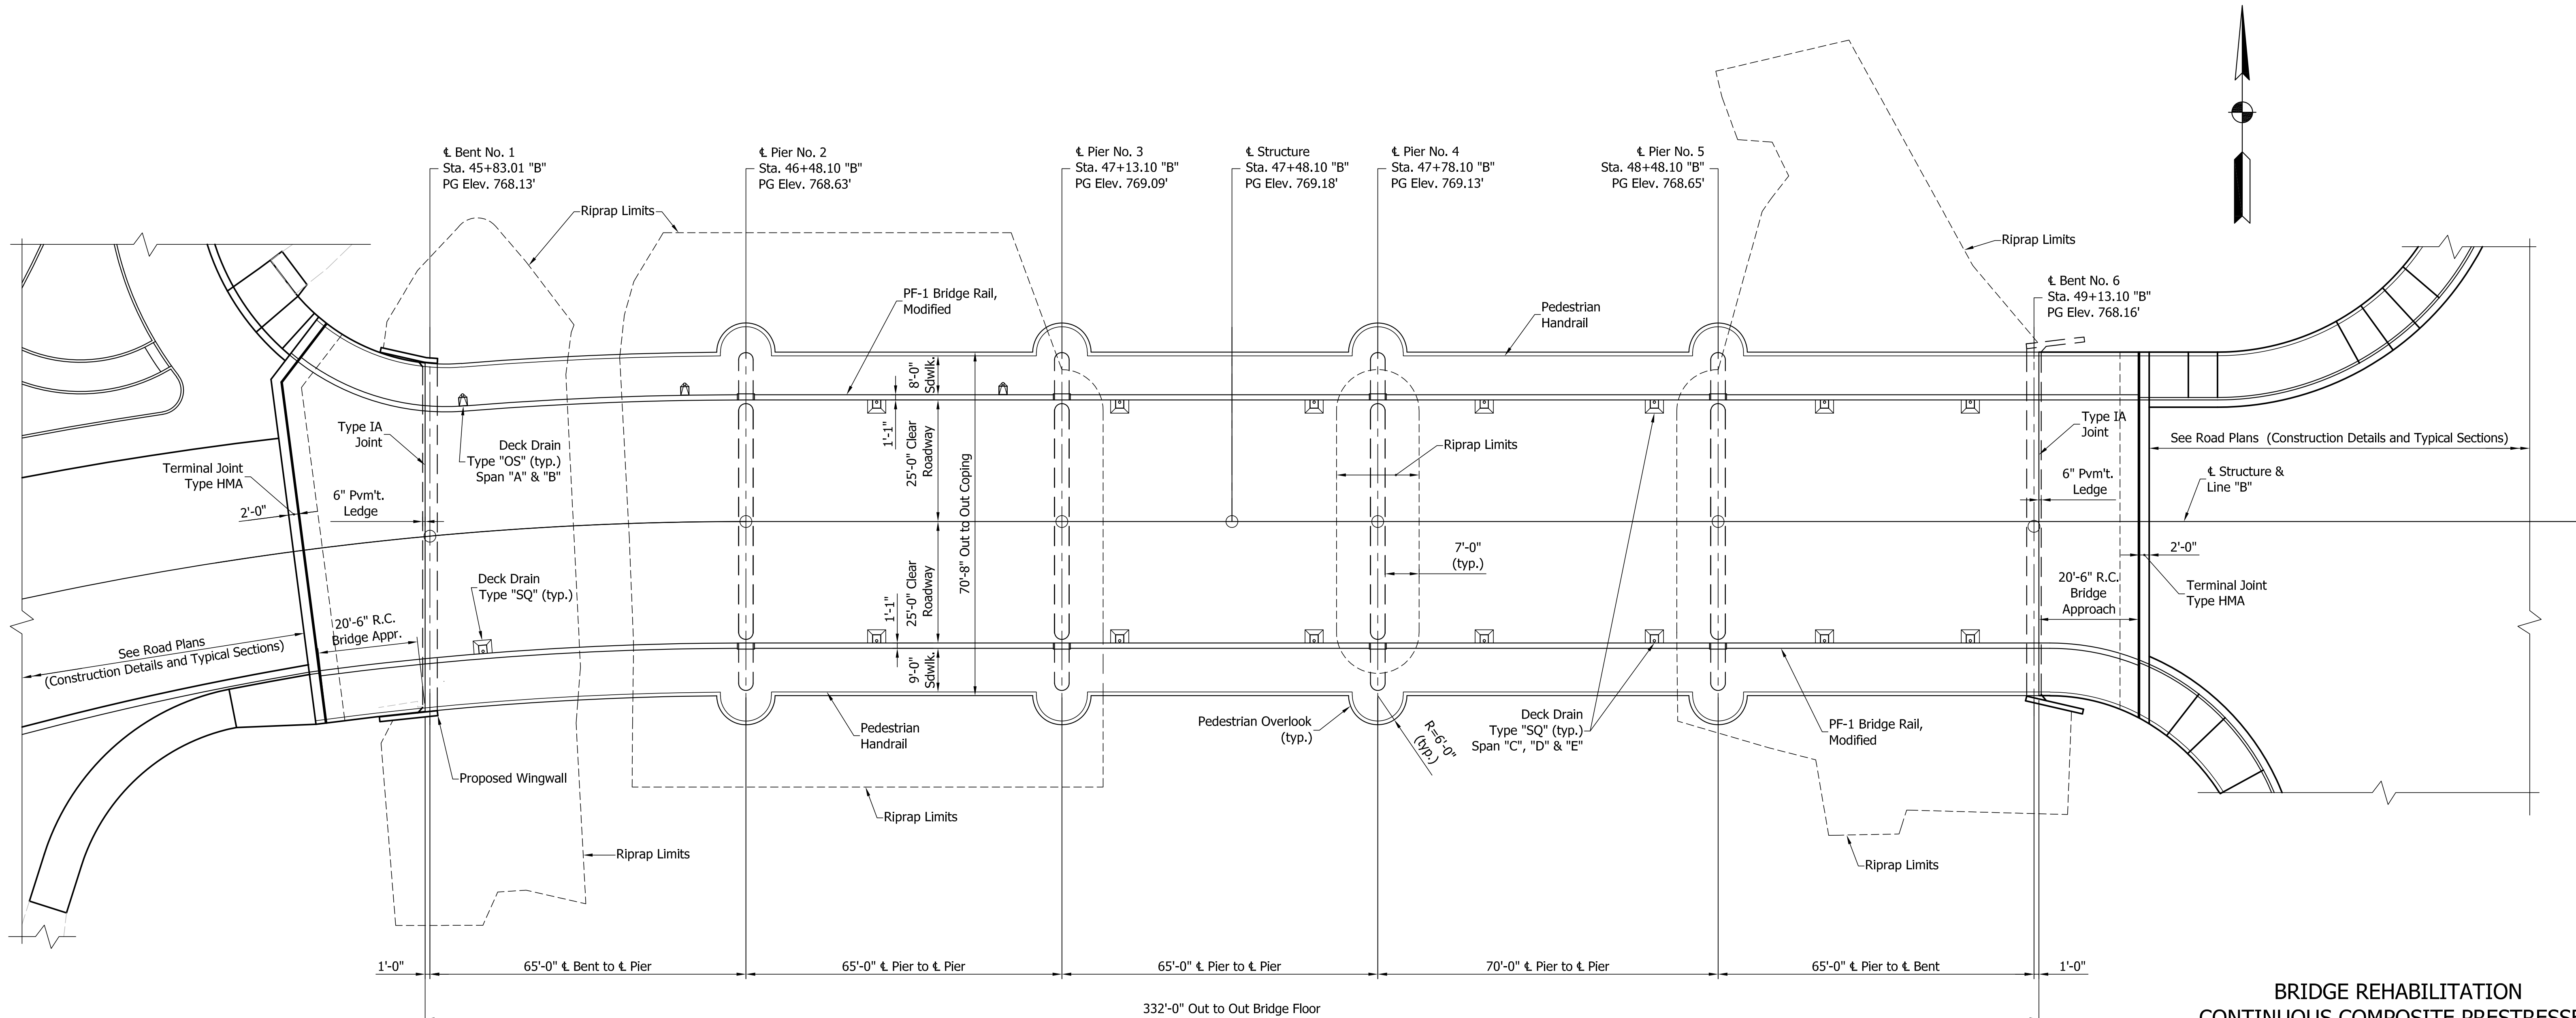BRIDGE REHABILITATION
CONTINUOUS COMPOSITE PRESTRESSED
CONCRETE I-BEAM BRIDGE
5 SPANS: 65'-0", 65'-0", 65'-0", 70'-0", 65'-0", SQUARE
CLEAR ROADWAY WIDTH: 2 @ 25'-0"
BLUFFTON ROAD OVER ST. MARY'S RIVER
ALLEN COUNTY, INDIANA

NOT FOR CONSTRUCTION

DESIGNED: BMA	DRAWN: DWB
CHECKED: KAM	CHECKED: BMA

INDIANA
DEPARTMENT OF TRANSPORTATION

GENERAL PLAN
PROPOSED

HORIZONTAL SCALE AS NOTED	BRIDGE FILE ALLEN 358
VERTICAL SCALE AS NOTED	DESIGNATION 1902834
SURVEY BOOK ---	SHEETS 37 of 63
CONTRACT B-42844	PROJECT 1902834

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STRUCTURE DATA TABLE

STRUCTURE NUMBER	LOCATION			SIZE	PIPE TYPE	MANHOLE, INLET, CATCH BASIN, OR SPECIALTY STRUCTURE	LENGTH	RIM ELEVATION	SKEW	COVER	FLOW LINE			SERVICE LIFE	SITE DESIGNATION	PH	BACKFILL METHOD	STRUCTURE BACKFILL TYPE 1	REVTMENT RIPRAP	GEOTEXTILES	CONCRETE CLASS A, FOR STRUCTURES	PIPE END SECTION	GRATED BOX END SECTION			SAFETY METAL END SECTION		CONNECT TO STR. NO.	CULVERT ASSET ID	REMARKS	
	STATION	LEFT, RIGHT, OR CROSS	OFFSET								UP STREAM	DOWN STREAM	YRS										EA	TYPE	SLOPE	EA	SLOPE				EA
Proposed Structures																															
10	42+78 "B"	Lt	5.0	15	2	Inlet Type "M-10"	2	761.43			755.42	755.42	75	N	7																
11	42+90 "B"	Lt	4.2	24	2	Manhole Type "J-10"	1	761.64			755.40	755.39	75	N	7																
12	43+00 "B"	Rt	33.1	15	2	Manhole Type "C-10"	14	761.09			755.33	755.13	75	N	7																
13	43+05 "B"	Lt	5.0	15	2	Inlet Type "J-10"	12	761.97			757.47	757.42	75	N	7													11			
14	44+67 "B"	Rt	28.6	24	2	Manhole Type "J-10"	4	764.66			755.02	754.97	75	N	7																
15	46+06 "B"	Rt	71.6	24	1	Type 1 Pipe	23	---			750.92	749.29	75	N	7						2										
Existing Structures																															
201	41+53 "B"	Rt	33.6			Existing Inlet																									No Change Req'd.
202	41+60 "B"	Rt	33.6			Existing Inlet																									No Change Req'd.
203	41+61 "B"	Rt	45.5			Existing Inlet																									No Change Req'd.
204	43+08 "B"	Rt	48.1			Existing Inlet																									Connect Proposed 15" Pipe (Str No. 12)
205	43+15 "B"	Rt	47.0			Existing Inlet																									No Change Req'd.
207	44+67 "B"	Rt	28.6			Existing Inlet																									Remove Inlet
208	41+54 "B"	Lt	28.2			Existing Inlet																									No Change Req'd.
209	41+60 "B"	Lt	27.7			Existing Inlet																									No Change Req'd.
210	41+60 "B"	Lt	36.4			Existing Manhole																									No Change Req'd.
211	41+59 "B"	Lt	44.8			Existing Inlet																									No Change Req'd.
212	41+66 "B"	Lt	44.6			Existing Inlet																									No Change Req'd.
213	41+85 "B"	Lt	45.9			Existing Inlet																									No Change Req'd.
214	42+70 "B"	Lt	45.0			Existing Inlet																									No Change Req'd.
215	42+78 "B"	Lt	5.0			Existing Inlet																									Remove Inlet
228	10+35 "C"	Lt	16.2			Existing Inlet																									Adjust Casting to Grade
229	10+51 "C"	Lt	12.2			Existing Inlet																									Furnish Casting and Adjust to Grade
230	10+30 "C"	Rt	17.2			Existing Inlet																									Furnish Casting and Adjust to Grade
231	9+69 "S-1-B"	Rt	29.9			Existing Inlet																									Adjust Casting to Grade
232	10+41 "C"	Rt	1.5			Existing Inlet																									Adjust Casting to Grade
233	10+50 "C"	Lt	3.1			Existing Manhole																									Adjust Casting to Grade
234	9+13 "S-1-B"	Lt	87.1			Existing Manhole																									No Change Req'd.
235	49+28 "B"	Lt	104.4			Existing Manhole																									No Change Req'd.
237	42+64 "B"	Lt	33.5			Existing Manhole																									No Change Req'd.

NOT FOR CONSTRUCTION


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 CHECKED: _____ KAM CHECKED: _____ BMA

INDIANA DEPARTMENT OF TRANSPORTATION


STRUCTURE DATA TABLE
BLUFFTON RROAD / BROADWAY

HORIZONTAL SCALE	BRIDGE FILE
N/A	ALLEN 358
VERTICAL SCALE	DESIGNATION
N/A	1902834
SURVEY BOOK	SHEETS
----	40 of 63
CONTRACT	PROJECT
B-42844	1902834


41+75

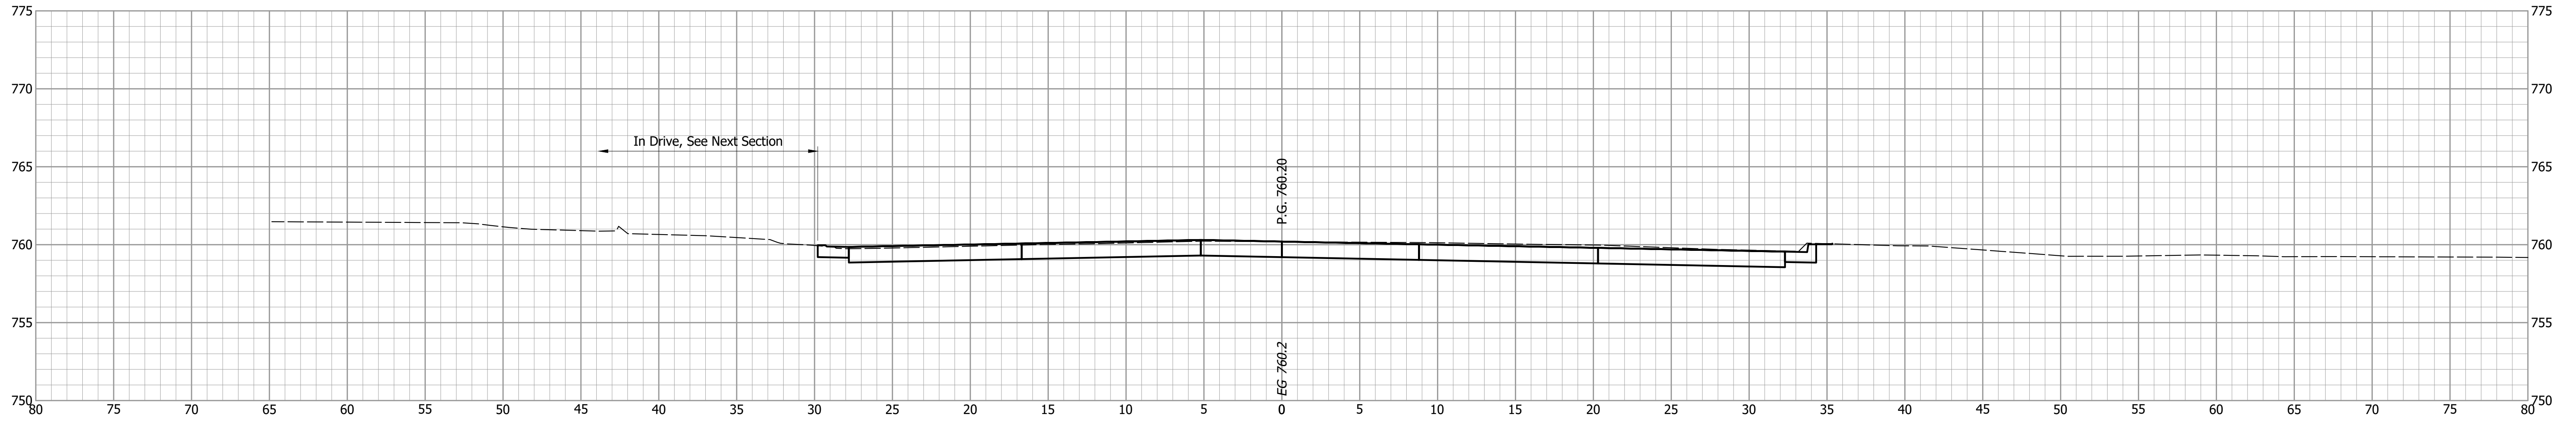

41+65

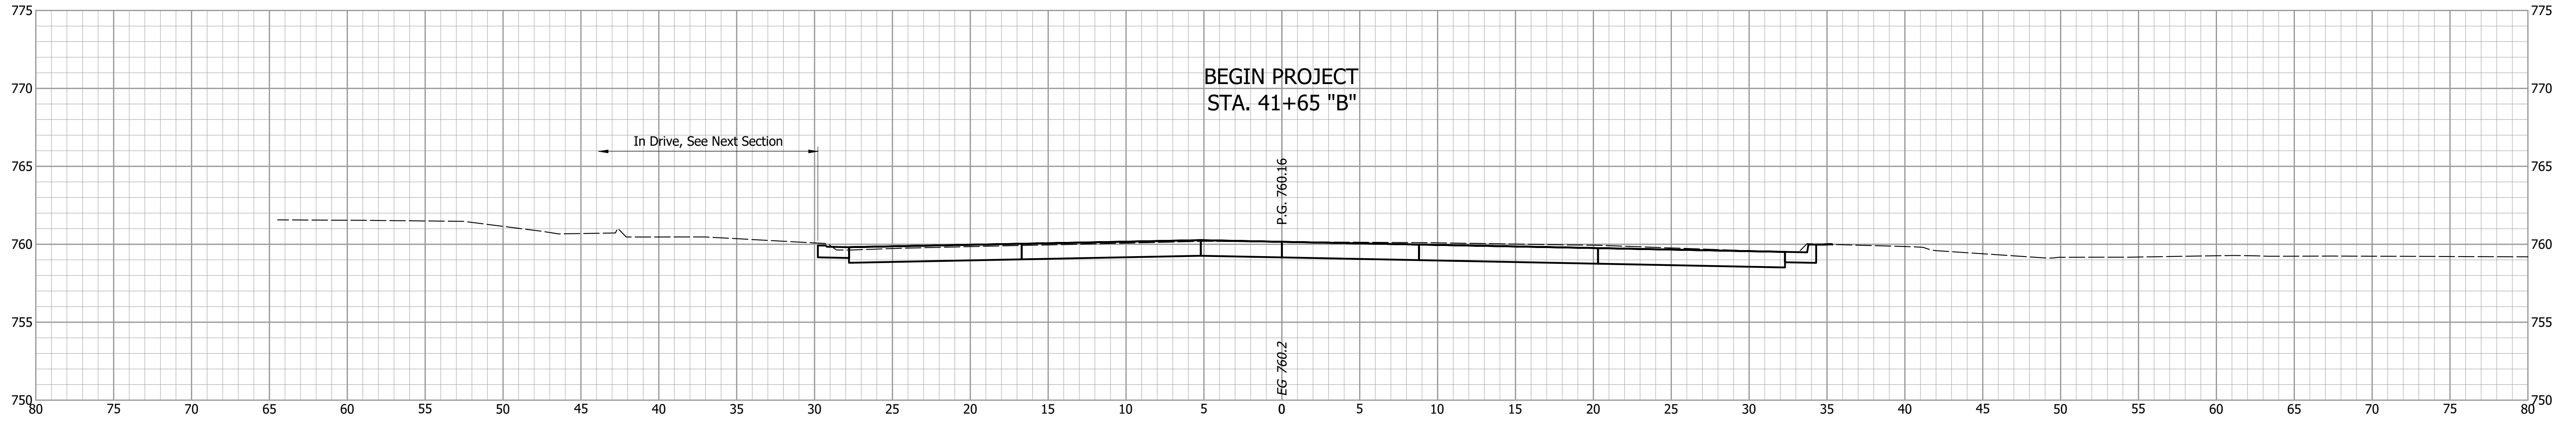

41+60

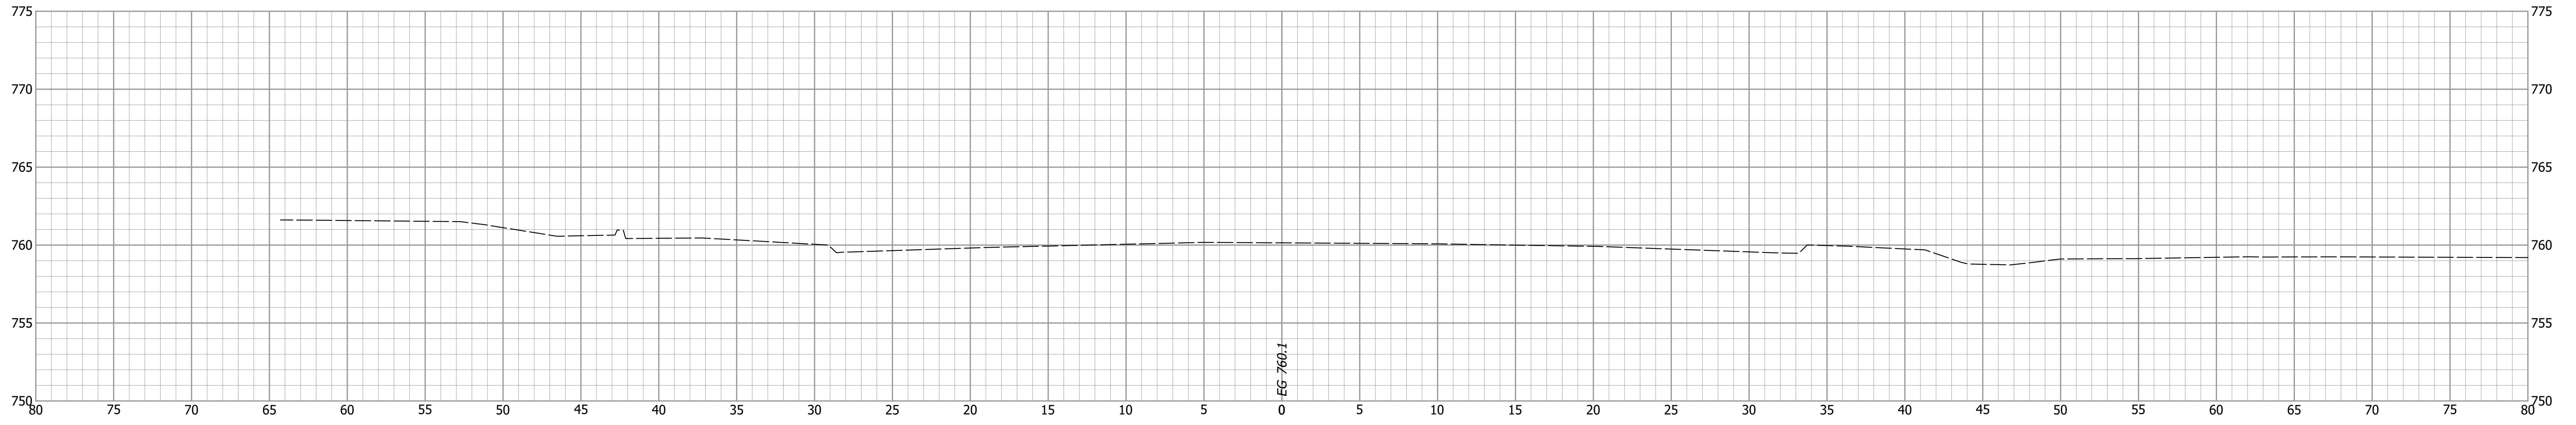


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 CHECKED: KAM CHECKED: BMA


INDIANA DEPARTMENT OF TRANSPORTATION
CROSS SECTIONS
LINE "B" - BLUFFTON ROAD

HORIZONTAL SCALE 1" = 5'	BRIDGE FILE ALLEN 358
VERTICAL SCALE 1" = 5'	DESIGNATION 1902834
SURVEY BOOK ---	SHEETS 41 of 63
CONTRACT B-42844	PROJECT 1902834


42+25

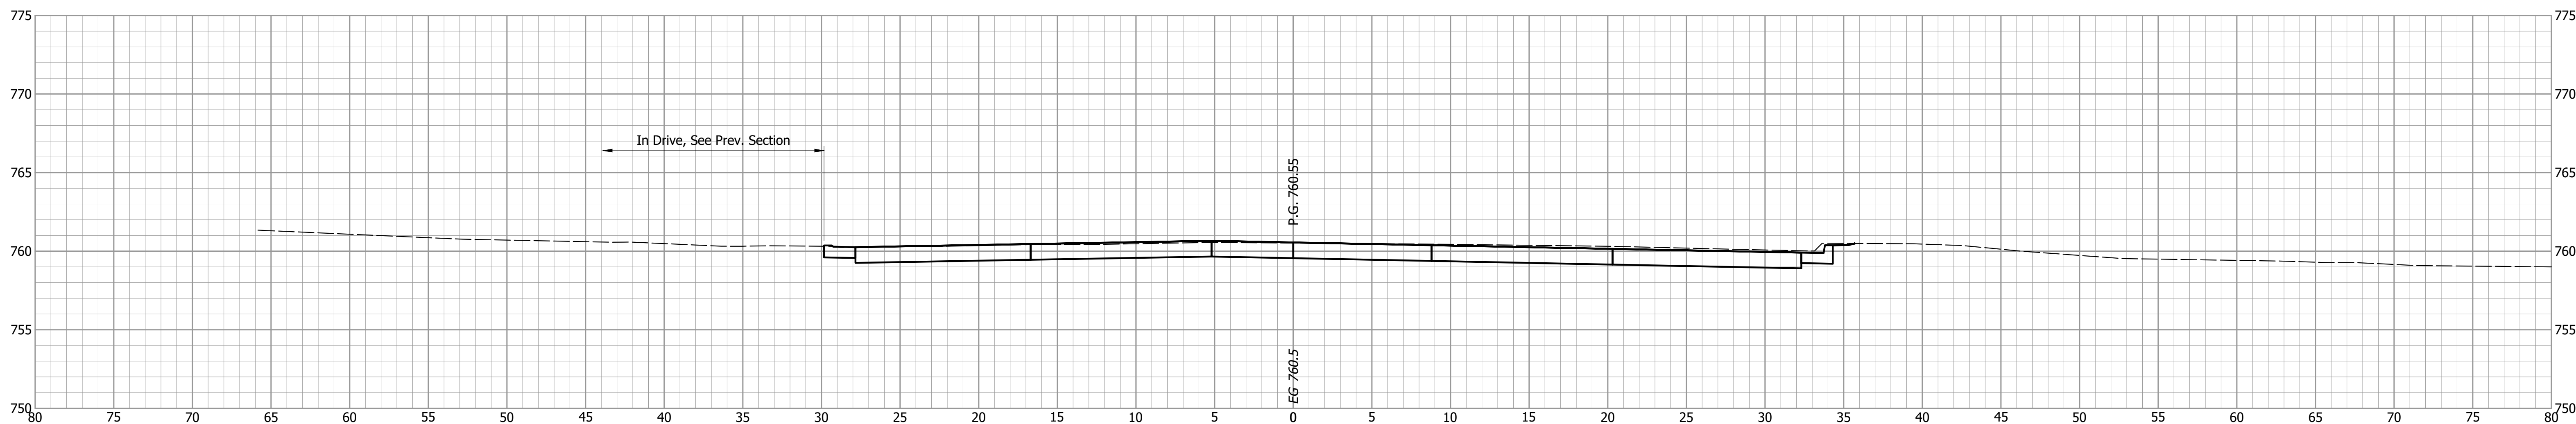

42+08.4

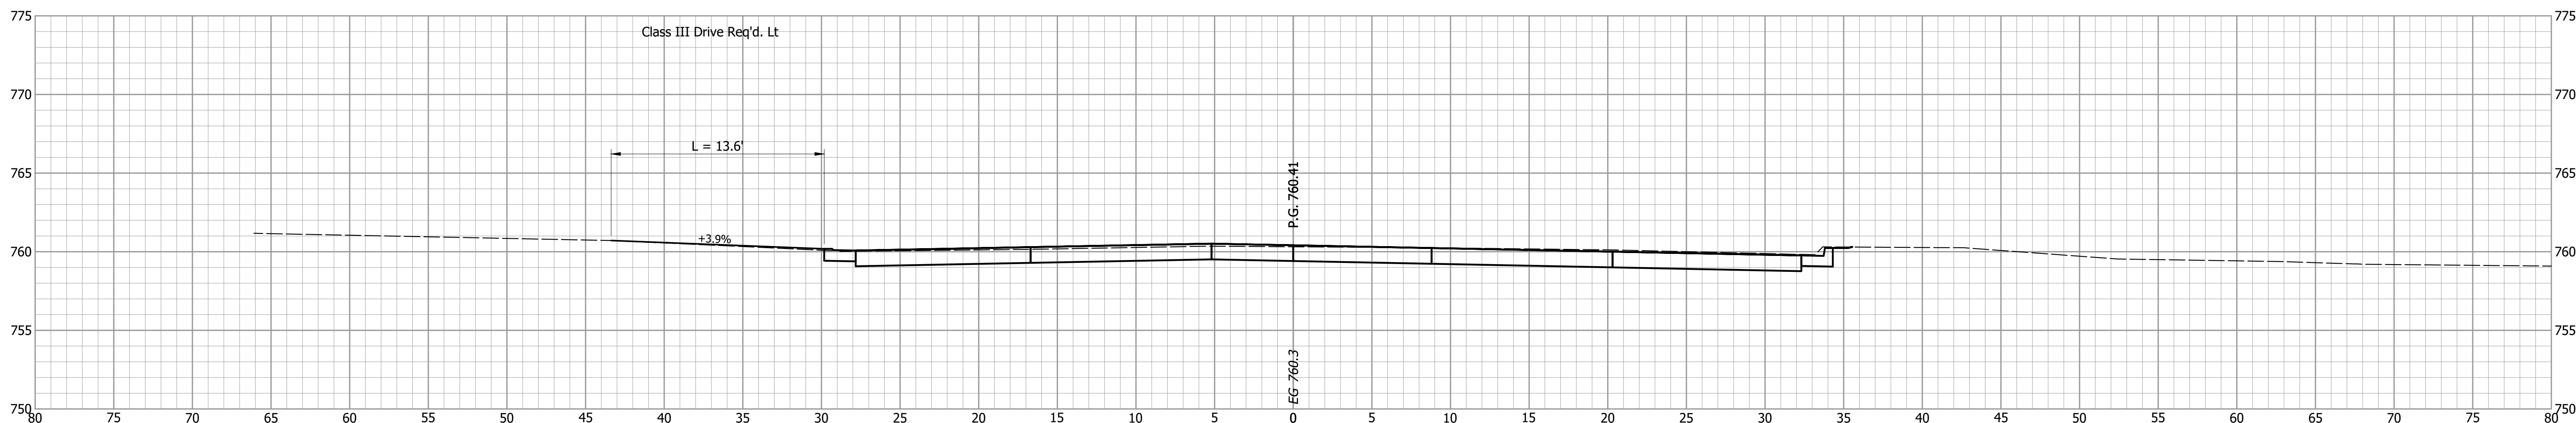

42+00

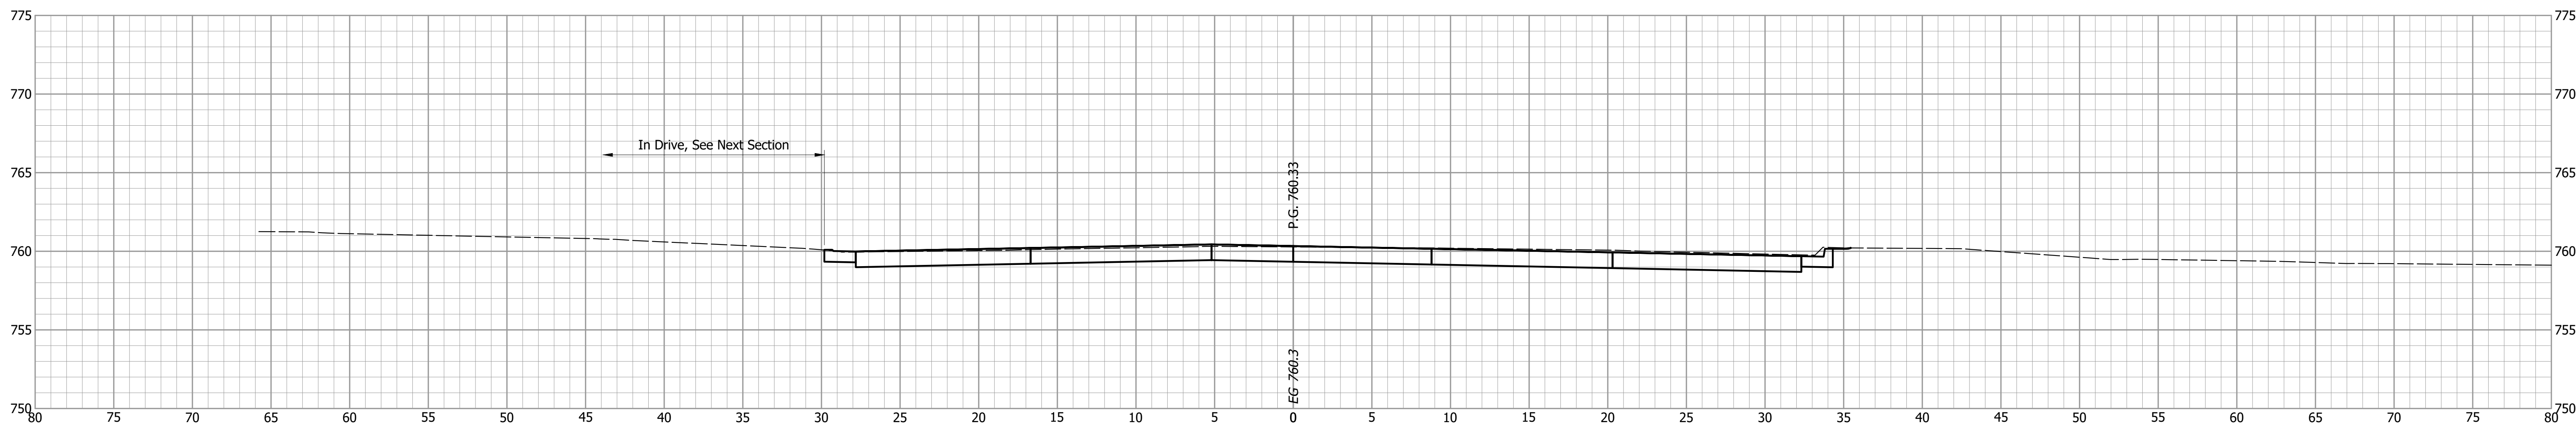


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CONSTRUCTION

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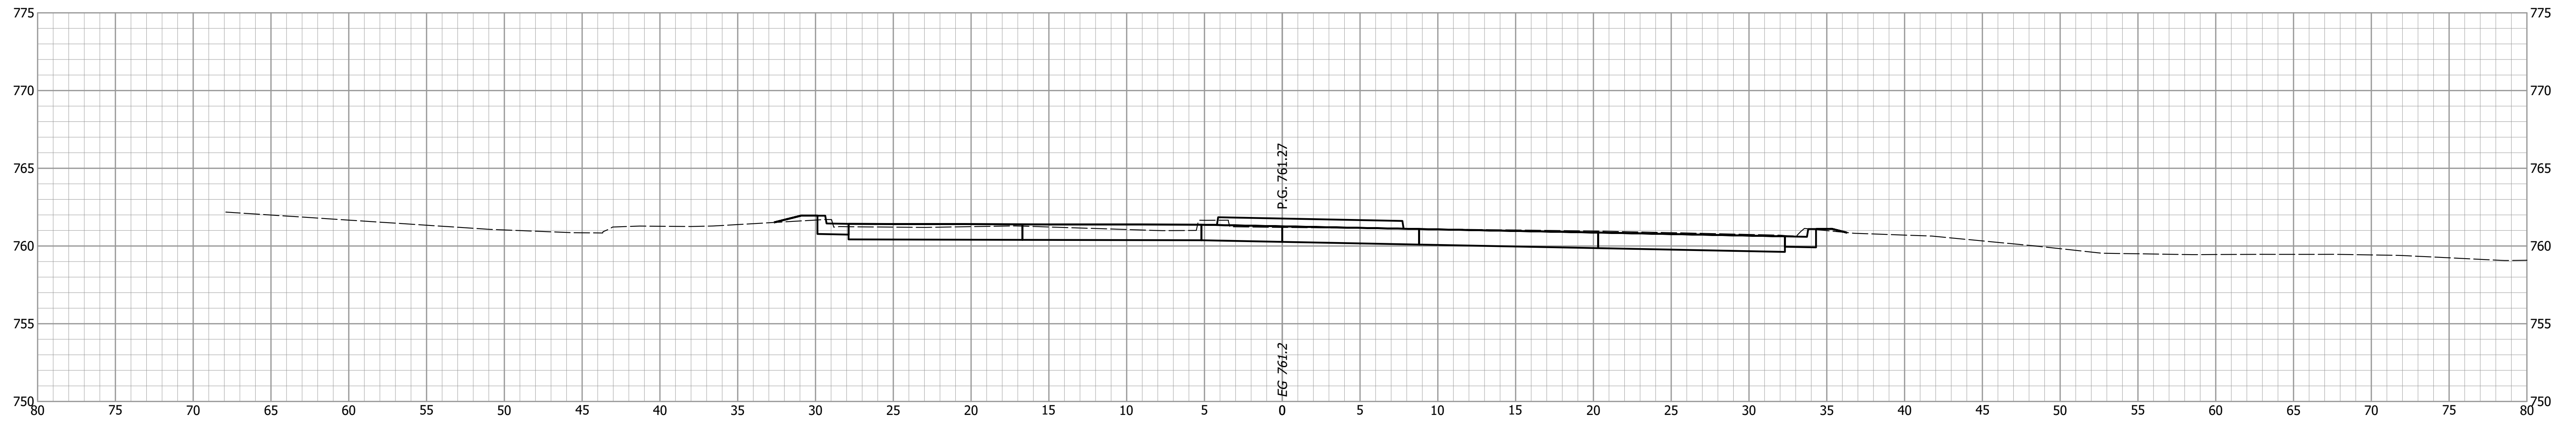
INDIANA
DEPARTMENT OF TRANSPORTATION
CROSS SECTIONS
LINE "B" - BLUFFTON ROAD

HORIZONTAL SCALE 1" = 5'	BRIDGE FILE ALLEN 358
VERTICAL SCALE 1" = 5'	DESIGNATION 1902834
SURVEY BOOK ----	SHEETS 42 of 63
CONTRACT B-42844	PROJECT 1902834


42+78.4

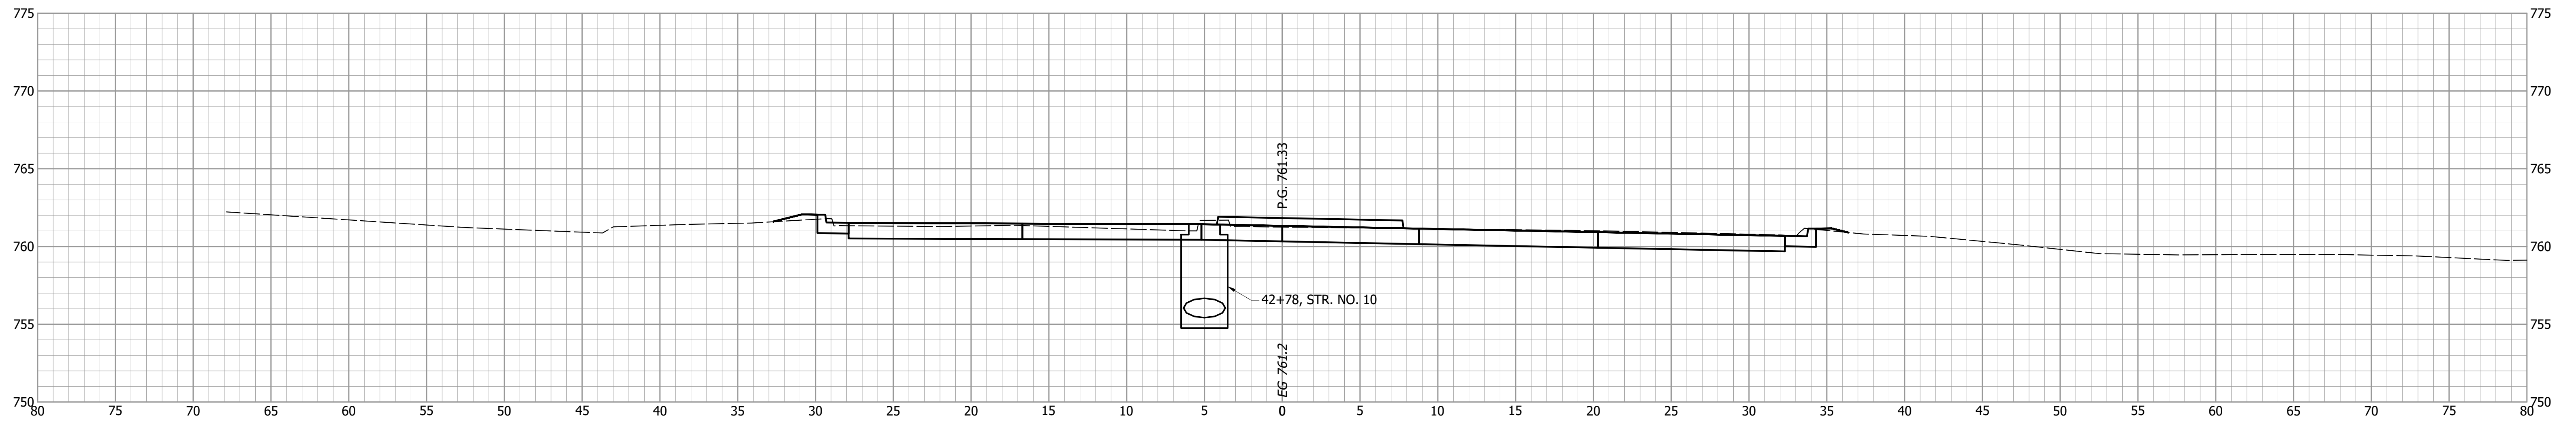

42+75



42+50

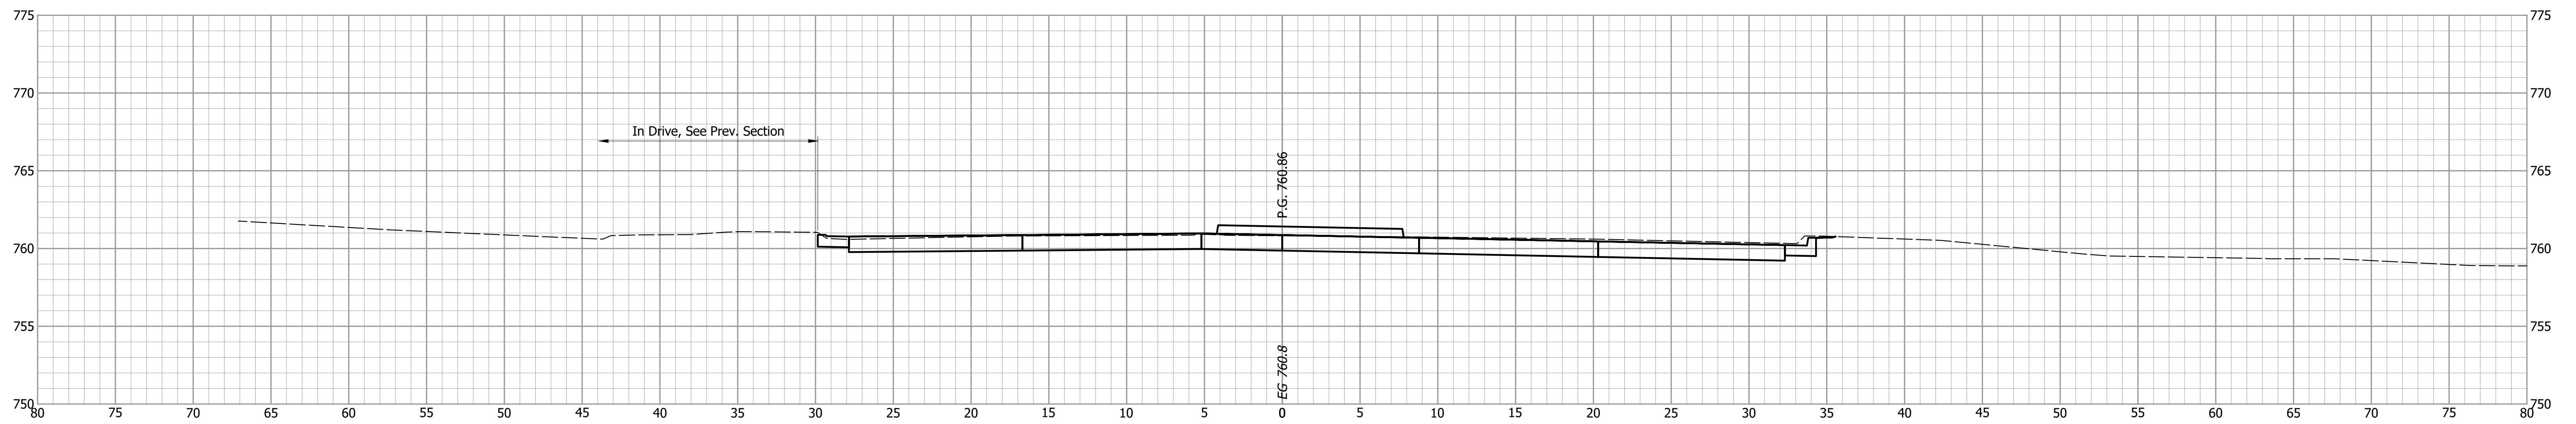

NOT FOR
CONSTRUCTION


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INDIANA
DEPARTMENT OF TRANSPORTATION


CROSS SECTIONS
LINE "B" - BLUFFTON ROAD

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VERTICAL SCALE 1" = 5'	DESIGNATION 1902834
SURVEY BOOK ----	SHEETS 43 of 63
CONTRACT B-42844	PROJECT 1902834


43+25

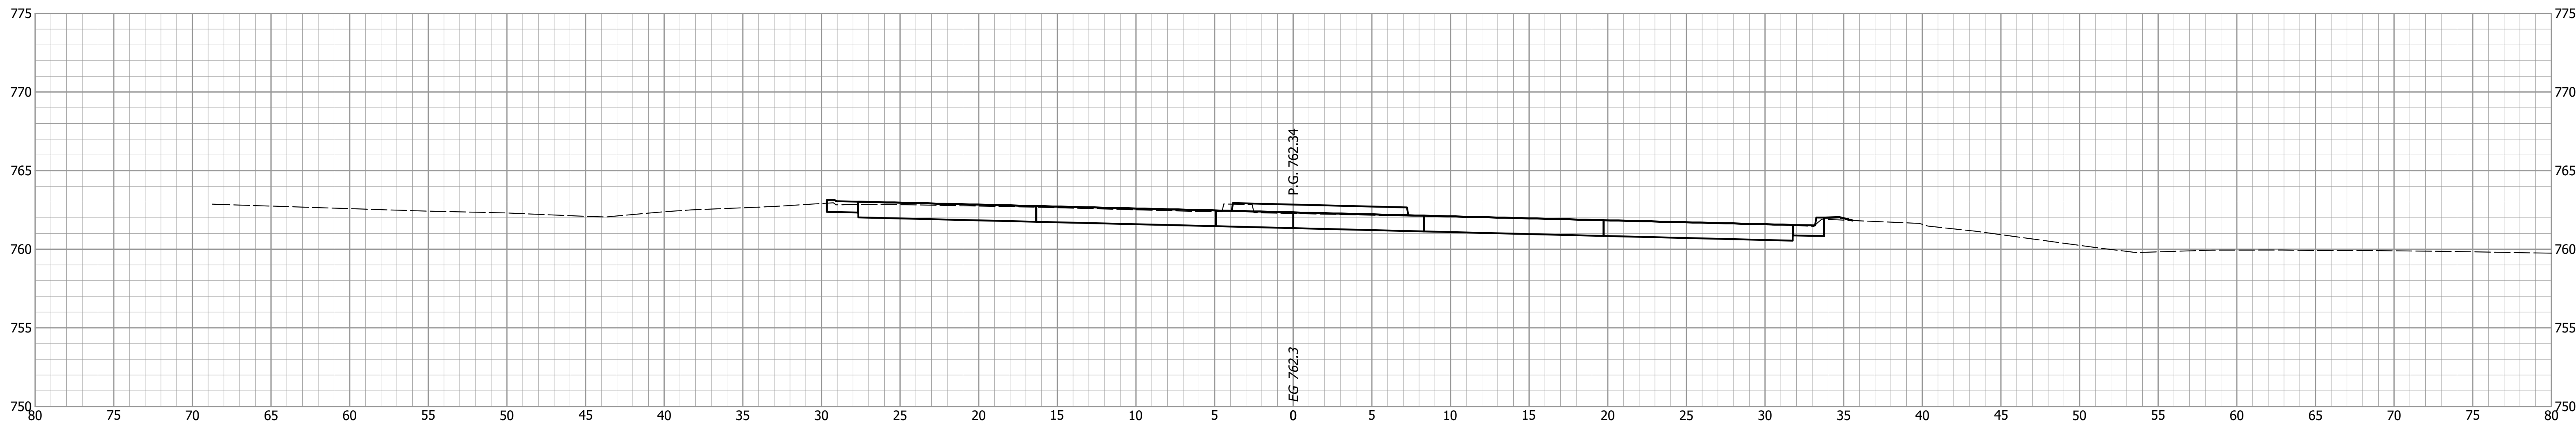

43+16.7

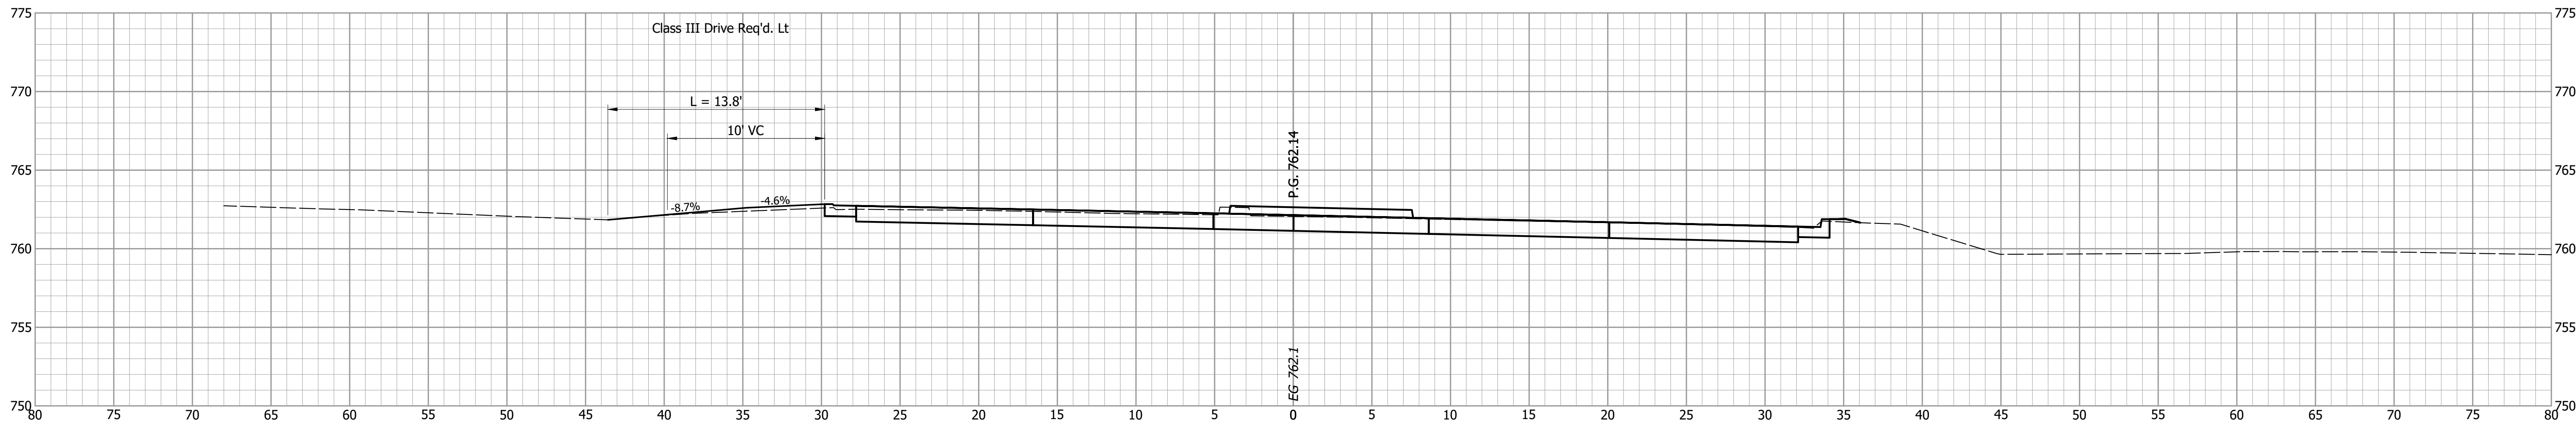

43+00

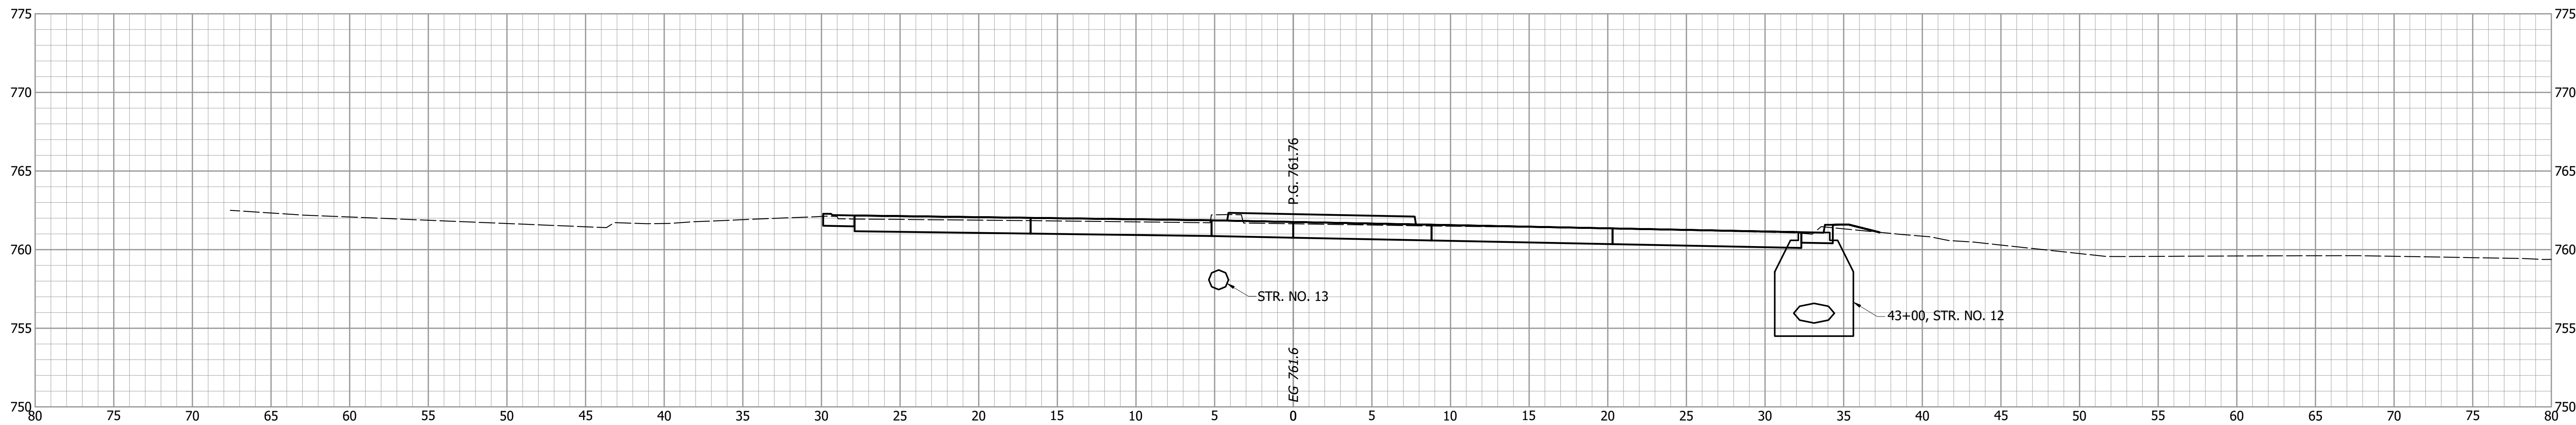

NOT FOR CONSTRUCTION


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INDIANA
 DEPARTMENT OF TRANSPORTATION


CROSS SECTIONS
 LINE "B" - BLUFFTON ROAD

HORIZONTAL SCALE 1" = 5'	BRIDGE FILE ALLEN 358
VERTICAL SCALE 1" = 5'	DESIGNATION 1902834
SURVEY BOOK ---	SHEETS 44 of 63
CONTRACT B-42844	PROJECT 1902834


44+00

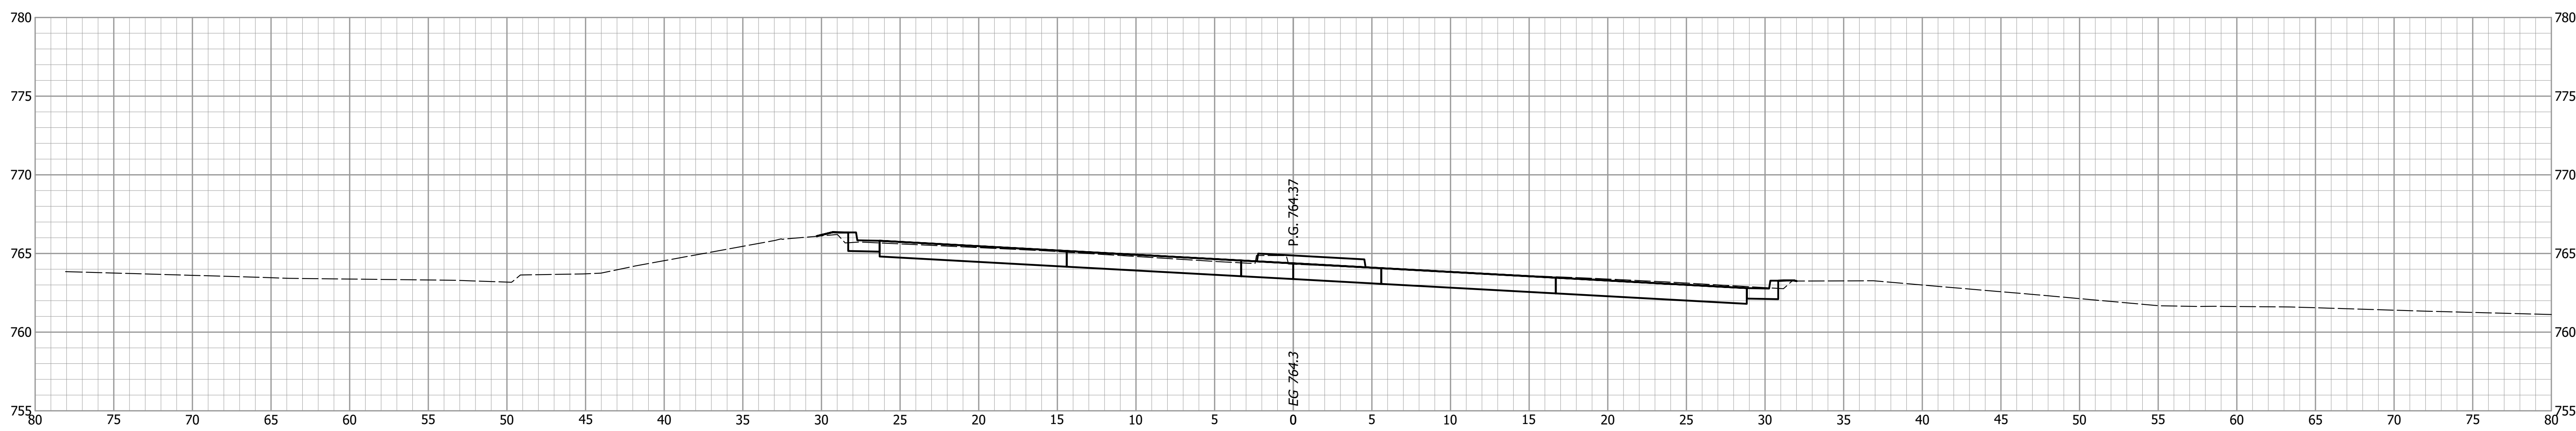

43+75

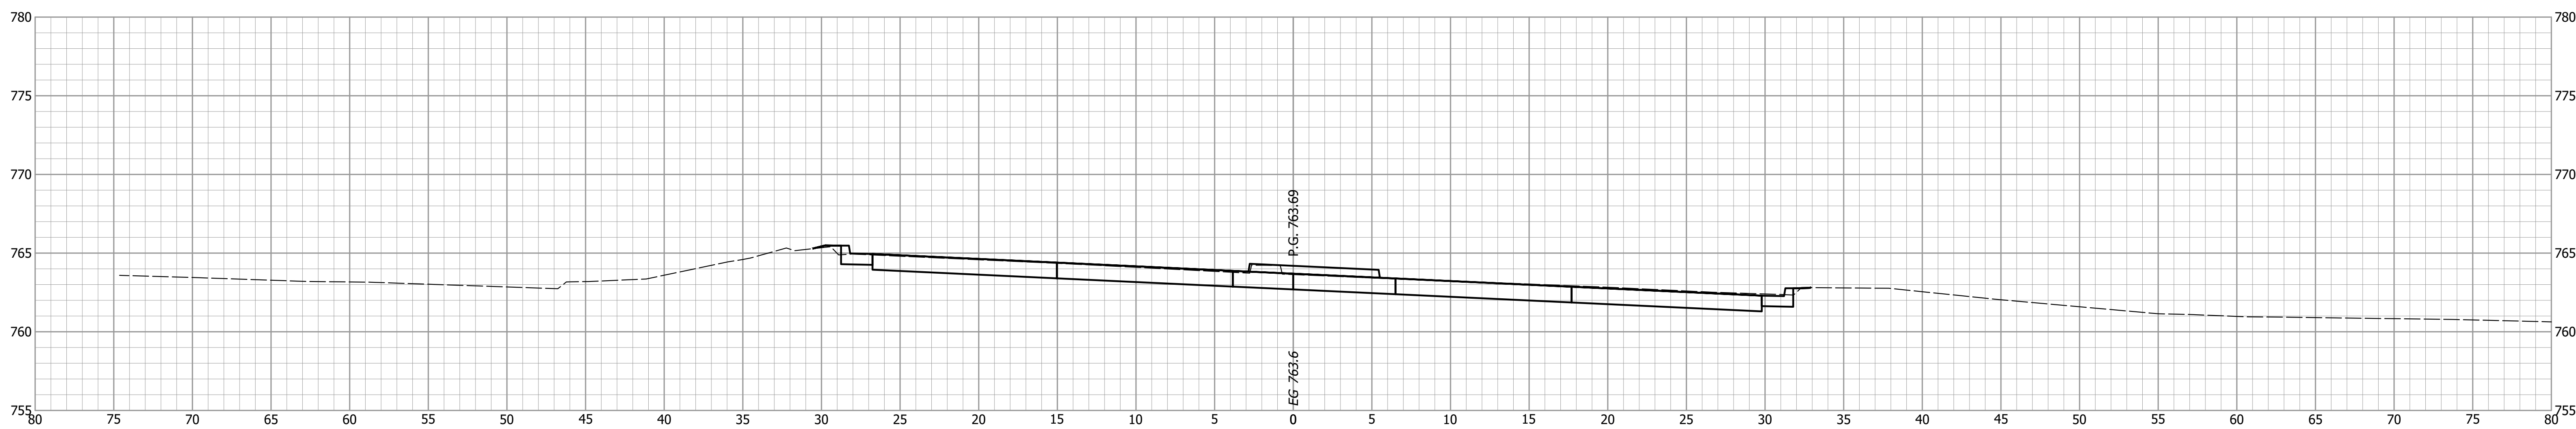

43+50

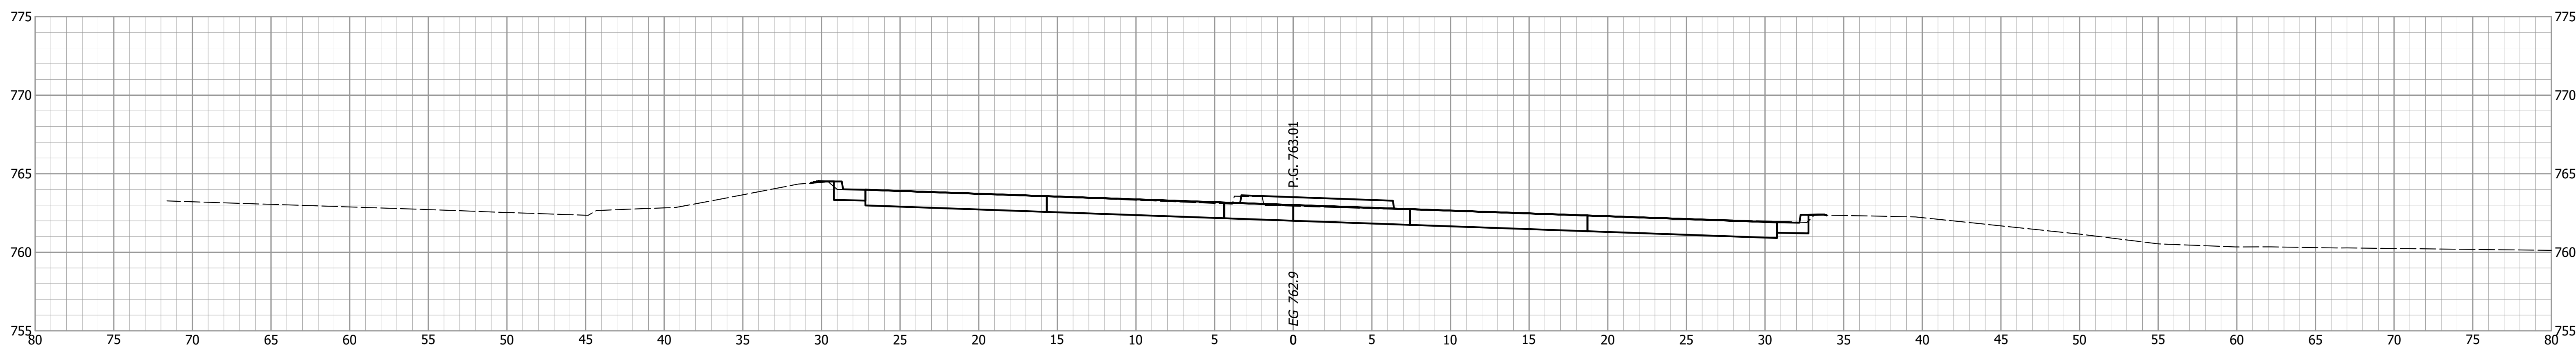

NOT FOR
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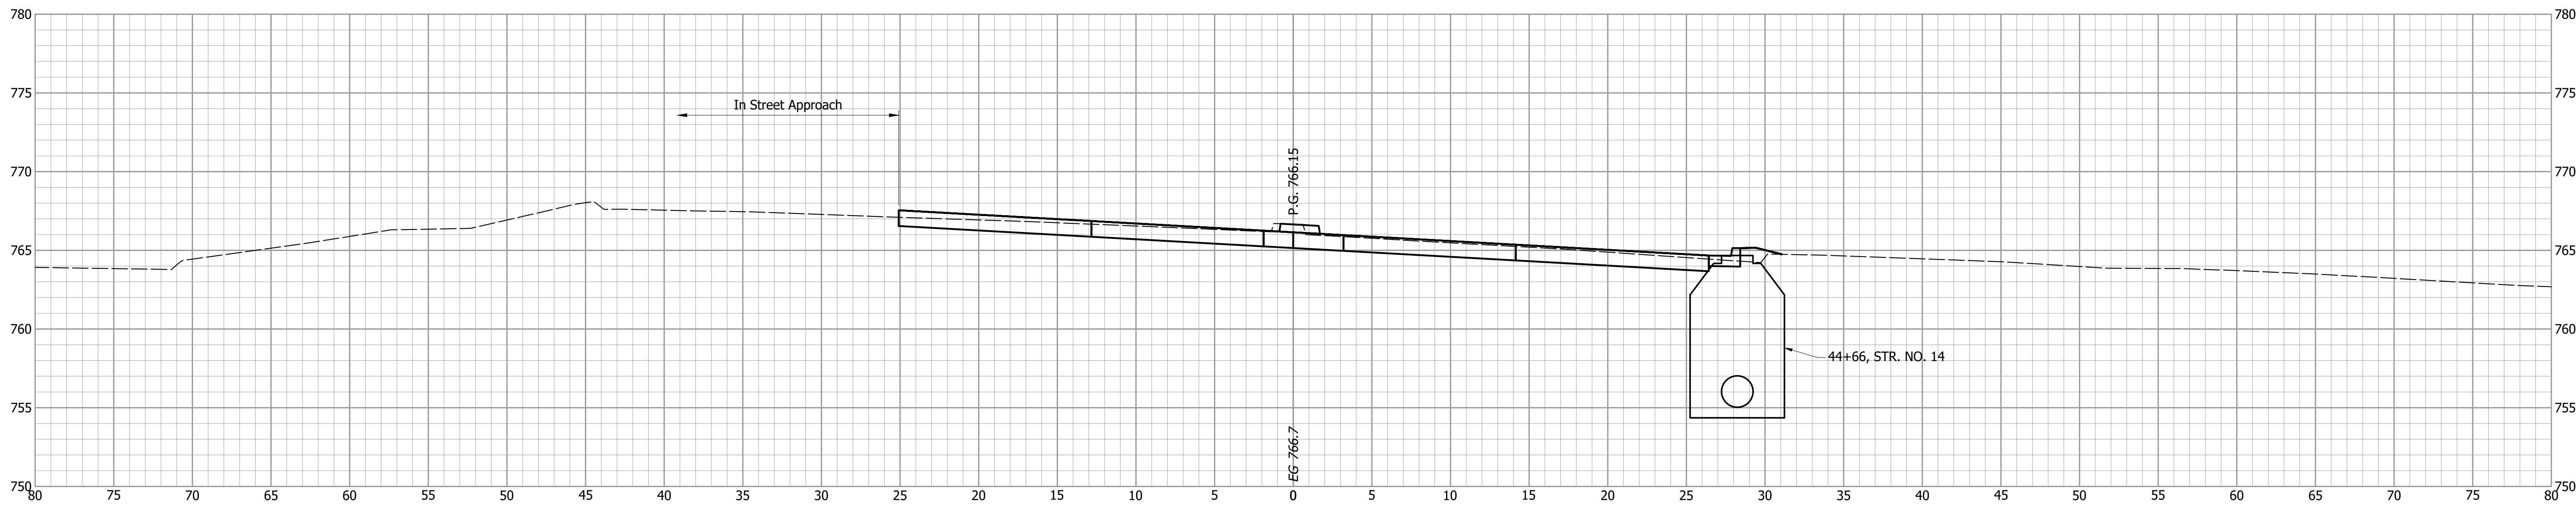
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INDIANA
DEPARTMENT OF TRANSPORTATION


CROSS SECTIONS
LINE "B" - BLUFFTON ROAD

HORIZONTAL SCALE 1" = 5'	BRIDGE FILE ALLEN 358
VERTICAL SCALE 1" = 5'	DESIGNATION 1902834
SURVEY BOOK ----	SHEETS 45 of 63
CONTRACT B-42844	PROJECT 1902834


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44+50



44+25

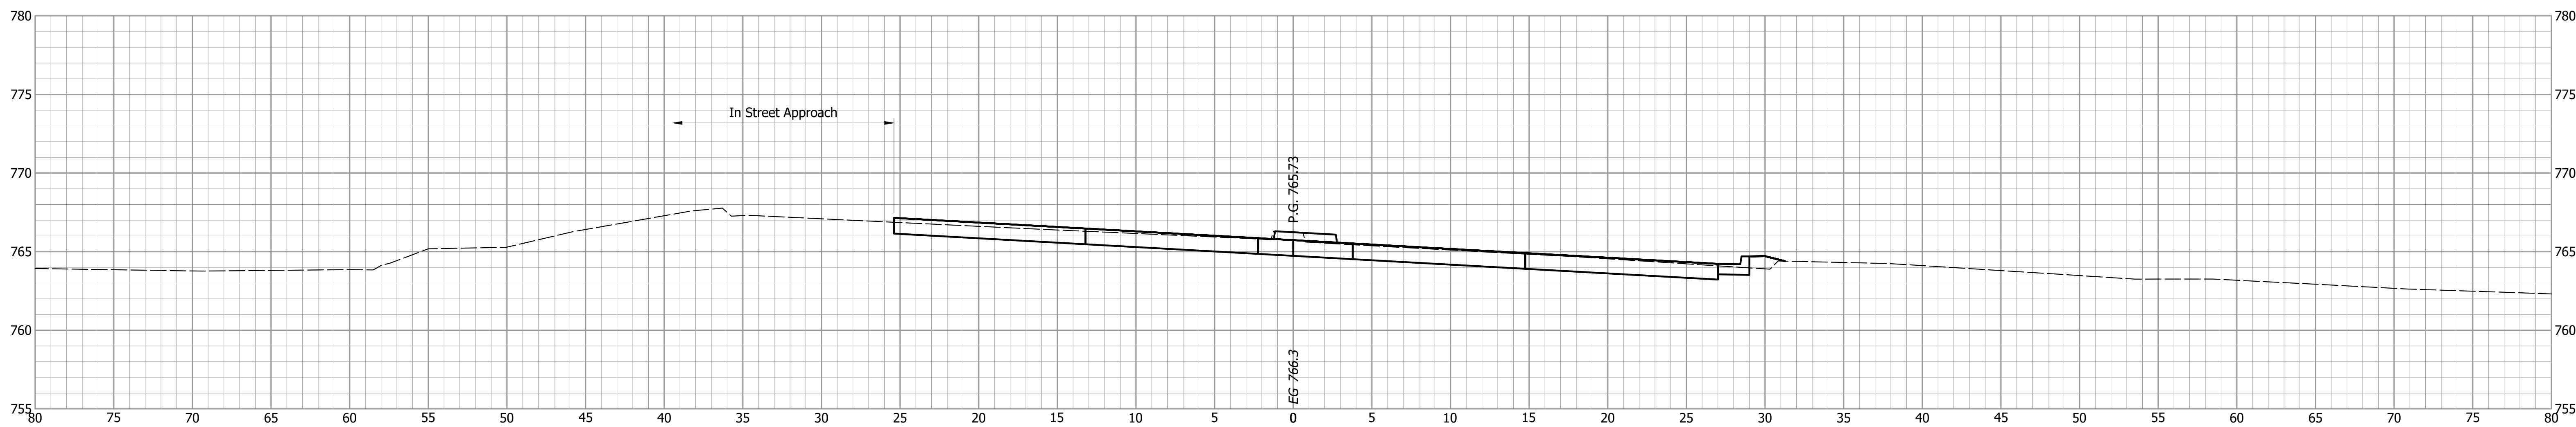


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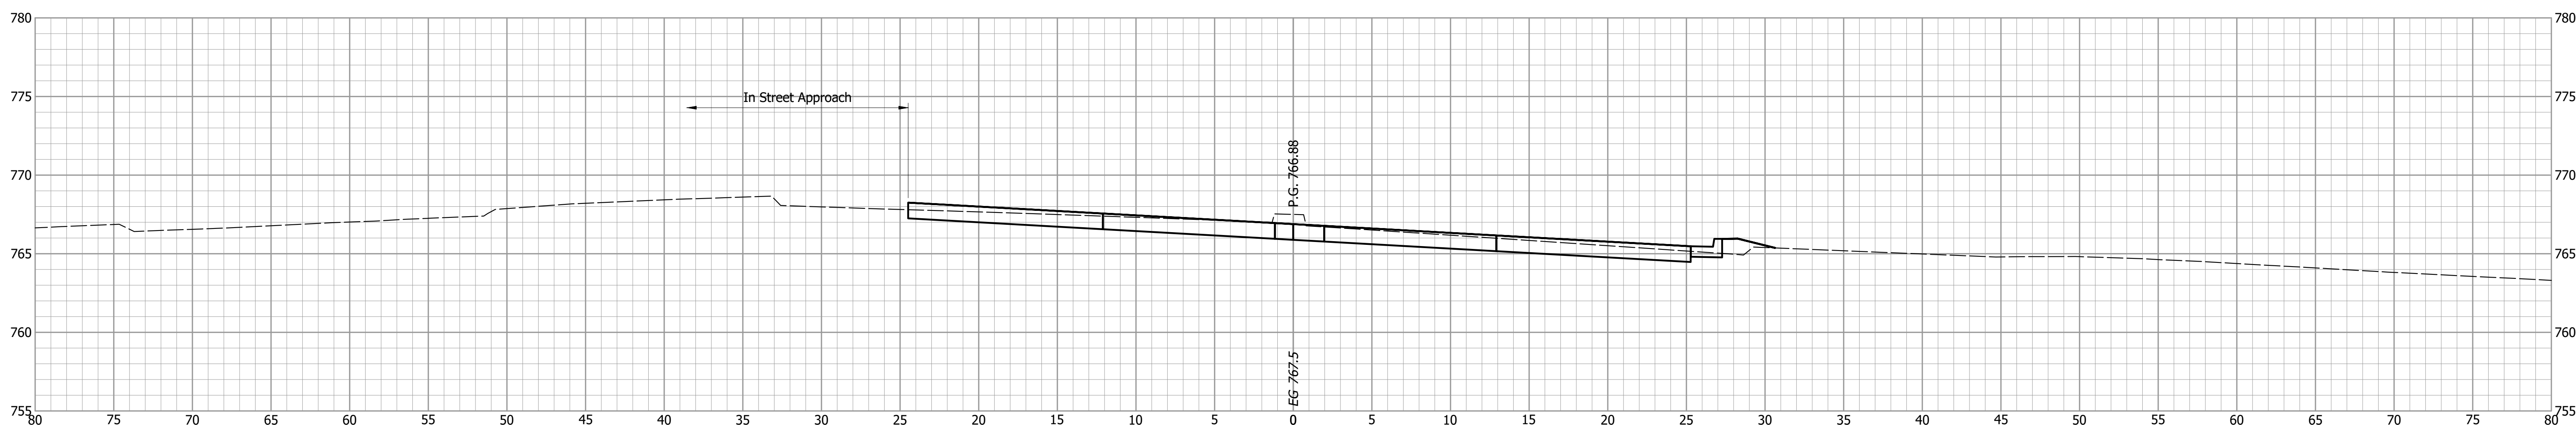
INDIANA
 DEPARTMENT OF TRANSPORTATION
 CROSS SECTIONS
 LINE "B" - BLUFFTON ROAD

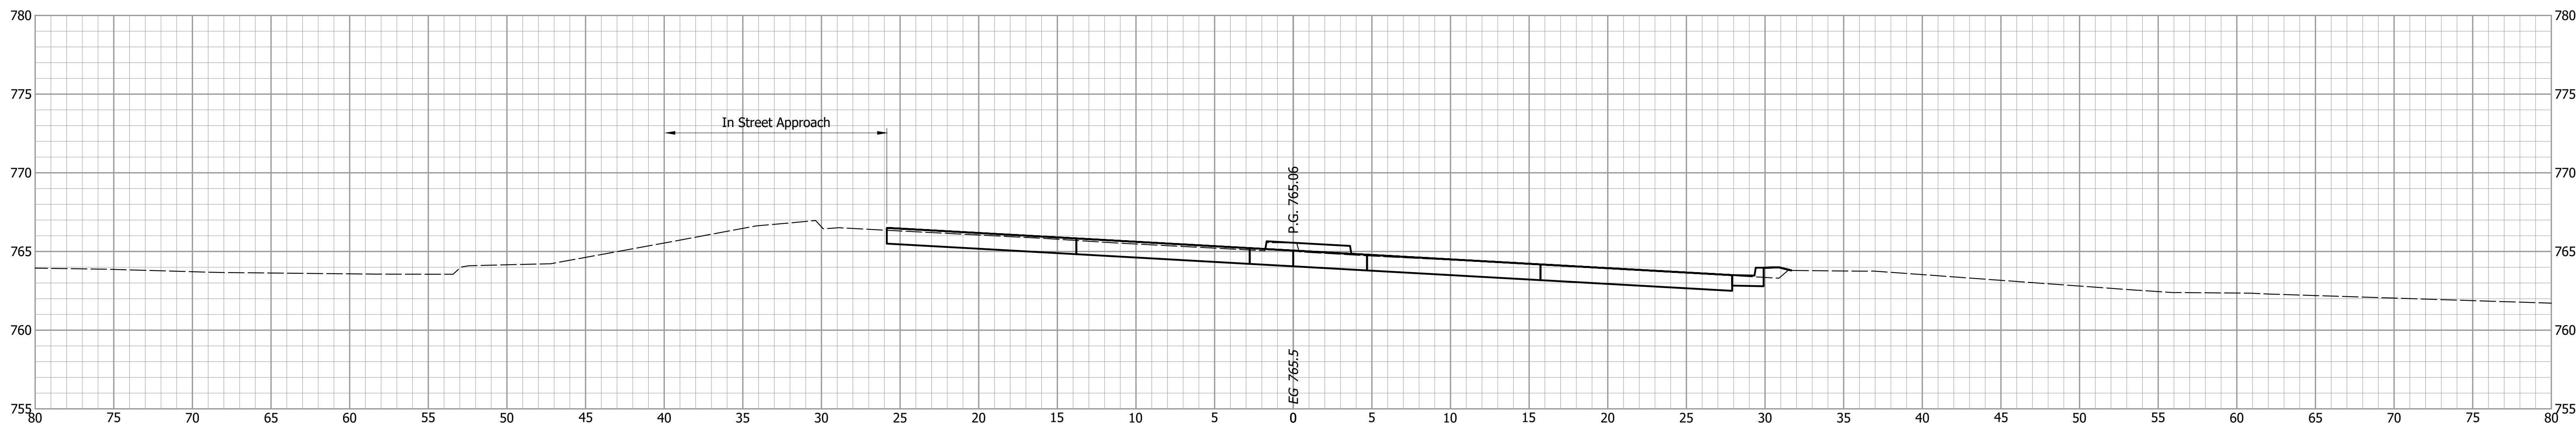HORIZONTAL SCALE 1" = 5'	BRIDGE FILE ALLEN 358
VERTICAL SCALE 1" = 5'	DESIGNATION 1902834
SURVEY BOOK ----	SHEETS 46 of 63
CONTRACT B-42844	PROJECT 1902834


45+25



45+00

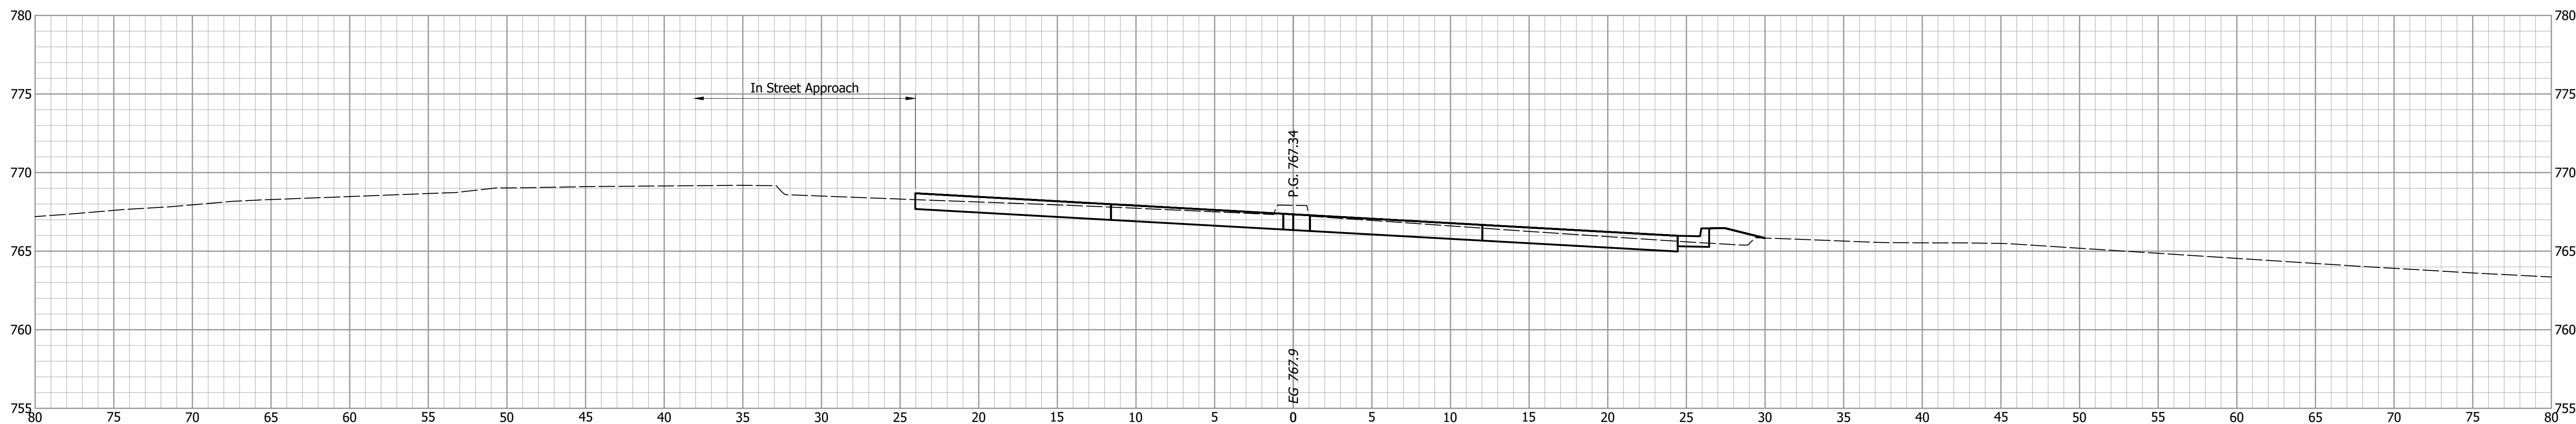

44+75

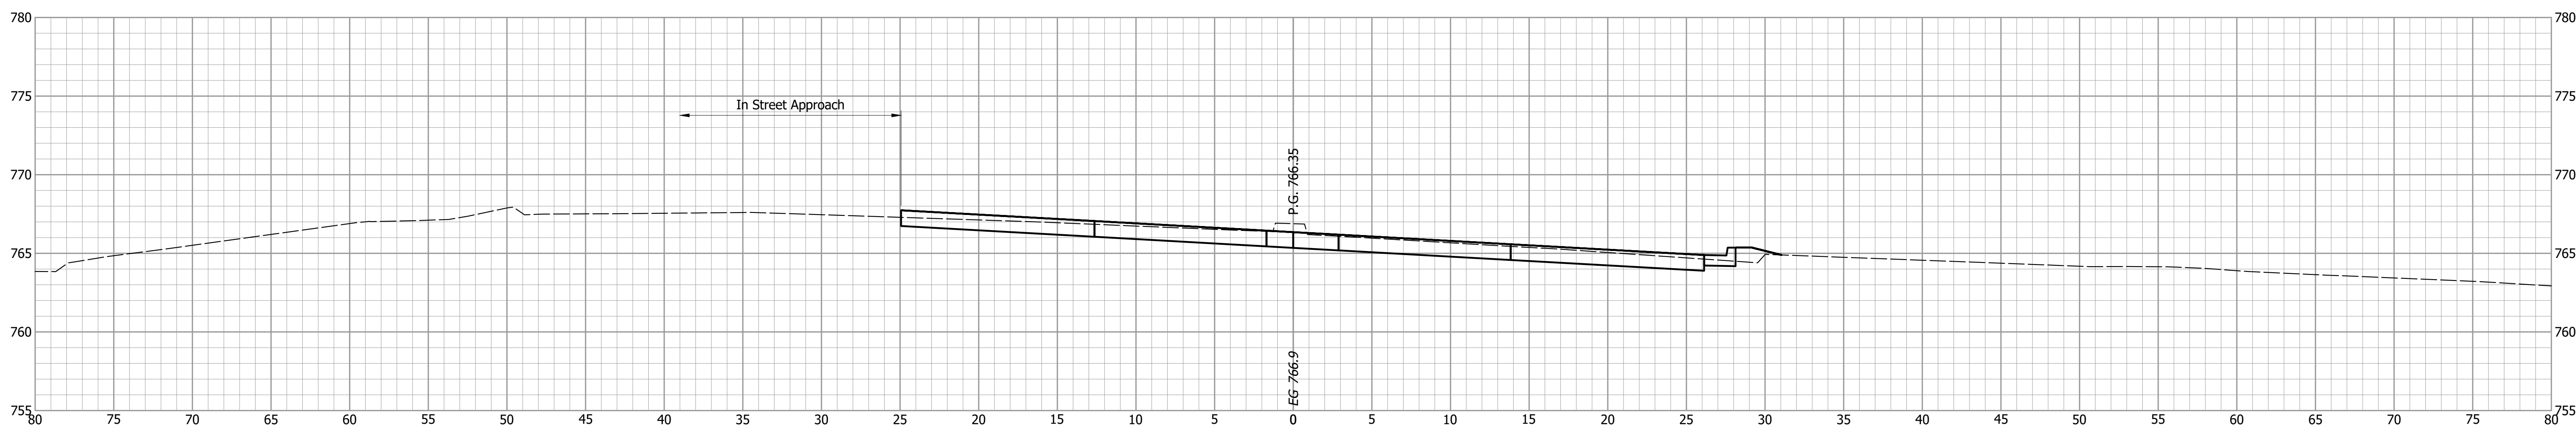


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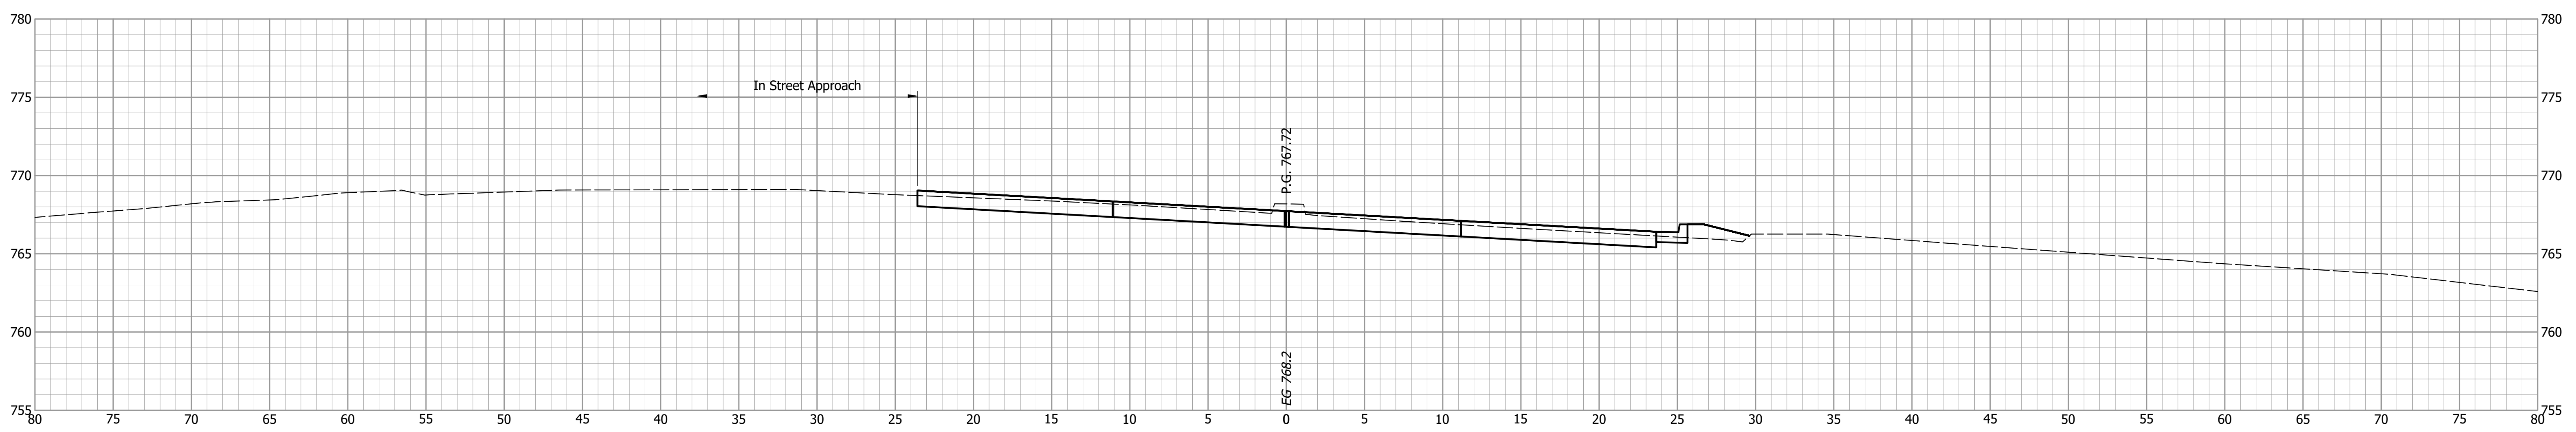
INDIANA
 DEPARTMENT OF TRANSPORTATION
 CROSS SECTIONS
 LINE "B" - BLUFFTON ROAD

HORIZONTAL SCALE 1" = 5'	BRIDGE FILE ALLEN 358
VERTICAL SCALE 1" = 5'	DESIGNATION 1902834
SURVEY BOOK ----	SHEETS 47 of 63
CONTRACT B-42844	PROJECT 1902834

45+75



45+50

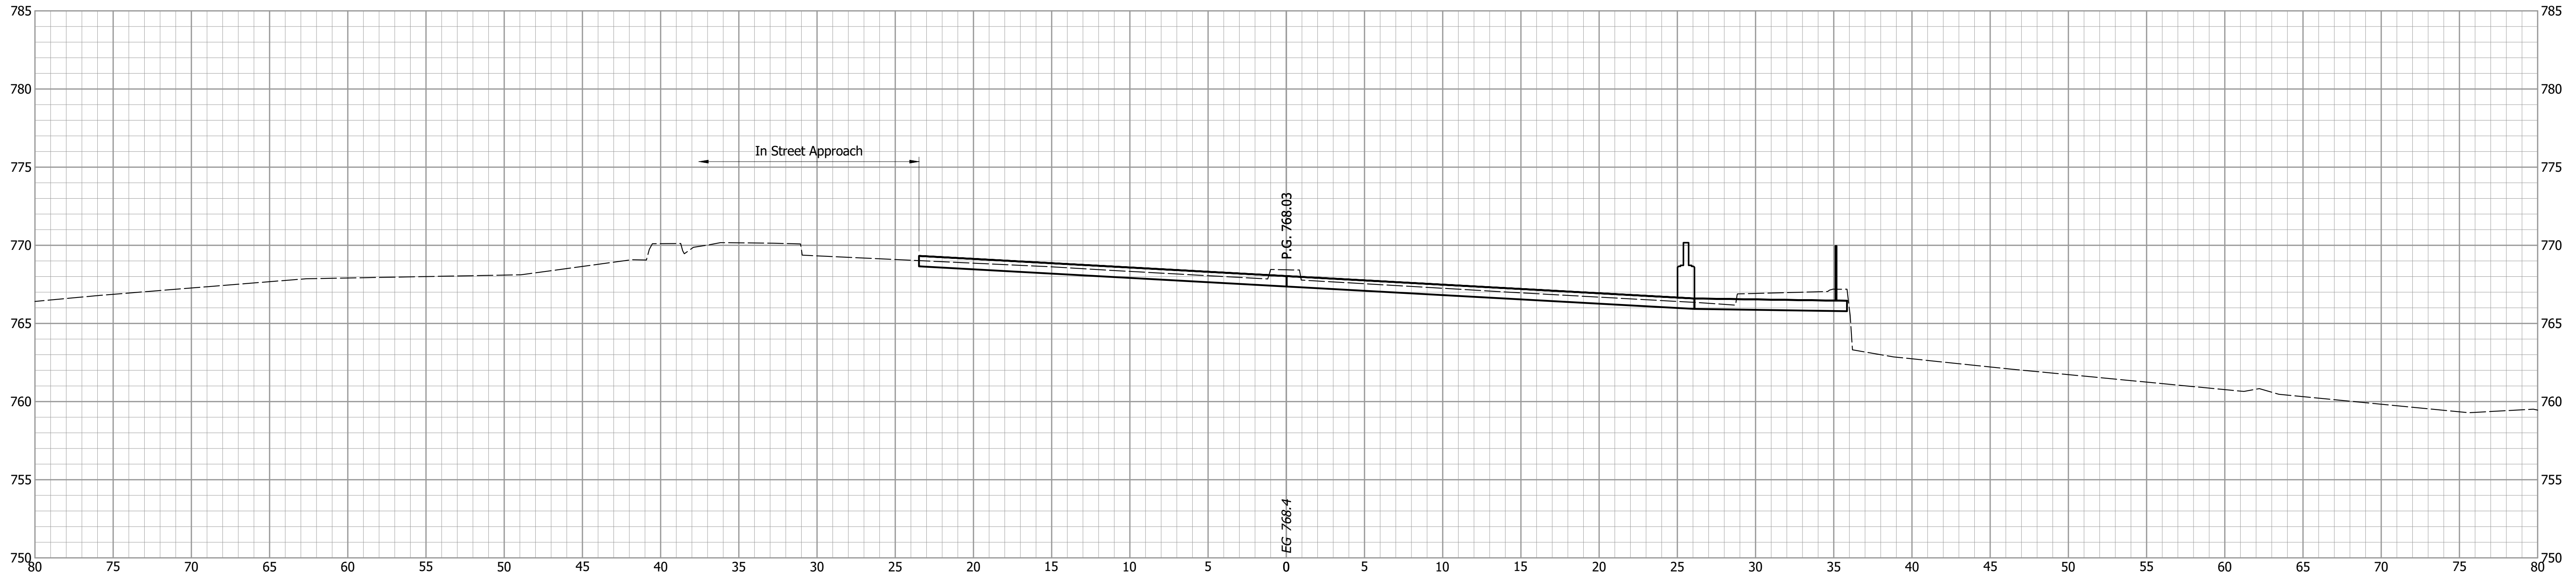

NOT FOR
CONSTRUCTION


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CHECKED: KAM	CHECKED: BMA

INDIANA
DEPARTMENT OF TRANSPORTATION


CROSS SECTIONS
LINE "B" - BLUFFTON ROAD

HORIZONTAL SCALE 1" = 5'	BRIDGE FILE ALLEN 358
VERTICAL SCALE 1" = 5'	DESIGNATION 1902834
SURVEY BOOK ---	SHEETS 48 of 63
CONTRACT B-42844	PROJECT 1902834

46+25

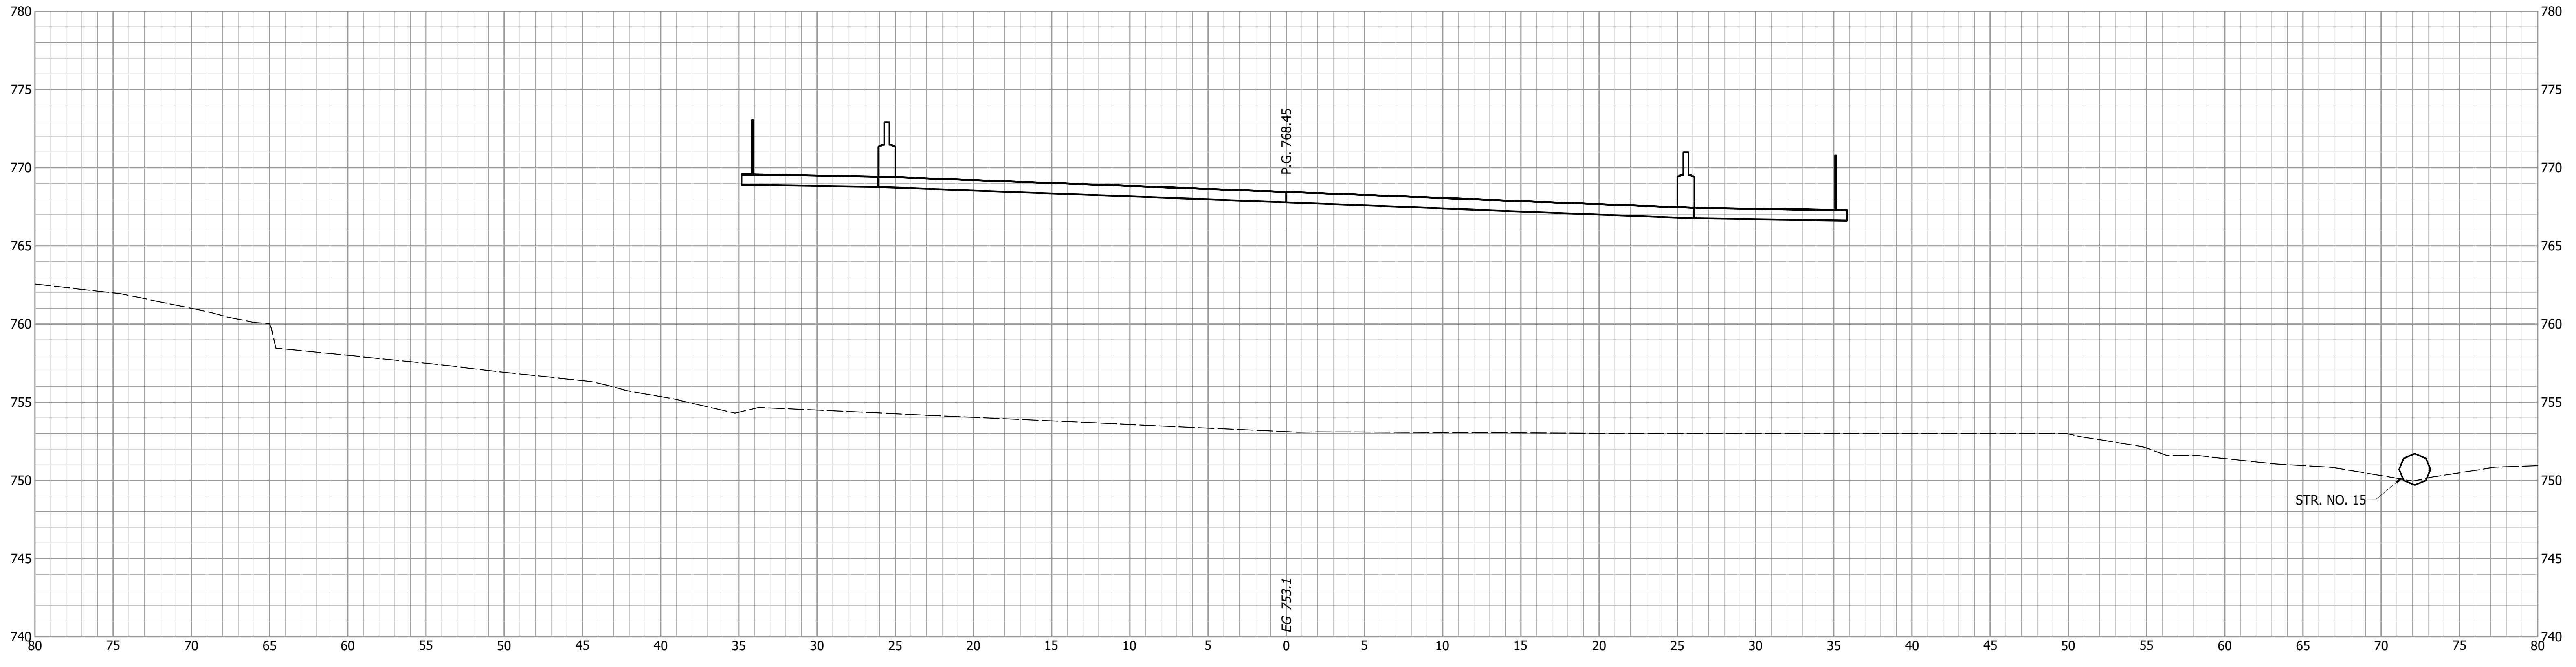

46+00

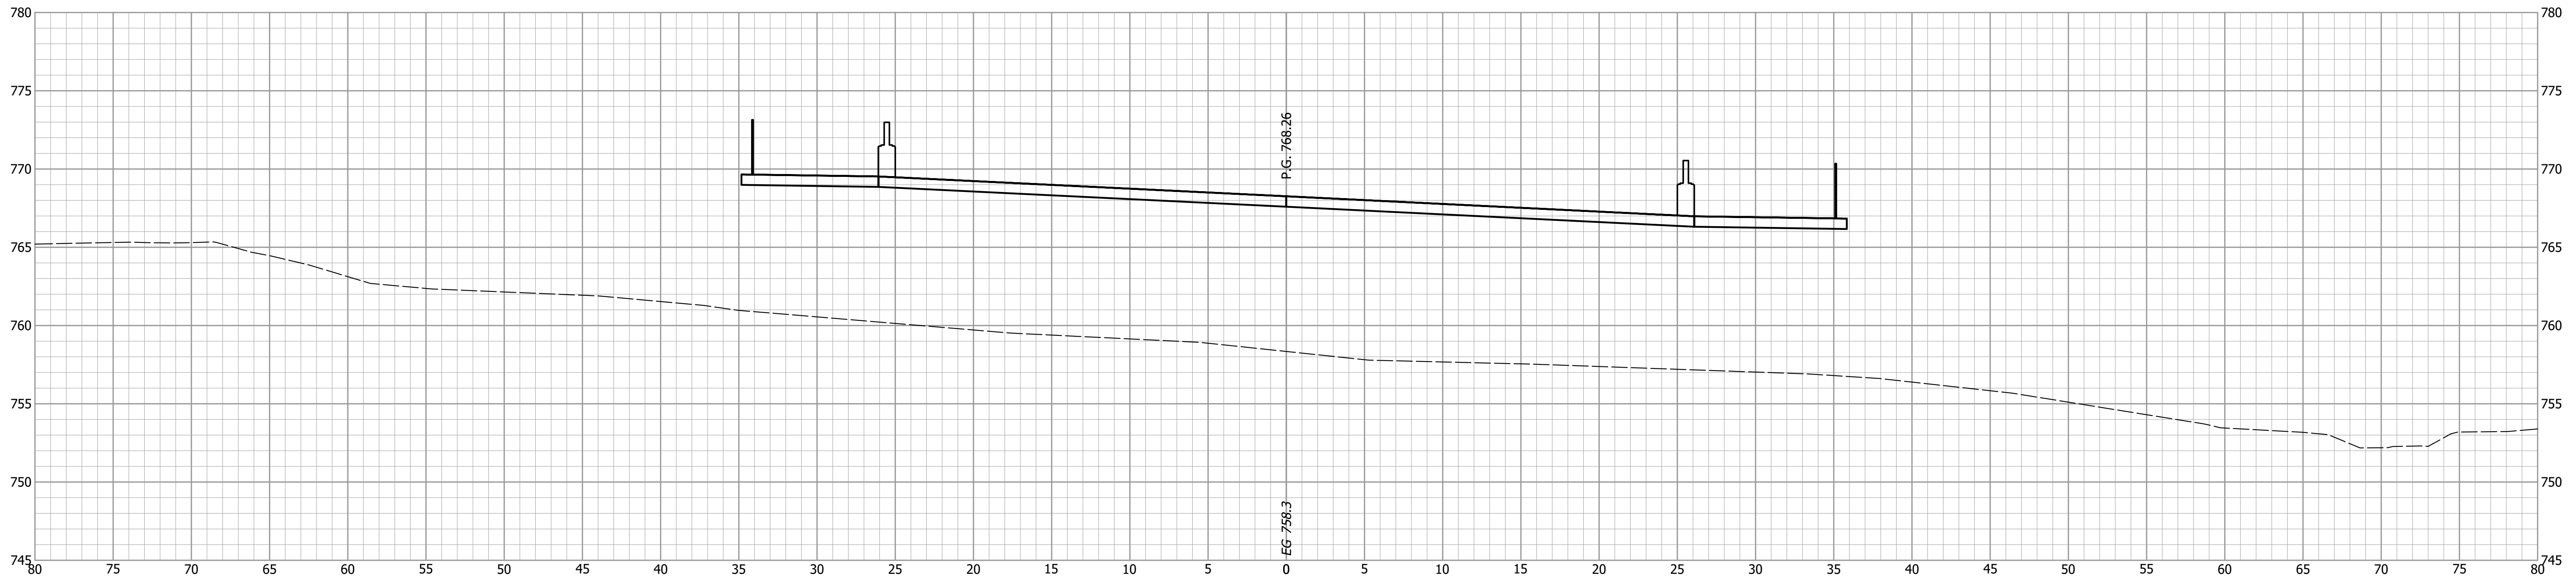

NOT FOR
CONSTRUCTION


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INDIANA
DEPARTMENT OF TRANSPORTATION


CROSS SECTIONS
LINE "B" - BLUFFTON ROAD

HORIZONTAL SCALE 1" = 5'	BRIDGE FILE ALLEN 358
VERTICAL SCALE 1" = 5'	DESIGNATION 1902834
SURVEY BOOK ----	SHEETS 49 of 63
CONTRACT B-42844	PROJECT 1902834

46+75

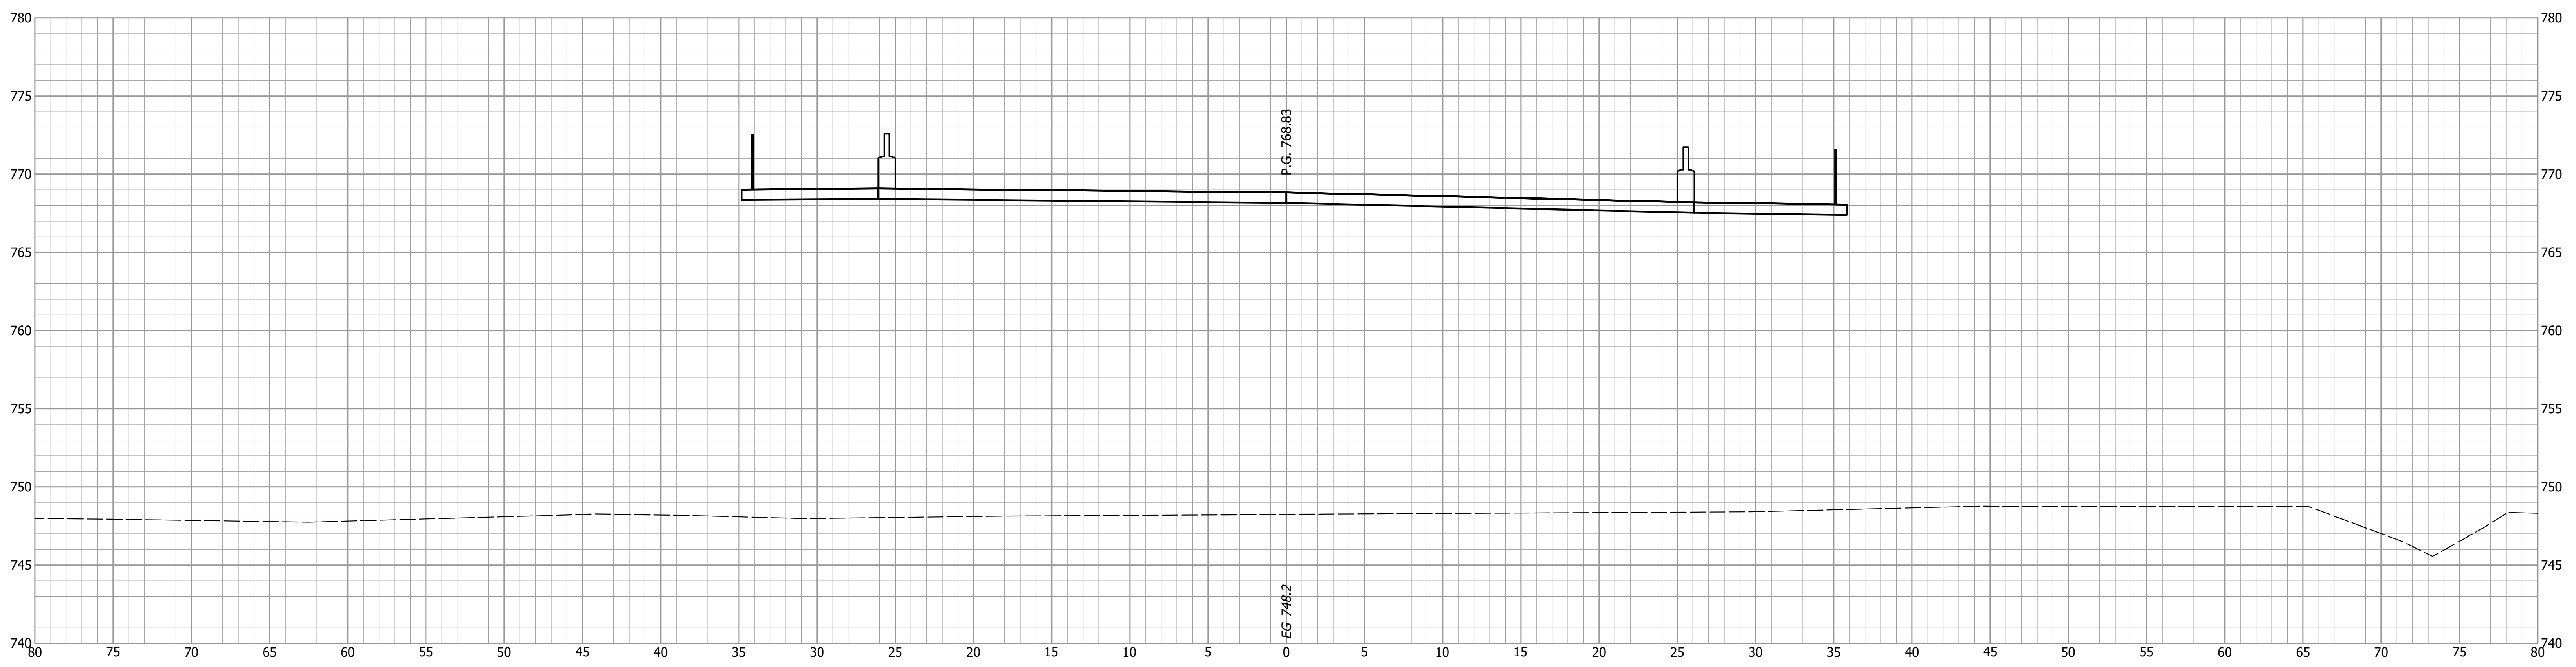

46+50

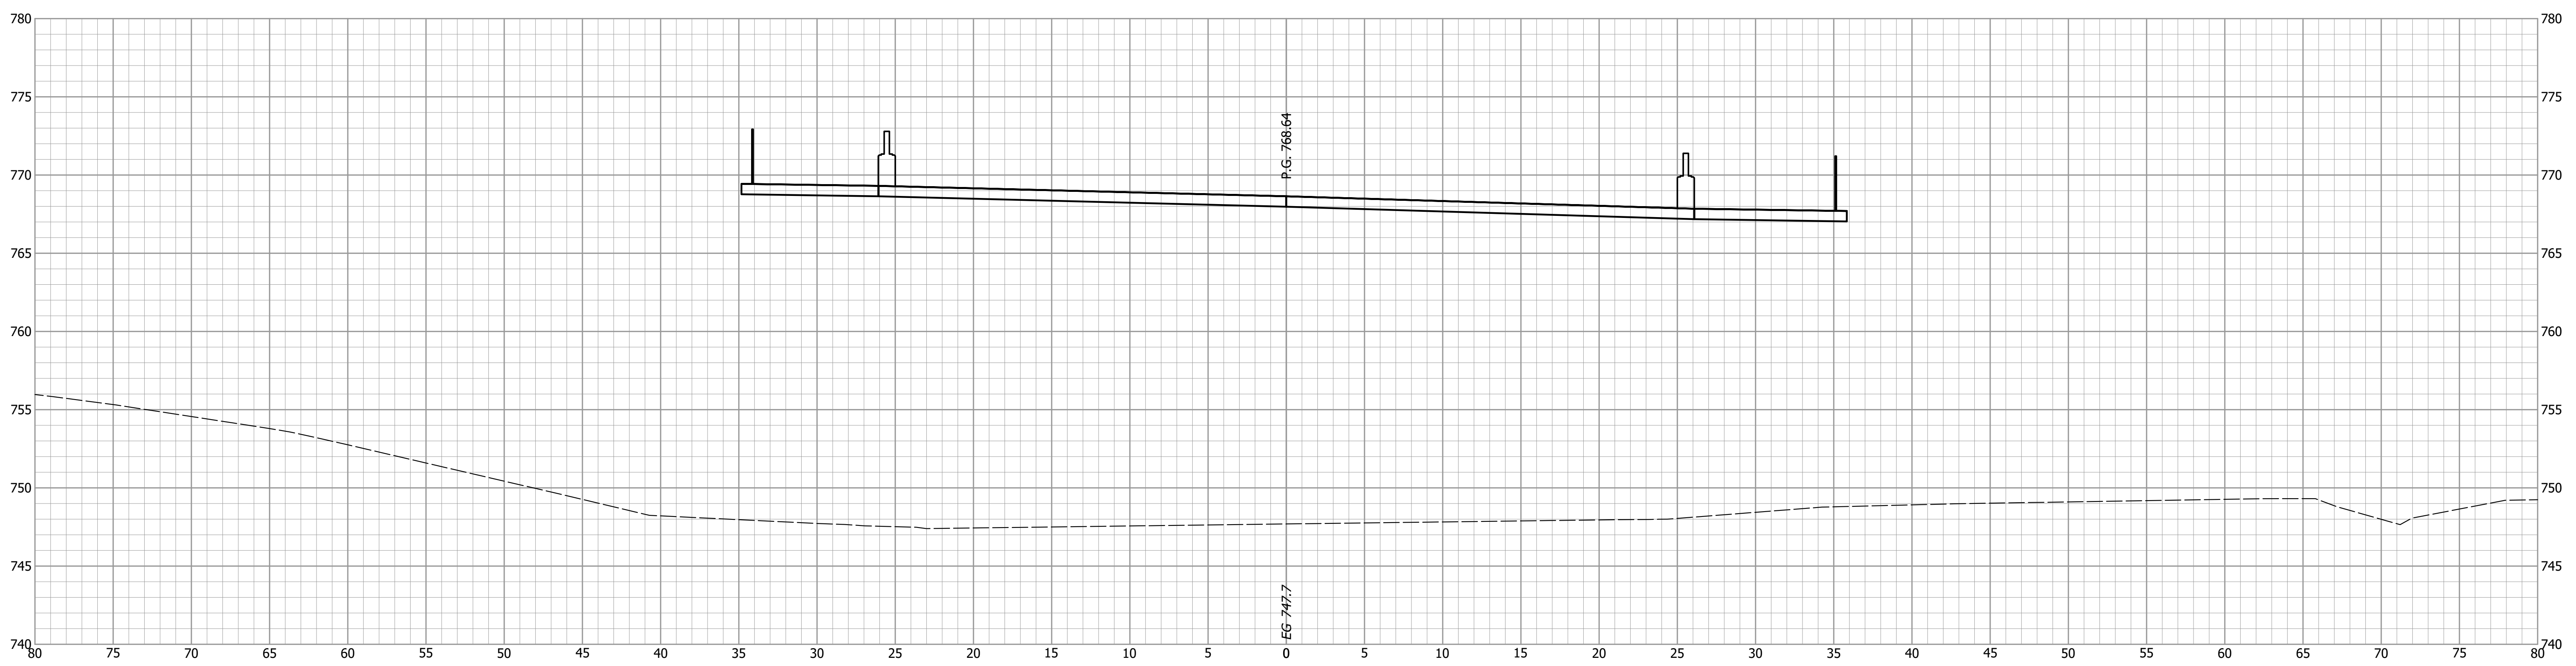


NOT FOR
CONSTRUCTION

DESIGNED: BMA DRAWN: CNC
 CHECKED: KAM CHECKED: BMA

INDIANA
 DEPARTMENT OF TRANSPORTATION
 CROSS SECTIONS
 LINE "B" - BLUFFTON ROAD

HORIZONTAL SCALE 1" = 5'	BRIDGE FILE ALLEN 358
VERTICAL SCALE 1" = 5'	DESIGNATION 1902834
SURVEY BOOK ----	SHEETS 50 of 63
CONTRACT B-42844	PROJECT 1902834

47+00

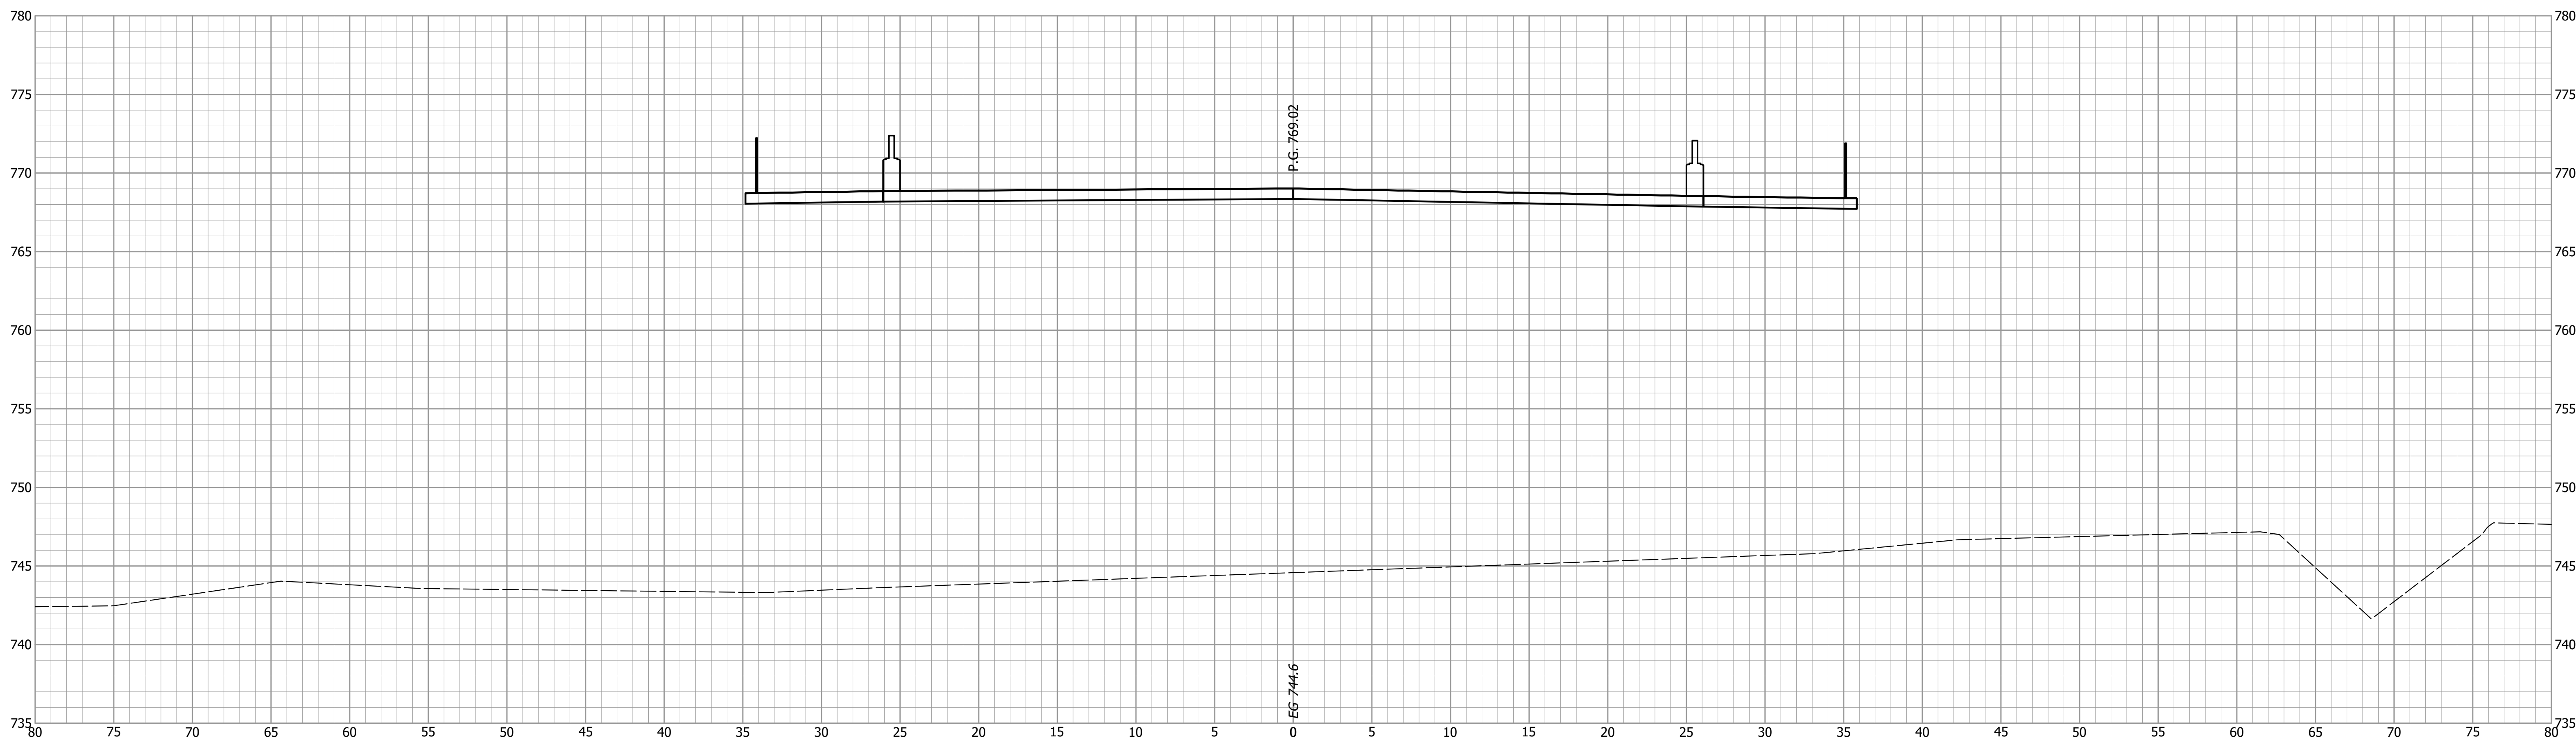

NOT FOR
CONSTRUCTION


DESIGNED: BMA	DRAWN: CNC
CHECKED: KAM	CHECKED: BMA

INDIANA
DEPARTMENT OF TRANSPORTATION

CROSS SECTIONS
LINE "B" - BLUFFTON ROAD

HORIZONTAL SCALE 1" = 5'	BRIDGE FILE ALLEN 358
VERTICAL SCALE 1" = 5'	DESIGNATION 1902834
SURVEY BOOK ----	SHEETS 51 of 63
CONTRACT B-42844	PROJECT 1902834

47+25

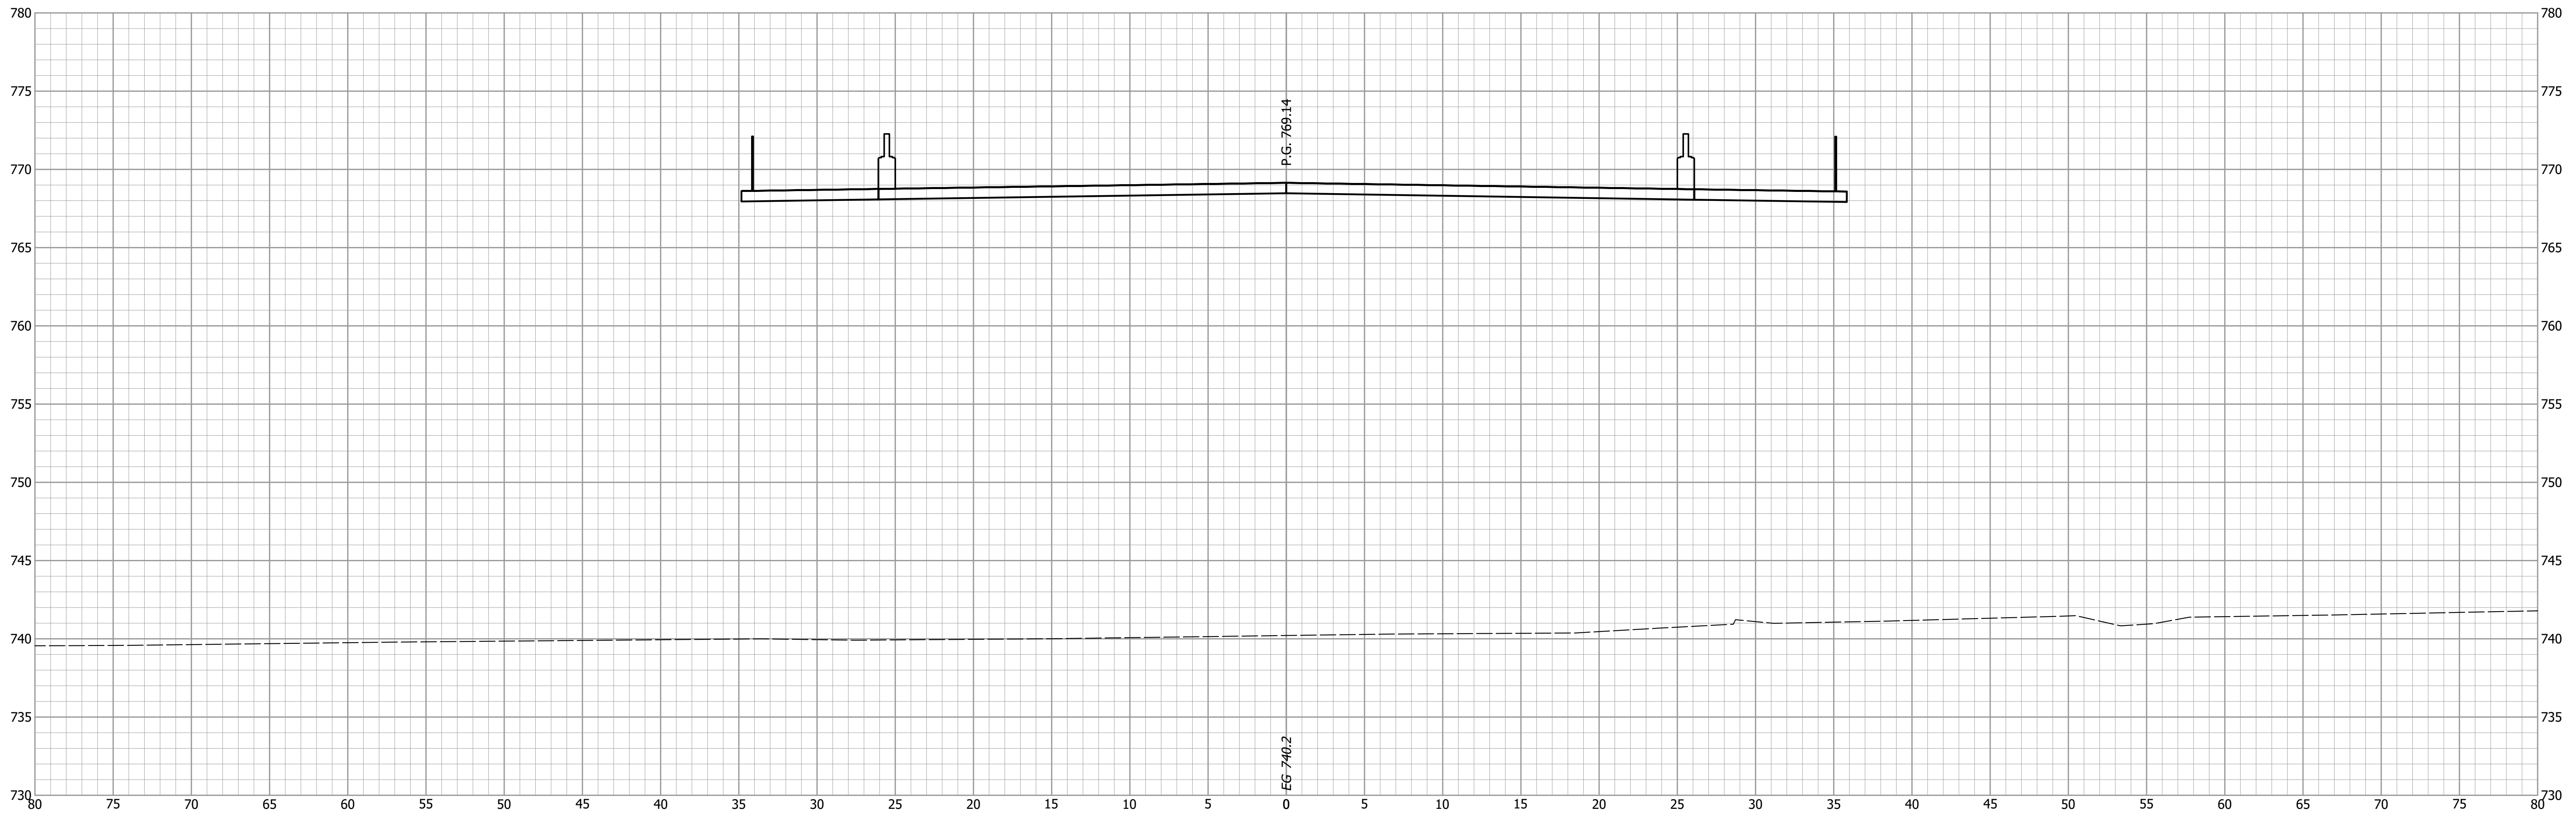

NOT FOR
CONSTRUCTION


DESIGNED: BMA	DRAWN: CNC
CHECKED: KAM	CHECKED: BMA

INDIANA
DEPARTMENT OF TRANSPORTATION

CROSS SECTIONS
LINE "B" - BLUFFTON ROAD

HORIZONTAL SCALE 1" = 5'	BRIDGE FILE ALLEN 358
VERTICAL SCALE 1" = 5'	DESIGNATION 1902834
SURVEY BOOK ----	SHEETS 52 of 63
CONTRACT B-42844	PROJECT 1902834

47+50

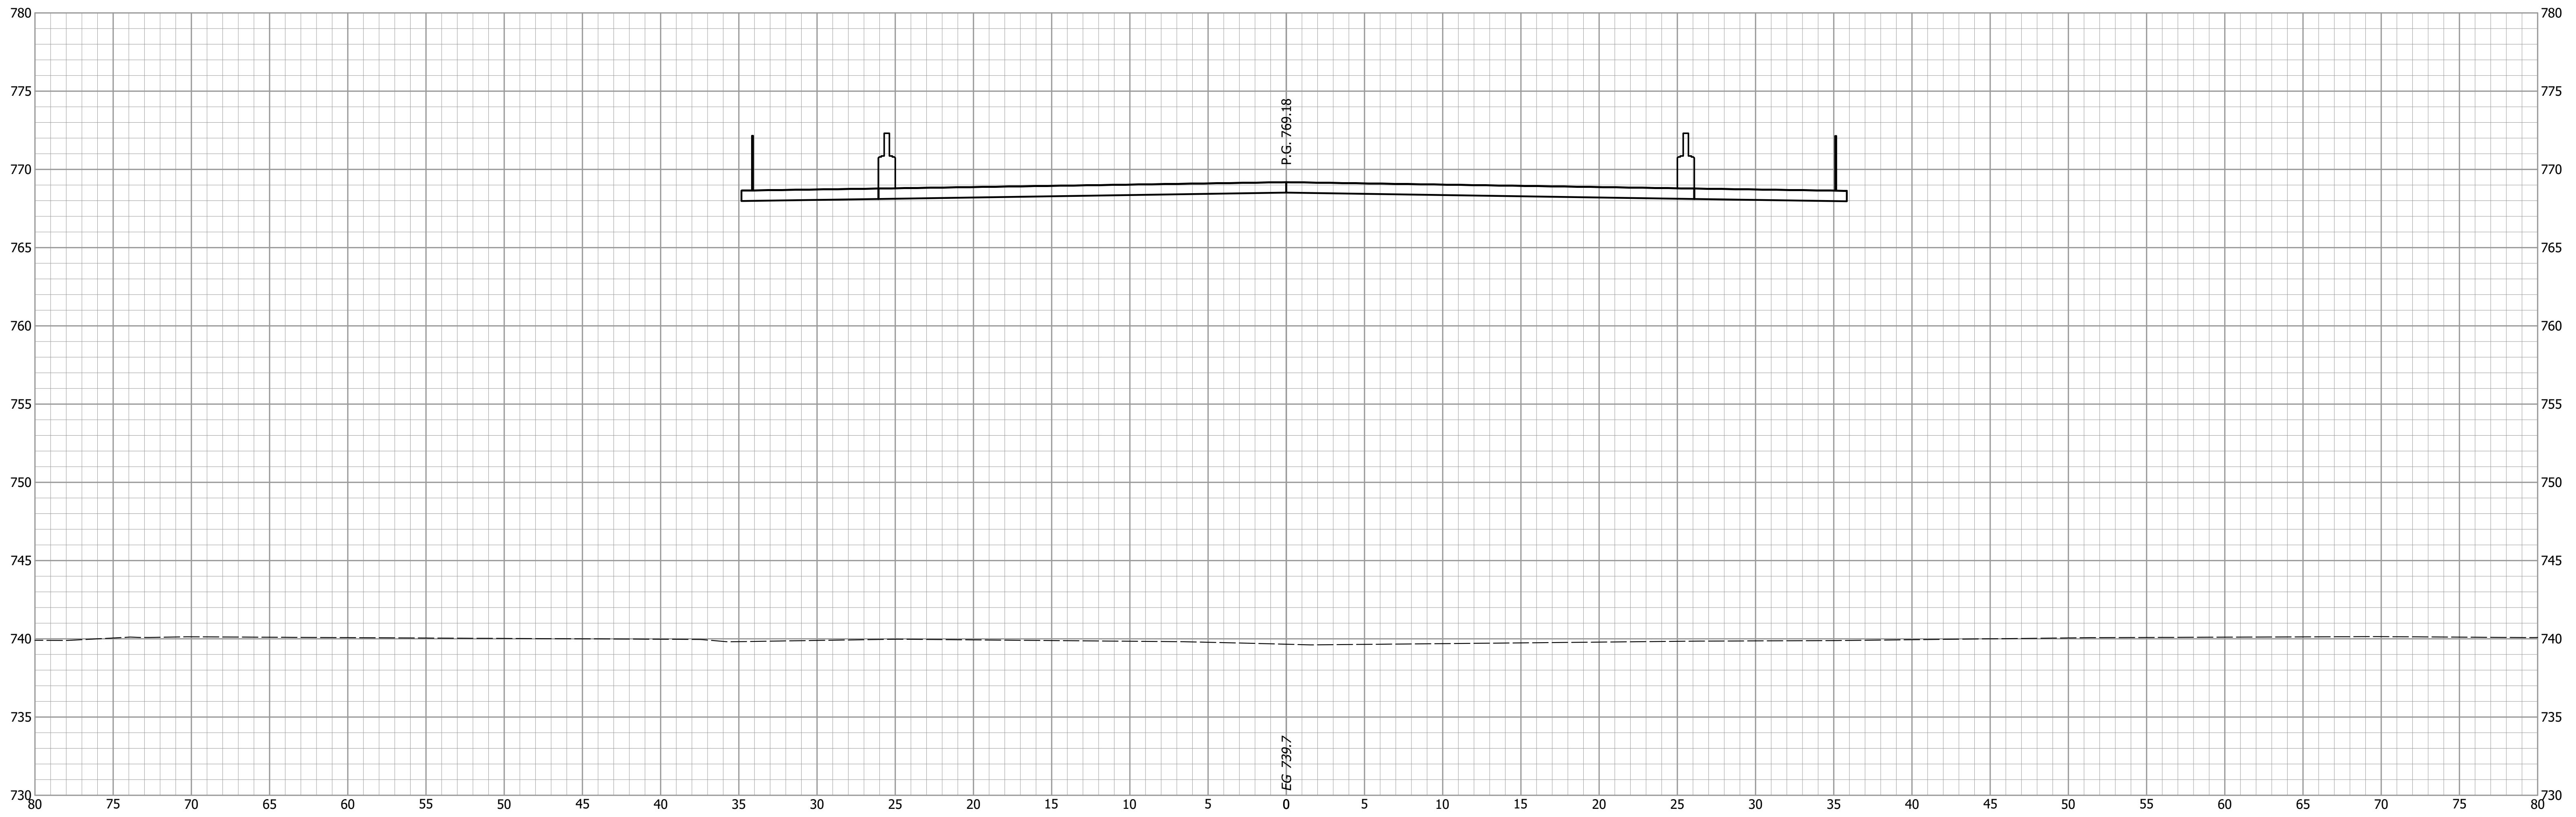

P.G. 769.18

EG 739.7

**NOT FOR
CONSTRUCTION**


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CHECKED: KAM	CHECKED: BMA

INDIANA
DEPARTMENT OF TRANSPORTATION

**CROSS SECTIONS
LINE "B" - BLUFFTON ROAD**

HORIZONTAL SCALE 1" = 5'	BRIDGE FILE ALLEN 358
VERTICAL SCALE 1" = 5'	DESIGNATION 1902834
SURVEY BOOK ----	SHEETS 53 of 63
CONTRACT B-42844	PROJECT 1902834

47+75

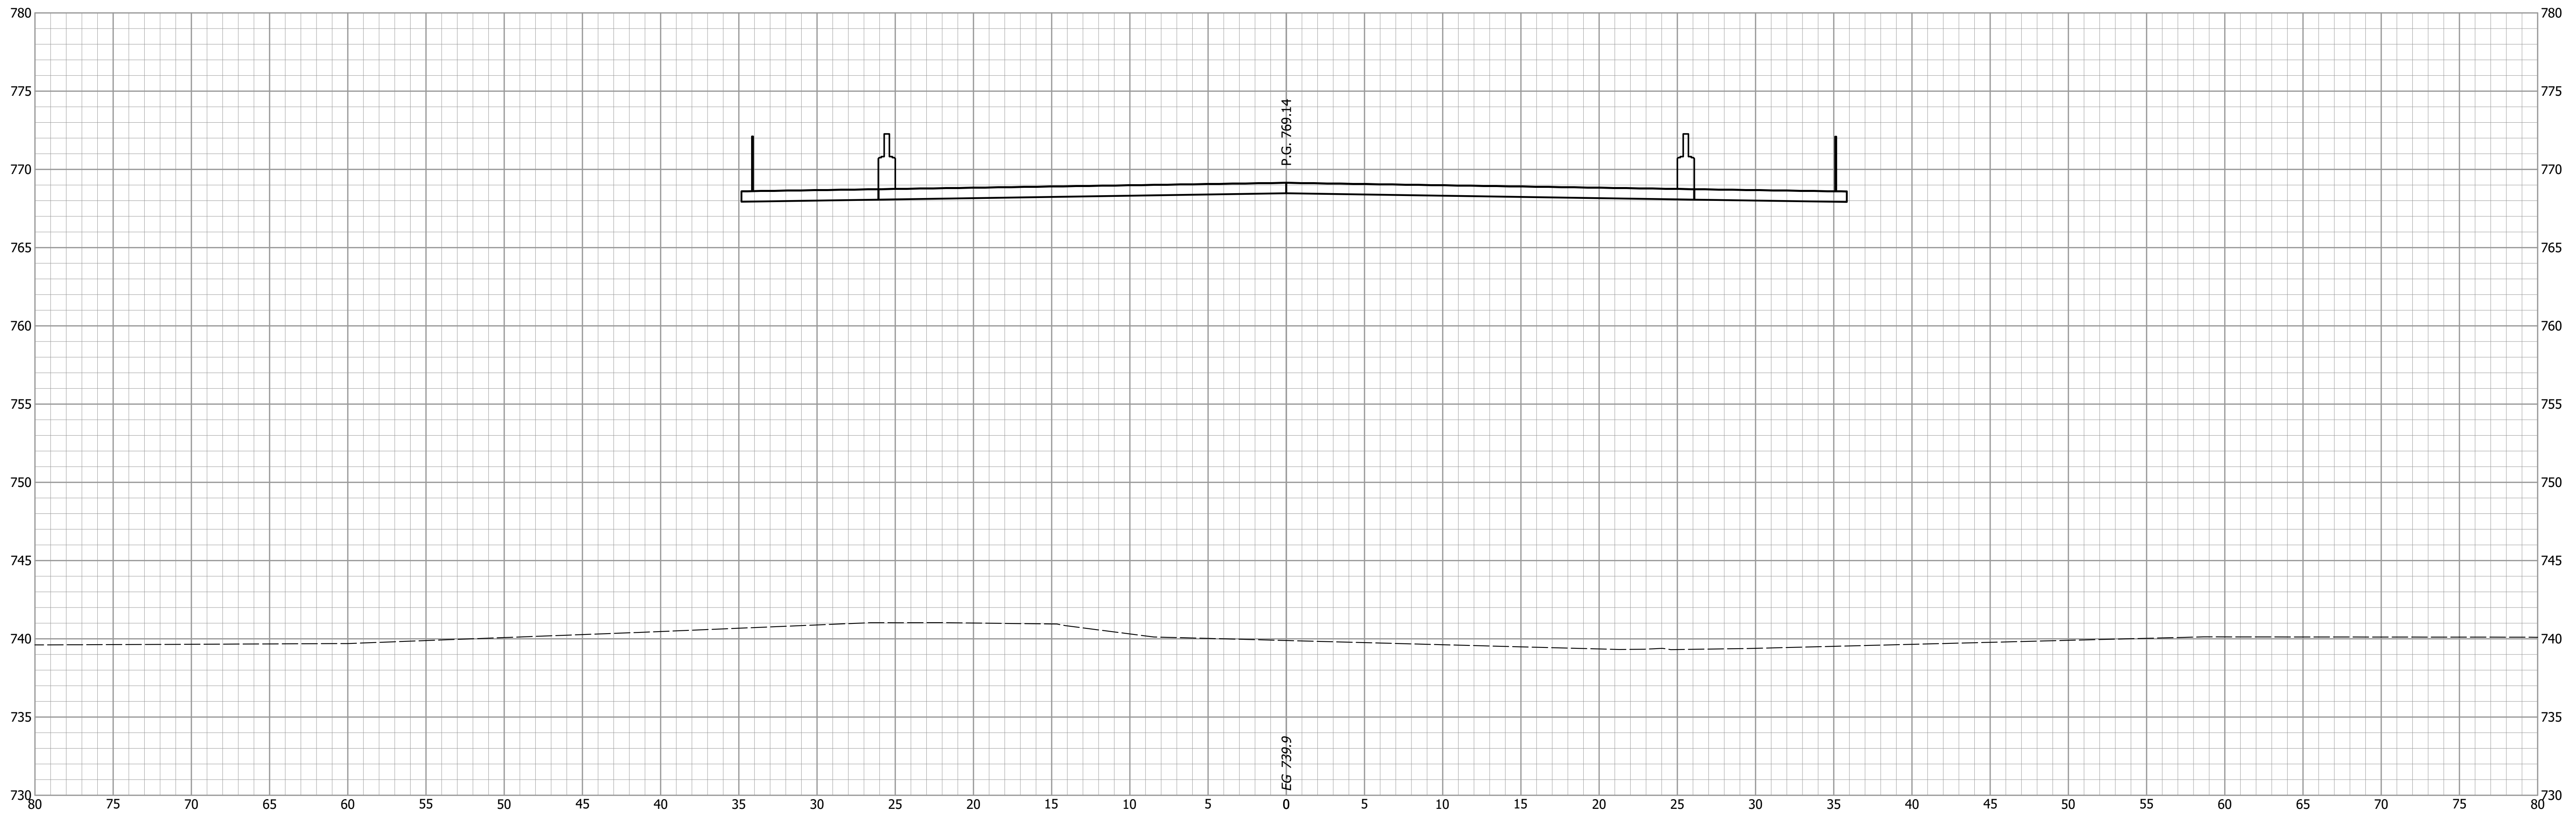

NOT FOR
CONSTRUCTION


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CHECKED: KAM	CHECKED: BMA

INDIANA
DEPARTMENT OF TRANSPORTATION

CROSS SECTIONS
LINE "B" - BLUFFTON ROAD

HORIZONTAL SCALE 1" = 5'	BRIDGE FILE ALLEN 358
VERTICAL SCALE 1" = 5'	DESIGNATION 1902834
SURVEY BOOK ----	SHEETS 54 of 63
CONTRACT B-42844	PROJECT 1902834

48+00

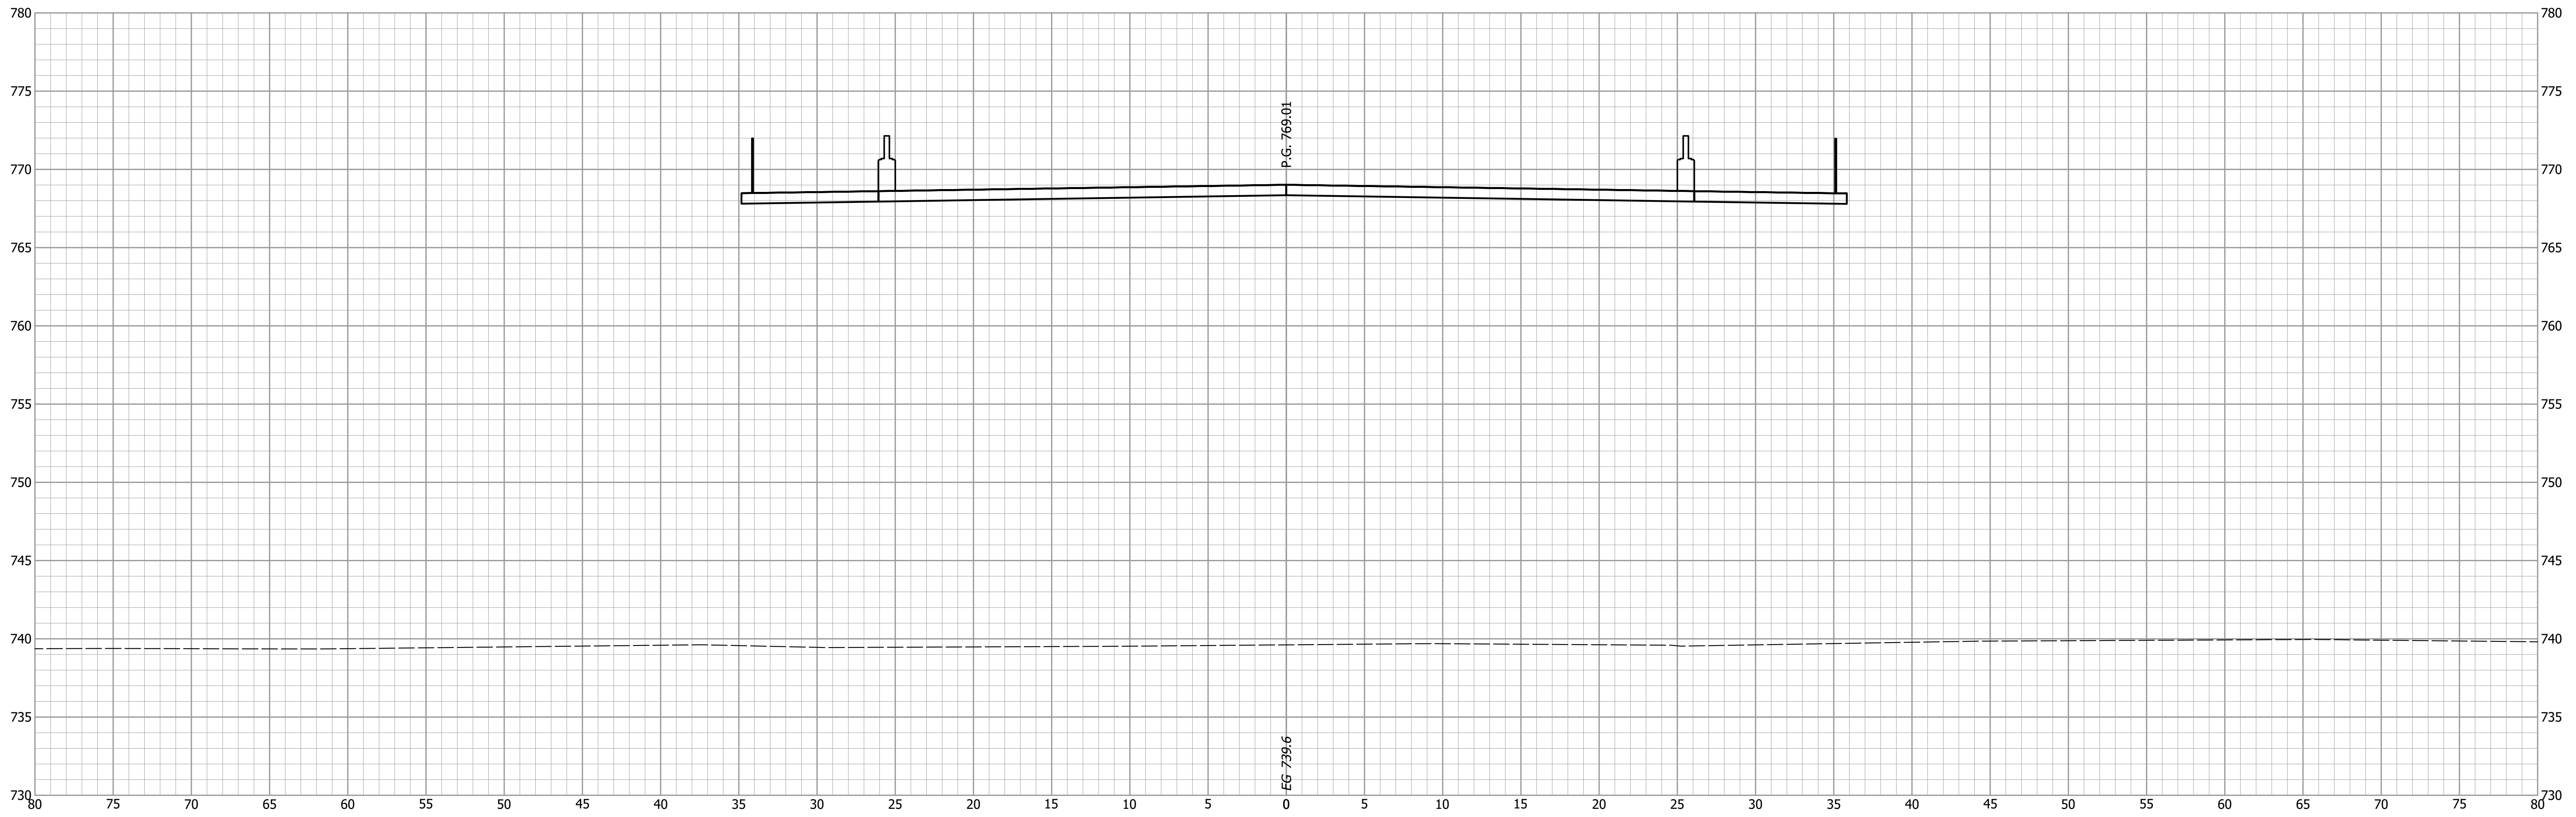

NOT FOR CONSTRUCTION


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CHECKED: KAM	CHECKED: BMA

INDIANA DEPARTMENT OF TRANSPORTATION

CROSS SECTIONS
LINE "B" - BLUFFTON ROAD

HORIZONTAL SCALE 1" = 5'	BRIDGE FILE ALLEN 358
VERTICAL SCALE 1" = 5'	DESIGNATION 1902834
SURVEY BOOK ----	SHEETS 55 of 63
CONTRACT B-42844	PROJECT 1902834

48+25

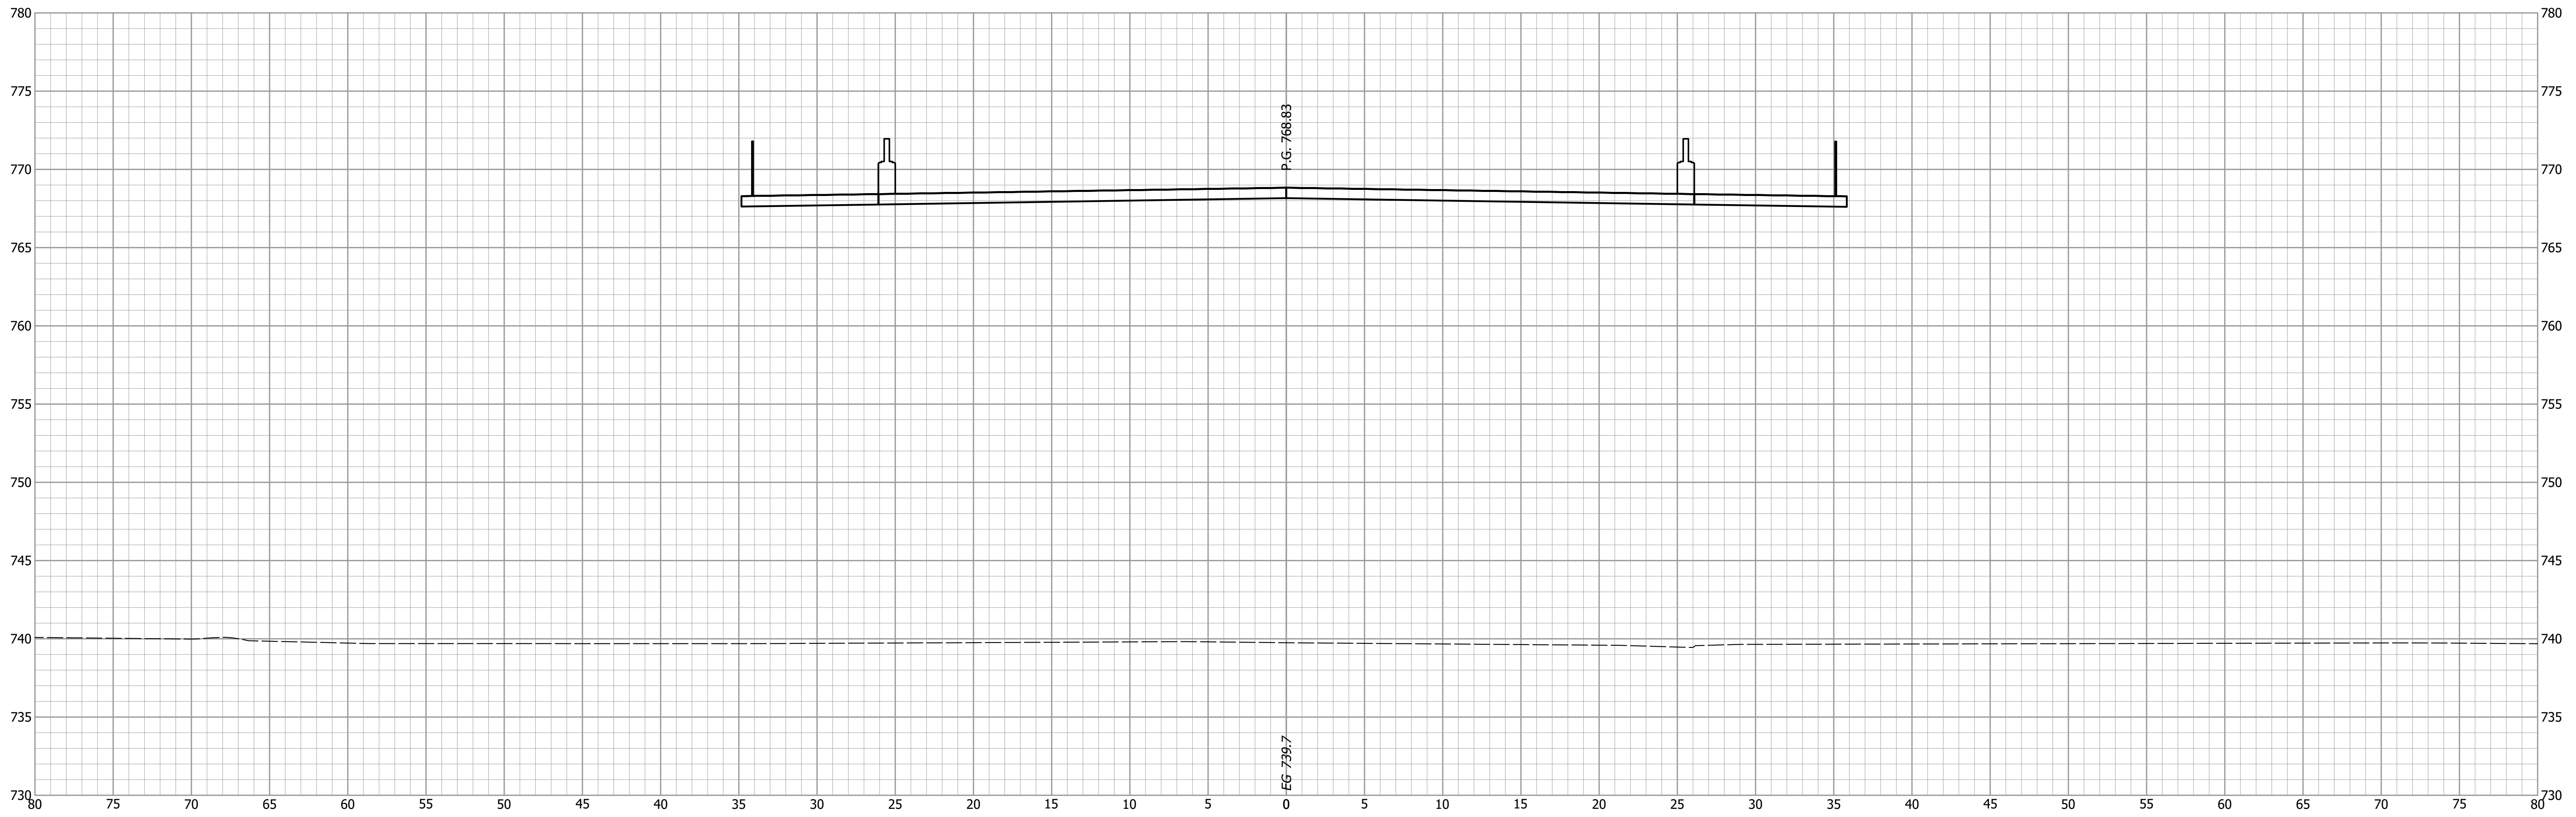

NOT FOR
CONSTRUCTION


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CHECKED: KAM	CHECKED: BMA

INDIANA
DEPARTMENT OF TRANSPORTATION

CROSS SECTIONS
LINE "B" - BLUFFTON ROAD

HORIZONTAL SCALE 1" = 5'	BRIDGE FILE ALLEN 358
VERTICAL SCALE 1" = 5'	DESIGNATION 1902834
SURVEY BOOK ----	SHEETS 56 of 63
CONTRACT B-42844	PROJECT 1902834

48+50

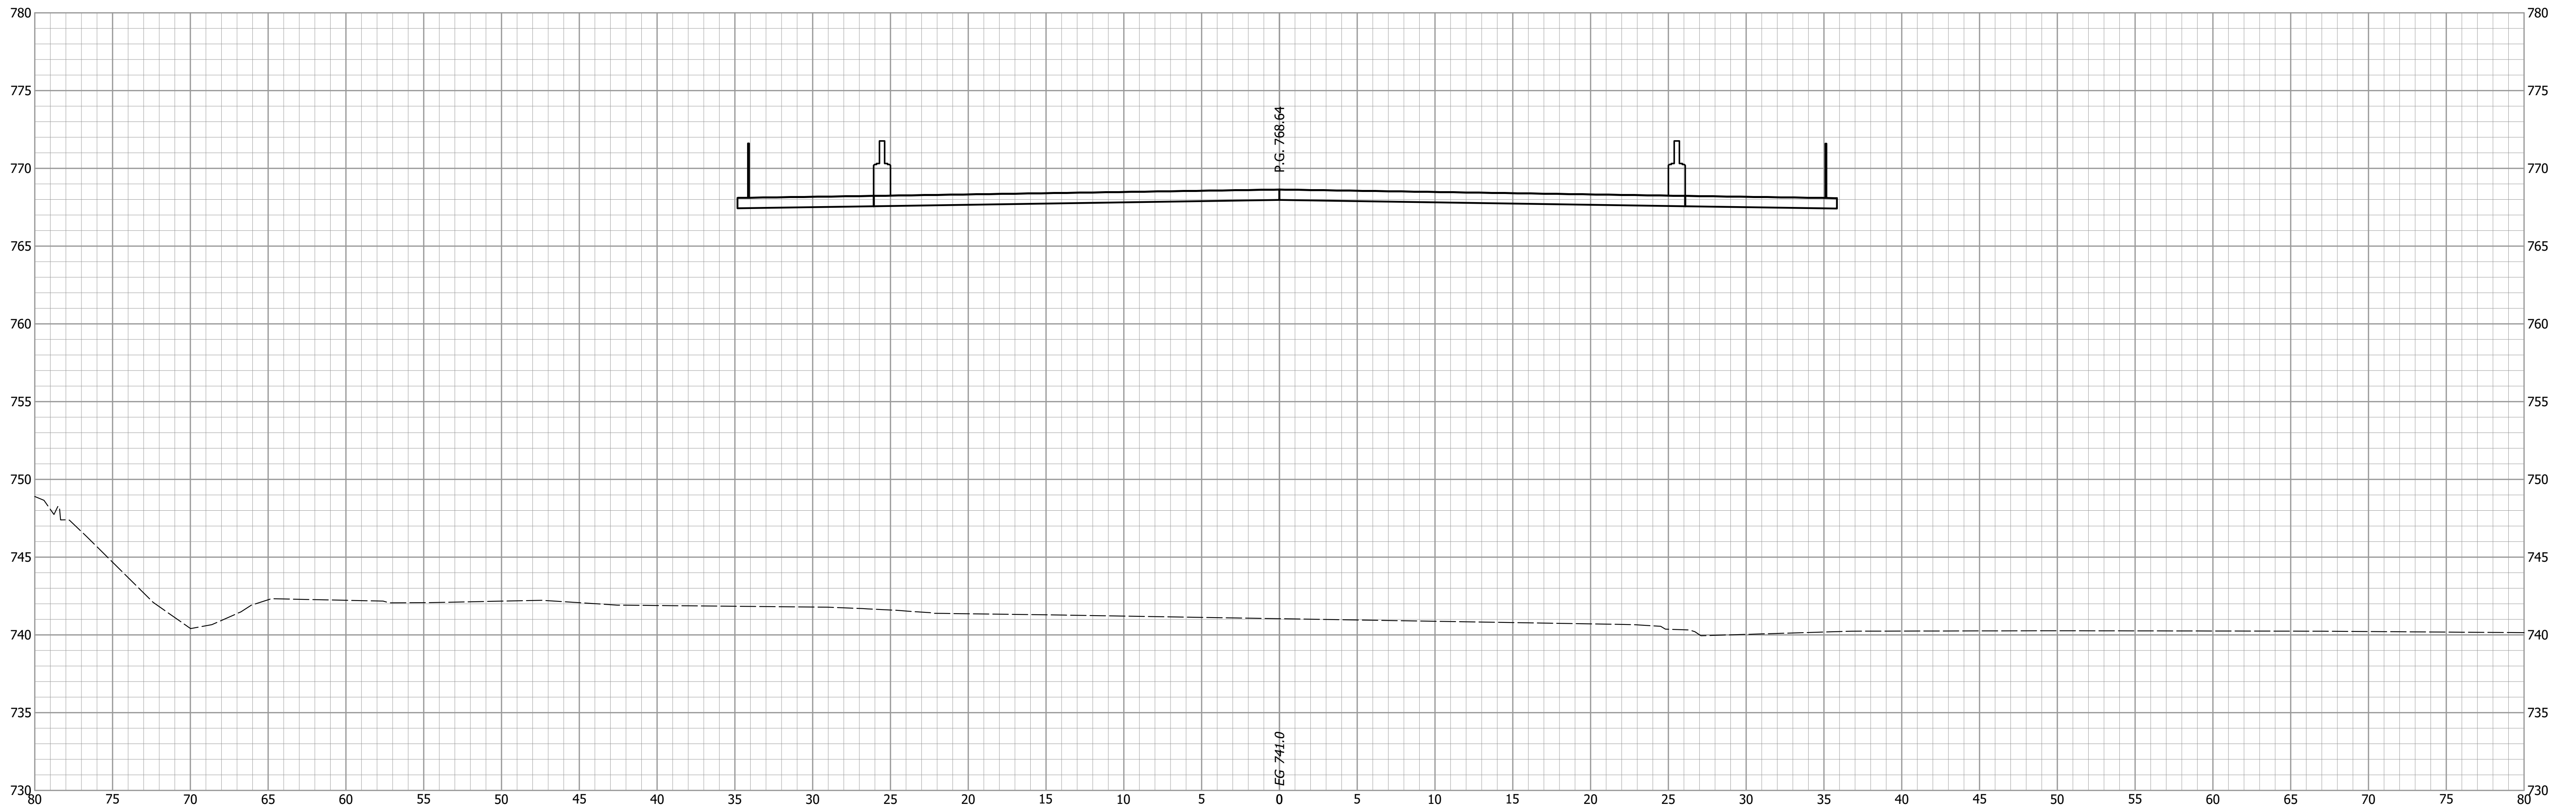

NOT FOR CONSTRUCTION


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CHECKED: KAM	CHECKED: BMA

INDIANA
DEPARTMENT OF TRANSPORTATION


CROSS SECTIONS
LINE "B" - BLUFFTON ROAD

HORIZONTAL SCALE 1" = 5'	BRIDGE FILE ALLEN 358
VERTICAL SCALE 1" = 5'	DESIGNATION 1902834
SURVEY BOOK ----	SHEETS 57 of 63
CONTRACT B-42844	PROJECT 1902834

49+00

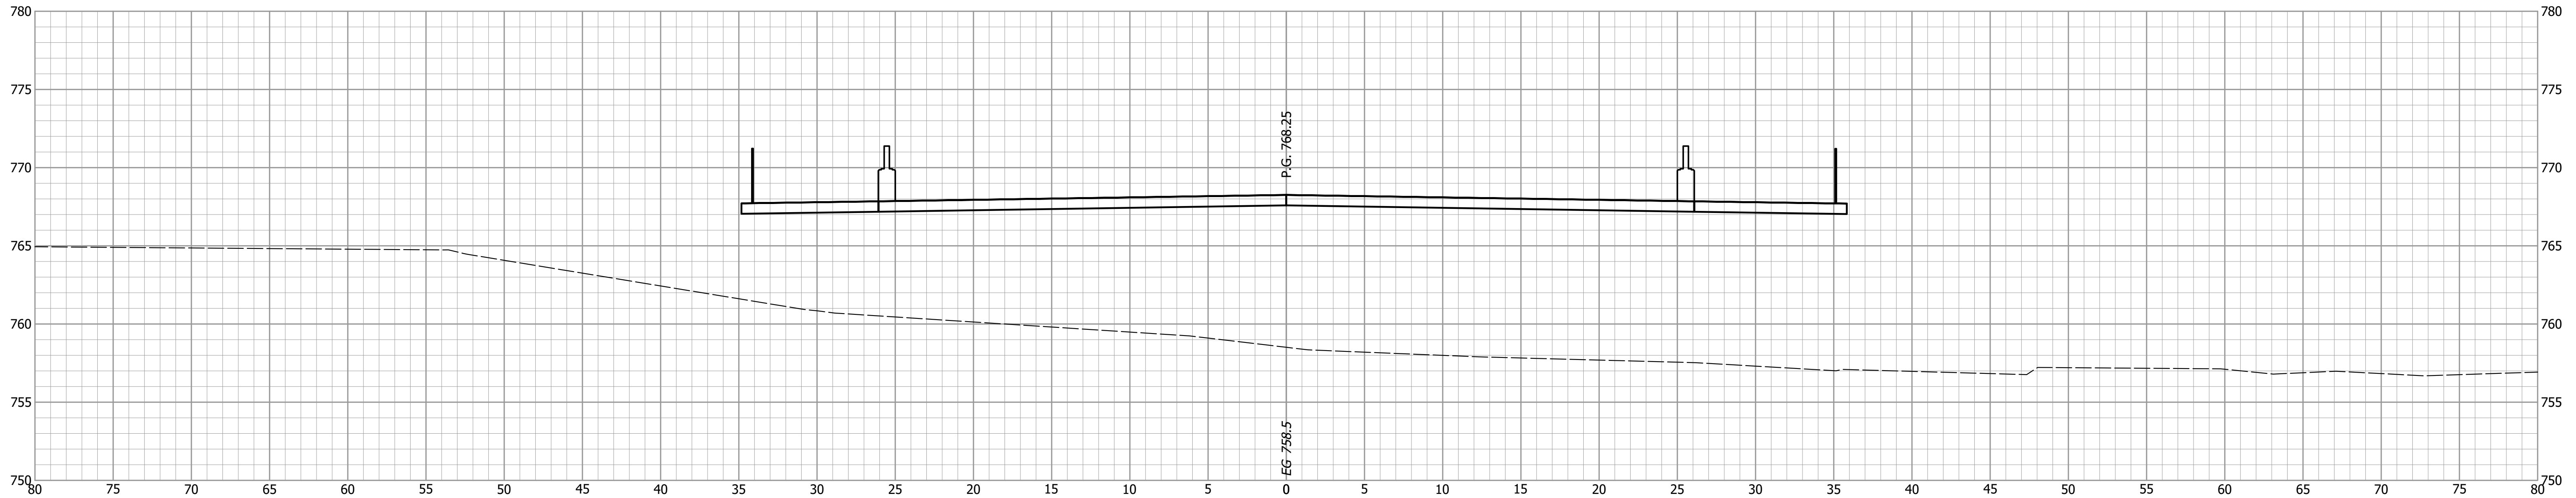

48+75

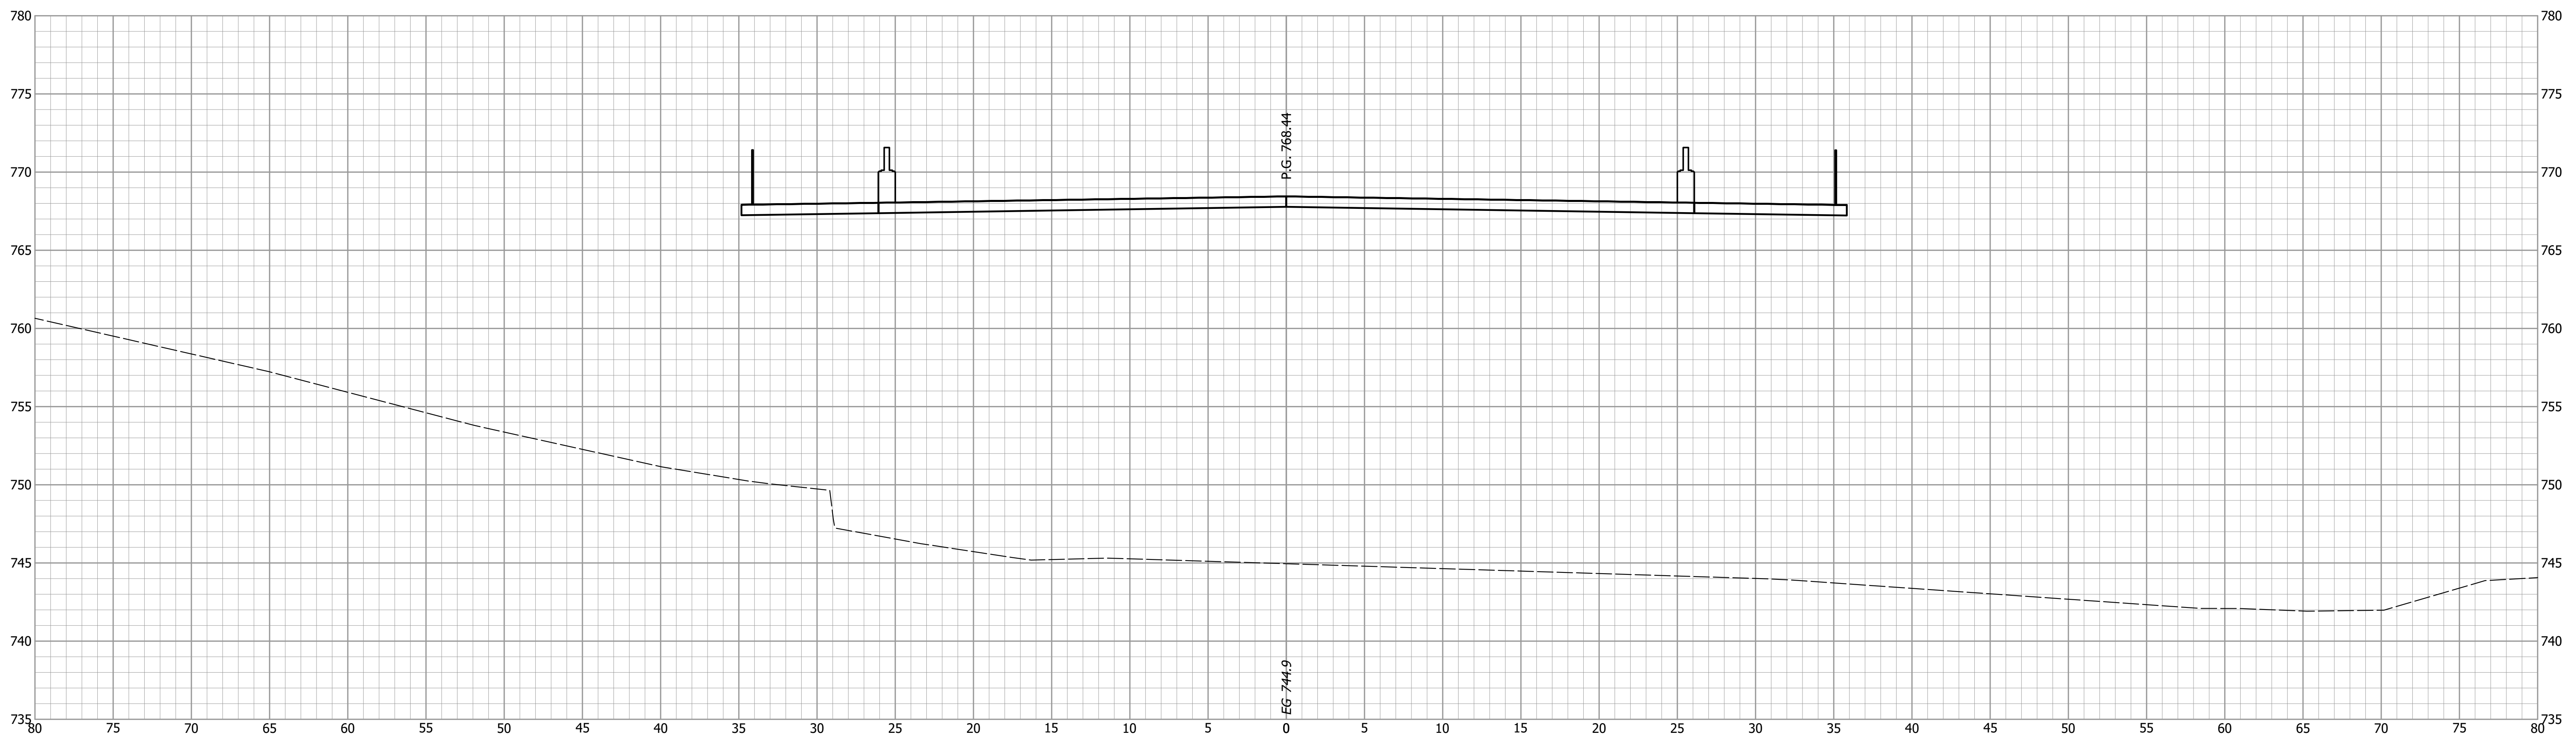

NOT FOR
CONSTRUCTION

DESIGNED: BMA	DRAWN: CNC
CHECKED: KAM	CHECKED: BMA


INDIANA
DEPARTMENT OF TRANSPORTATION

CROSS SECTIONS
LINE "B" - BLUFFTON ROAD

HORIZONTAL SCALE 1" = 5'	BRIDGE FILE ALLEN 358
VERTICAL SCALE 1" = 5'	DESIGNATION 1902834
SURVEY BOOK ----	SHEETS 58 of 63
CONTRACT B-42844	PROJECT 1902834

END PROJECT
 STA. 50+03.00 "B"

49+25






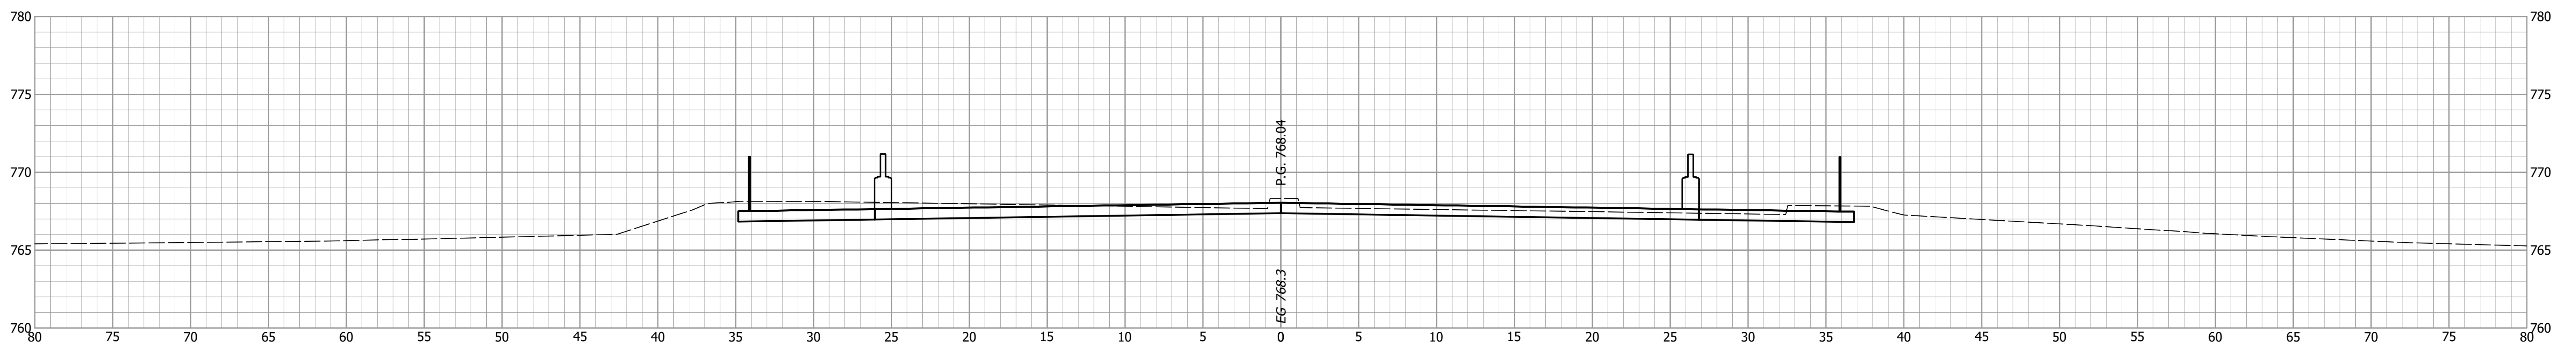


**NOT FOR
 CONSTRUCTION**

DESIGNED: BMA DRAWN: CNC
 CHECKED: KAM CHECKED: BMA

INDIANA
 DEPARTMENT OF TRANSPORTATION
 CROSS SECTIONS
 LINE "B" - BLUFFTON ROAD

HORIZONTAL SCALE 1" = 5'	BRIDGE FILE ALLEN 358
VERTICAL SCALE 1" = 5'	DESIGNATION 1902834
SURVEY BOOK ----	SHEETS 59 of 63
CONTRACT B-42844	PROJECT 1902834

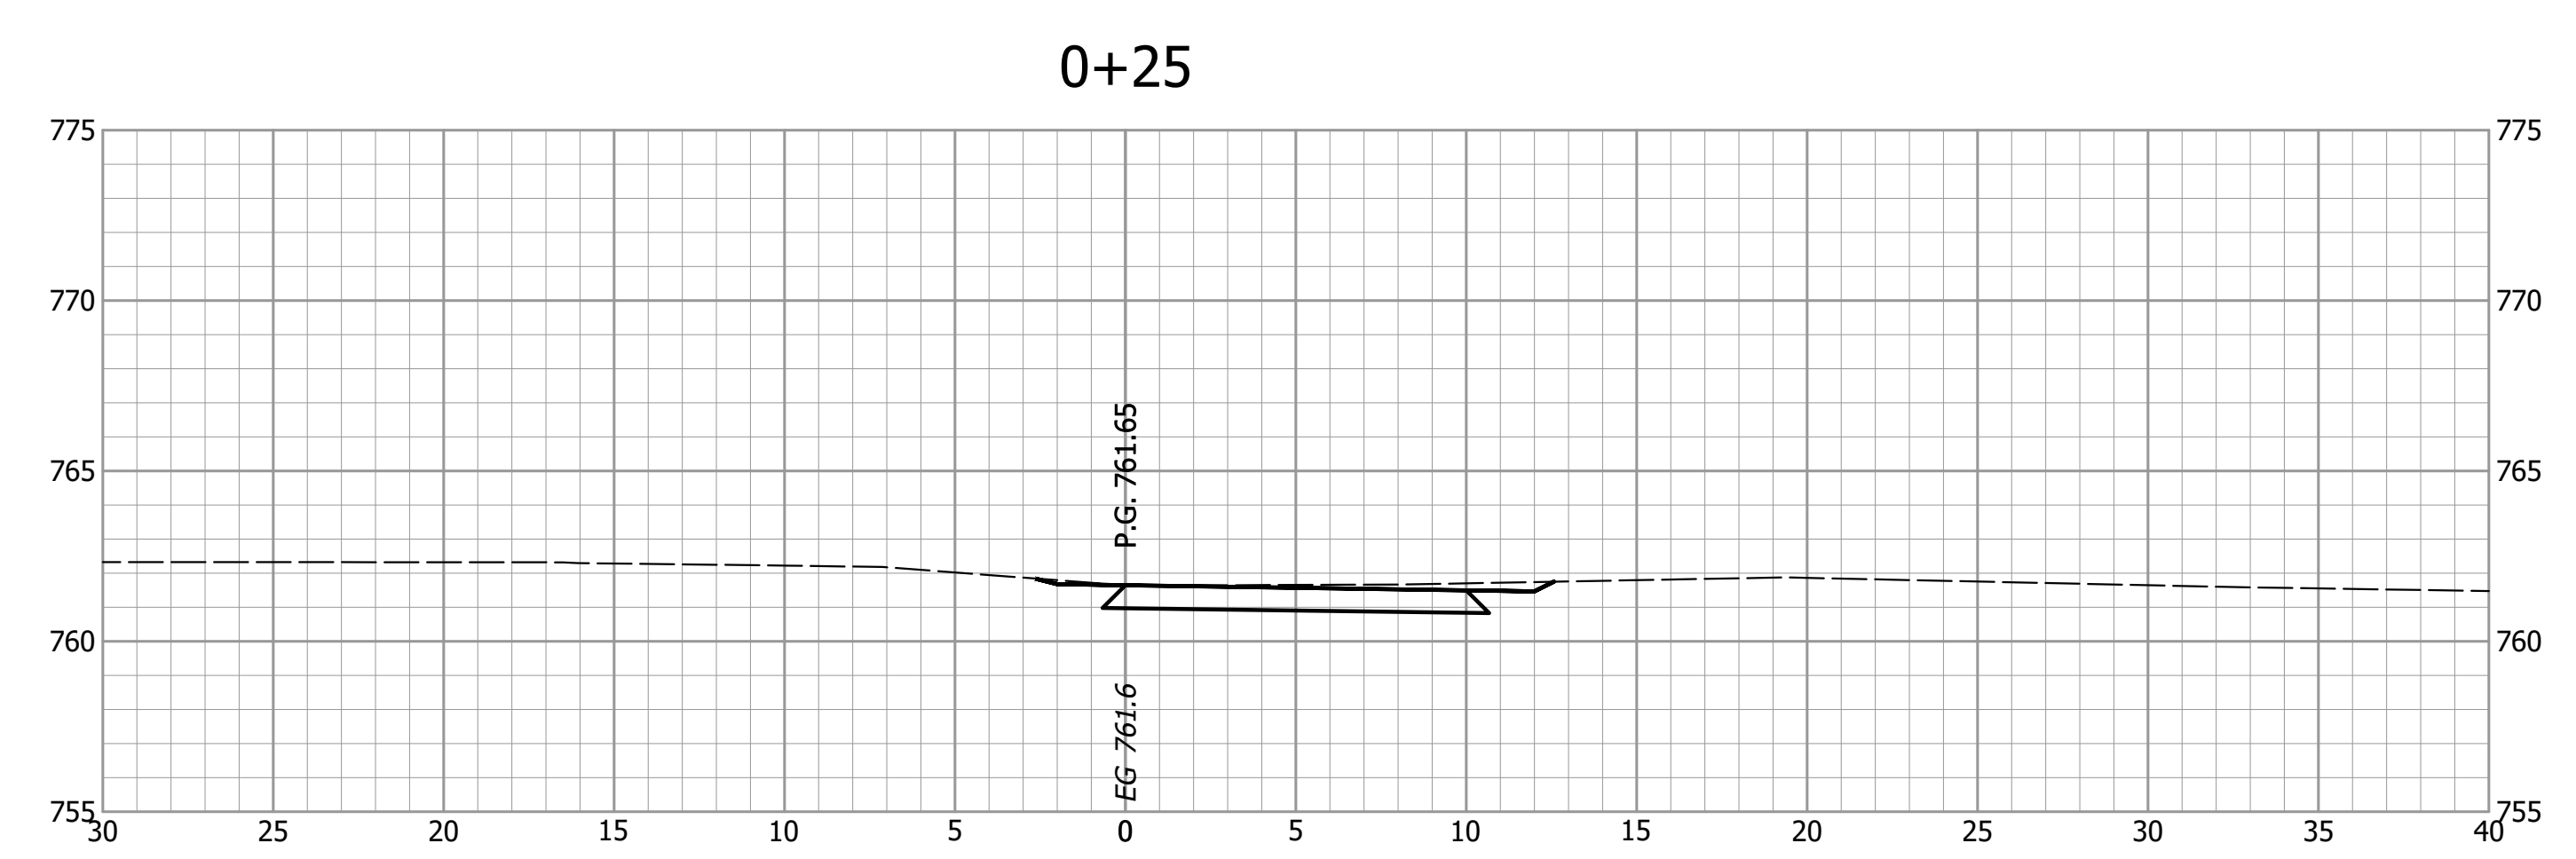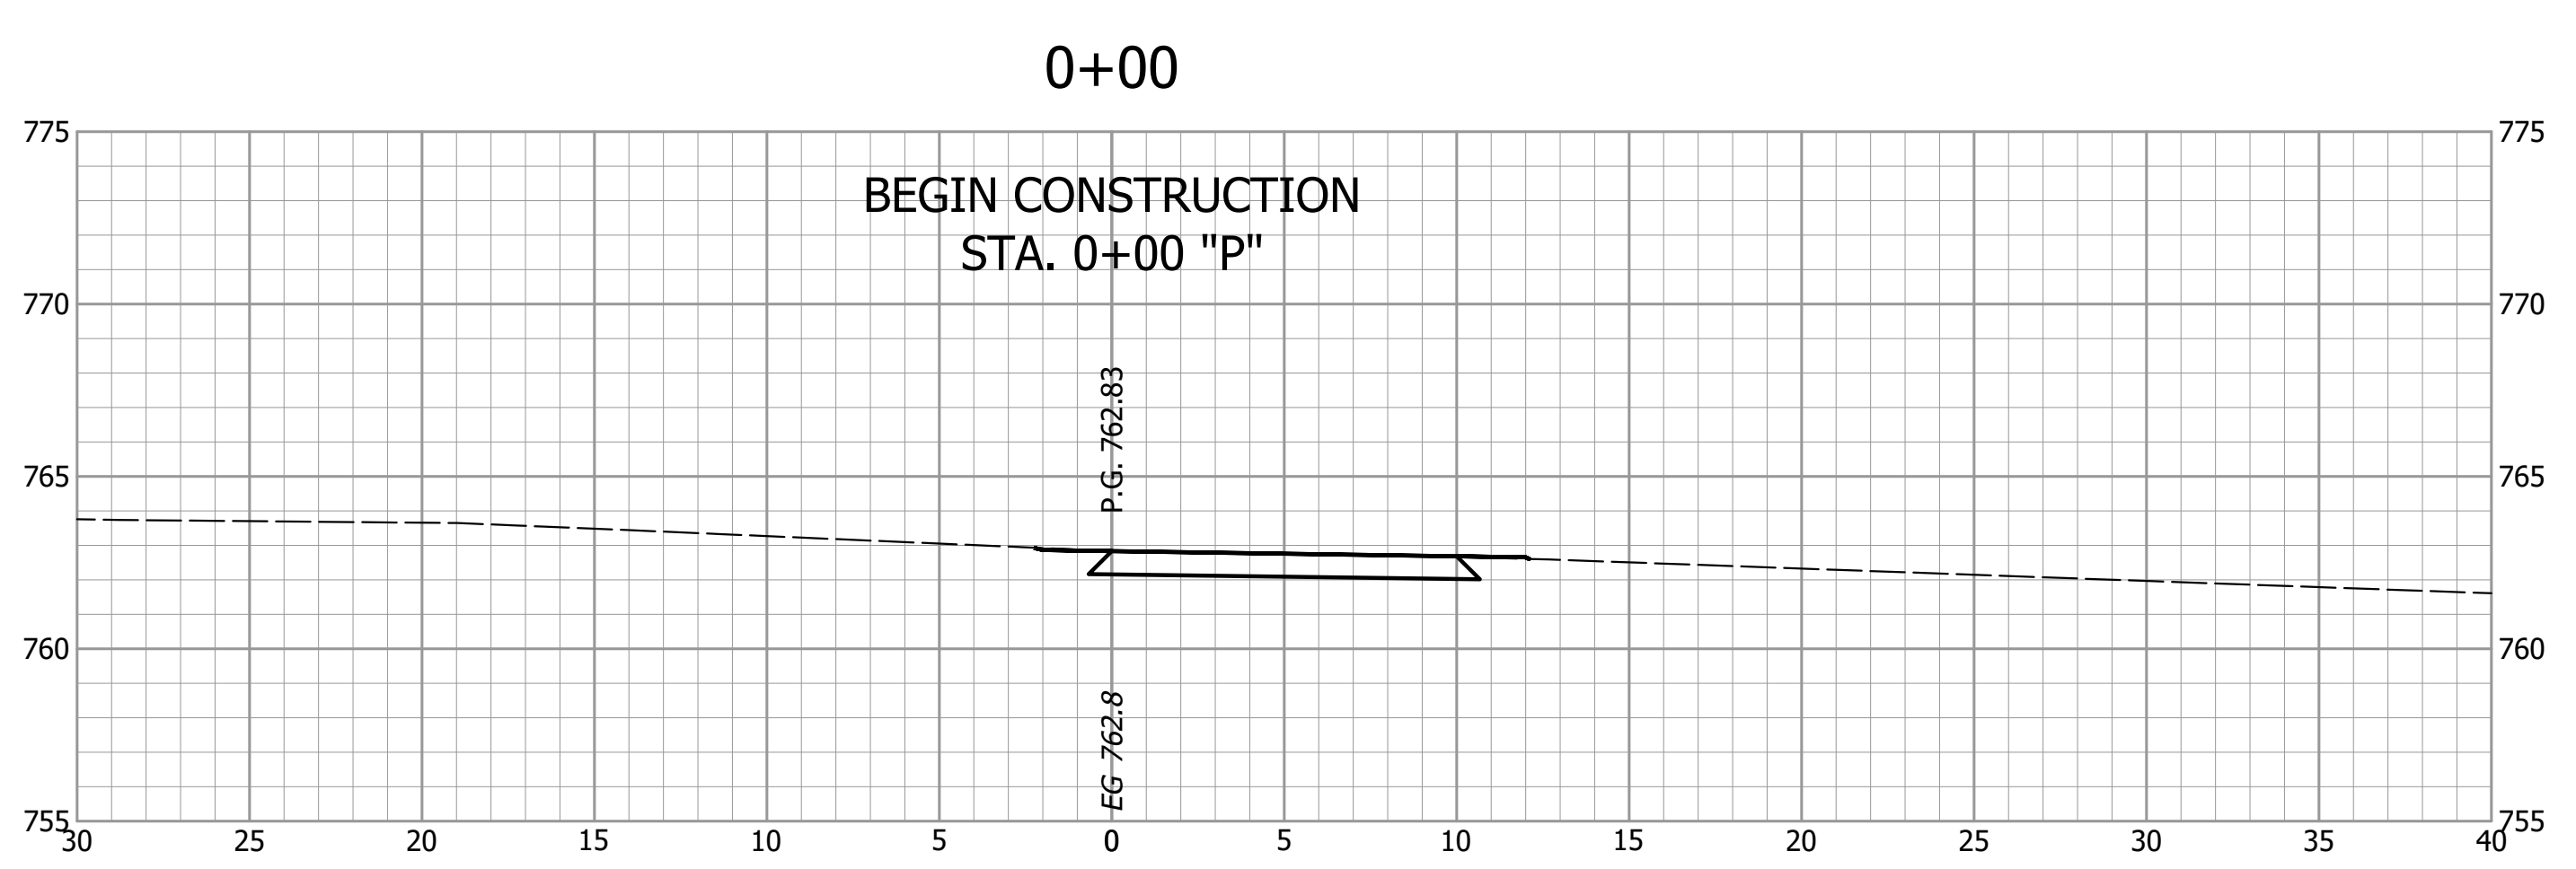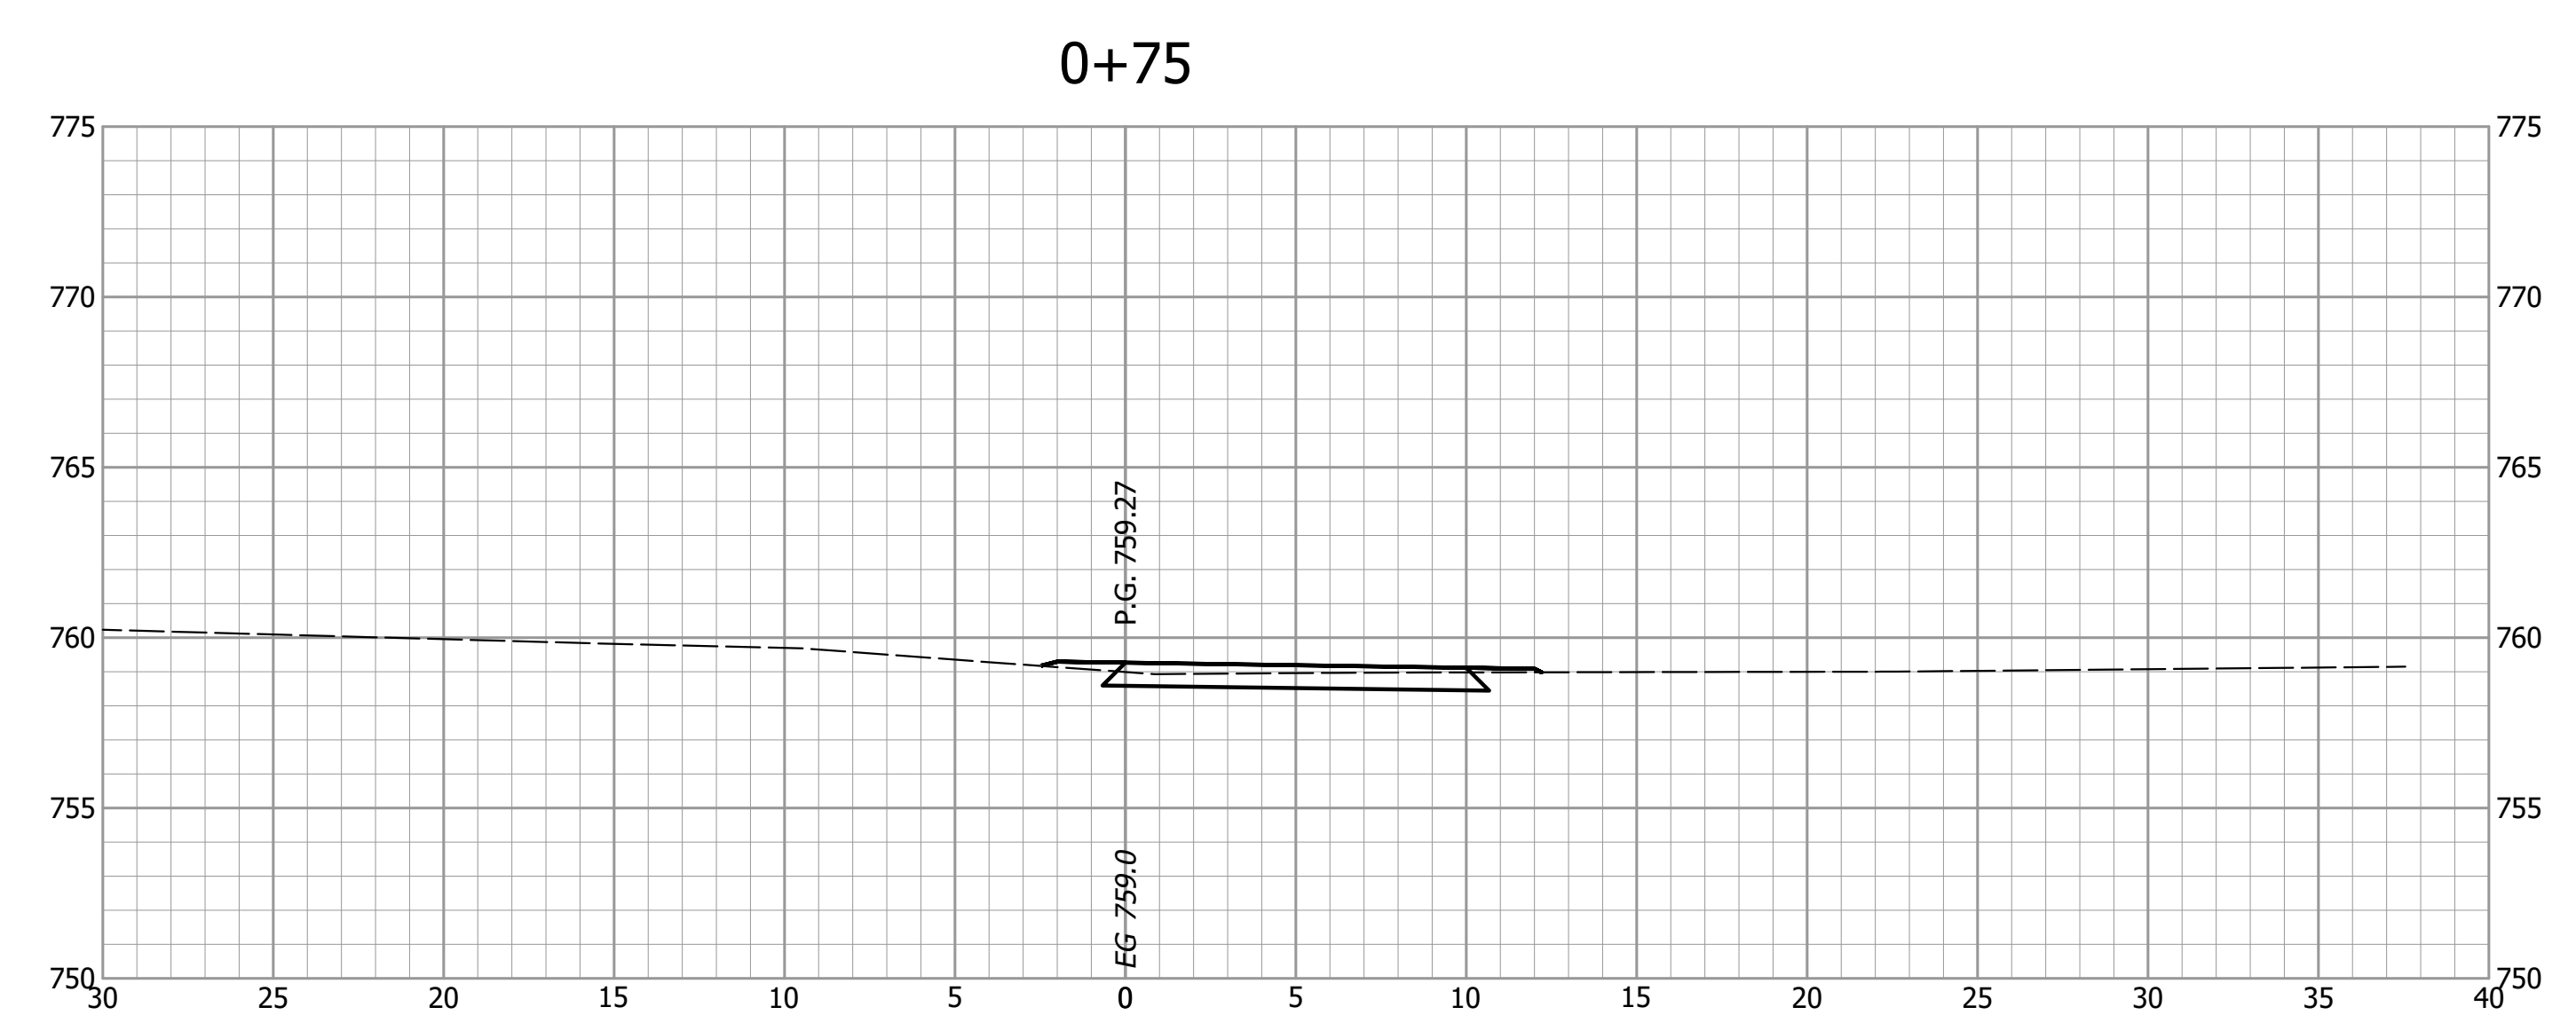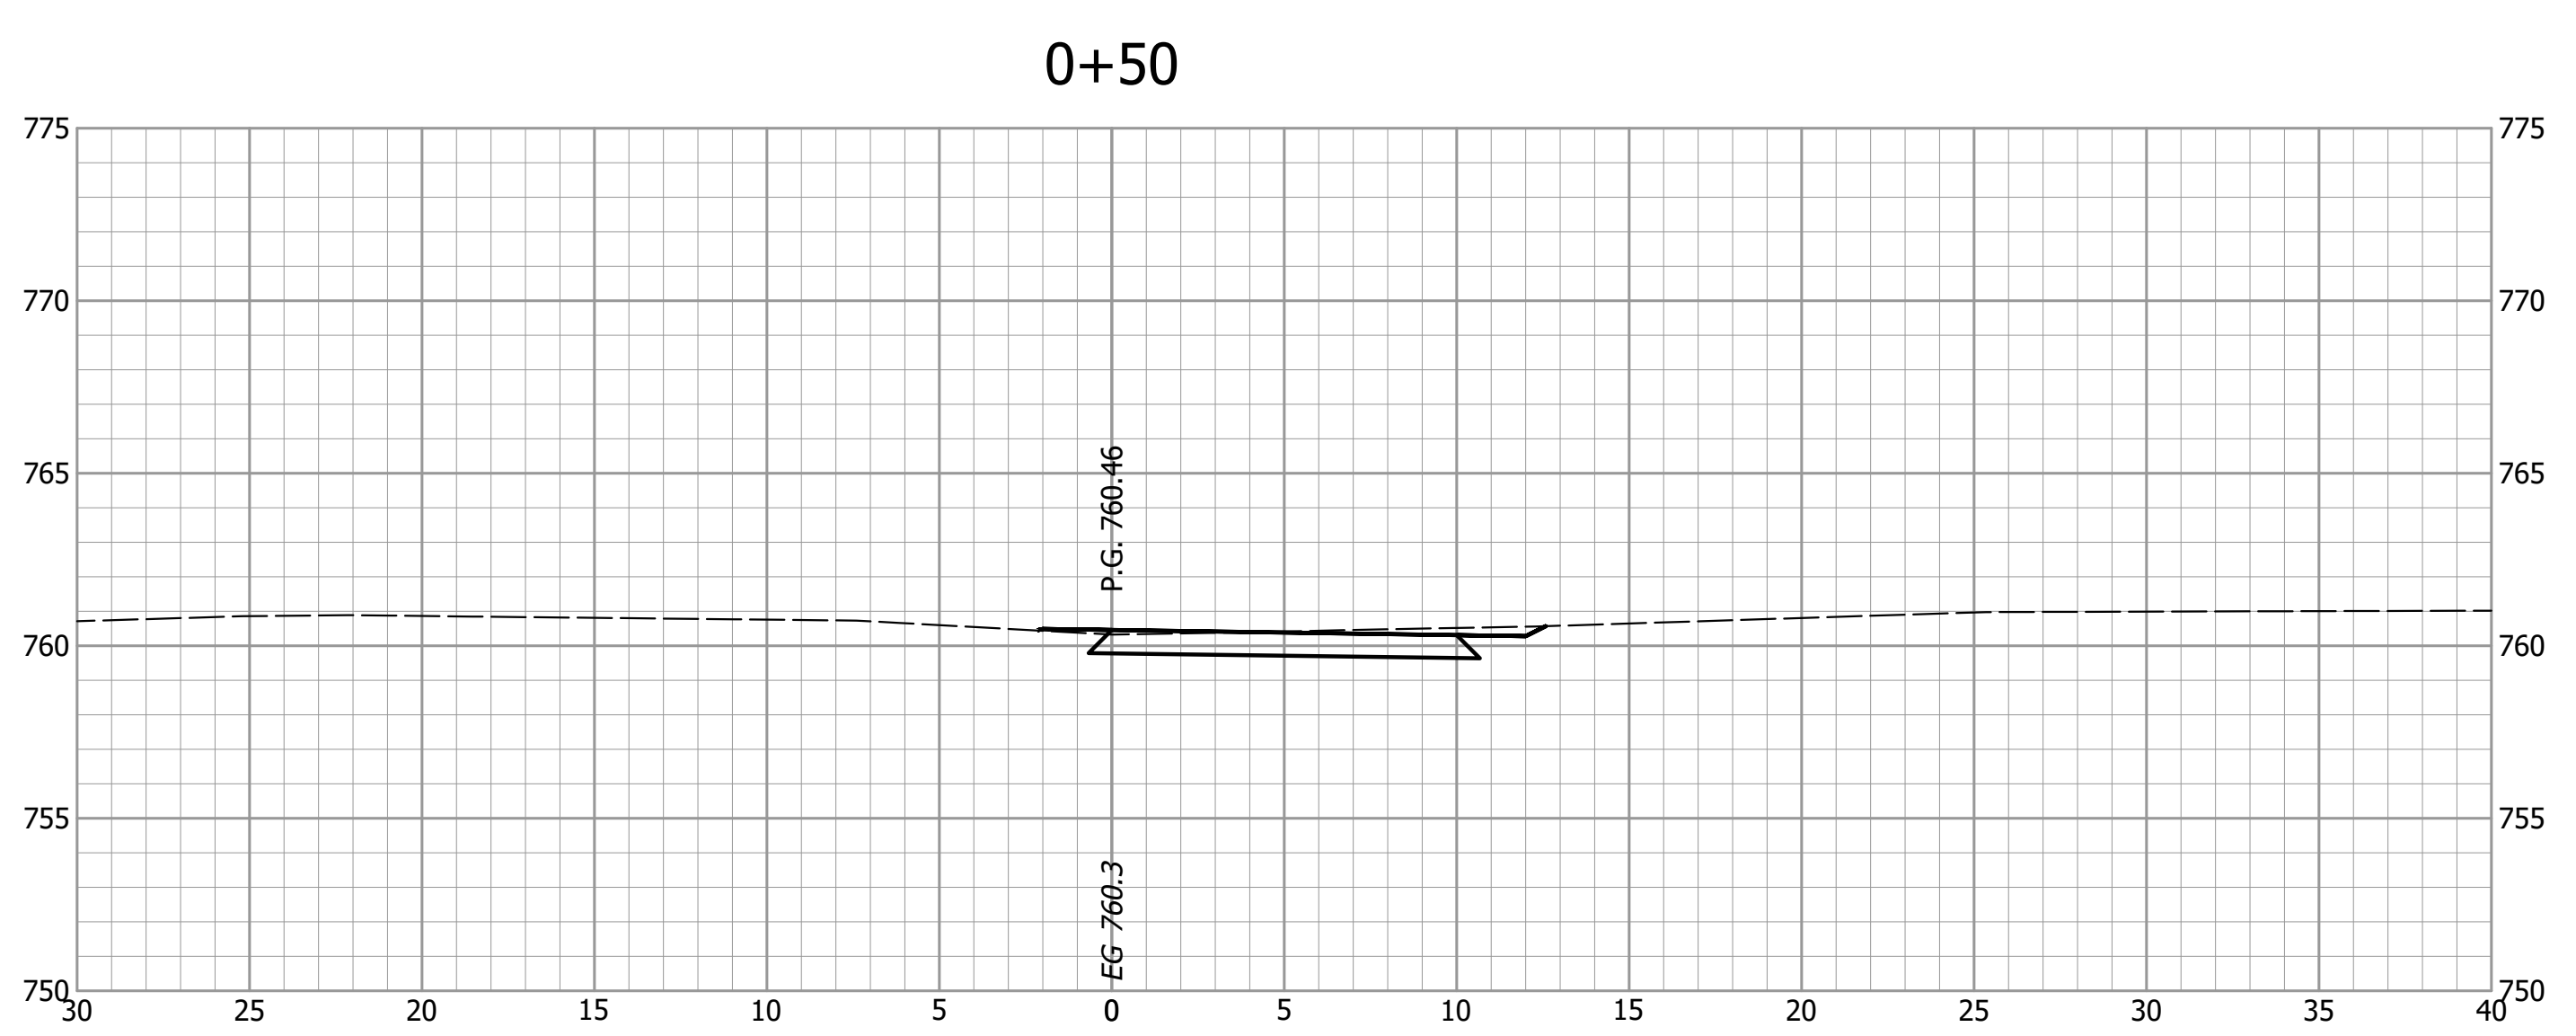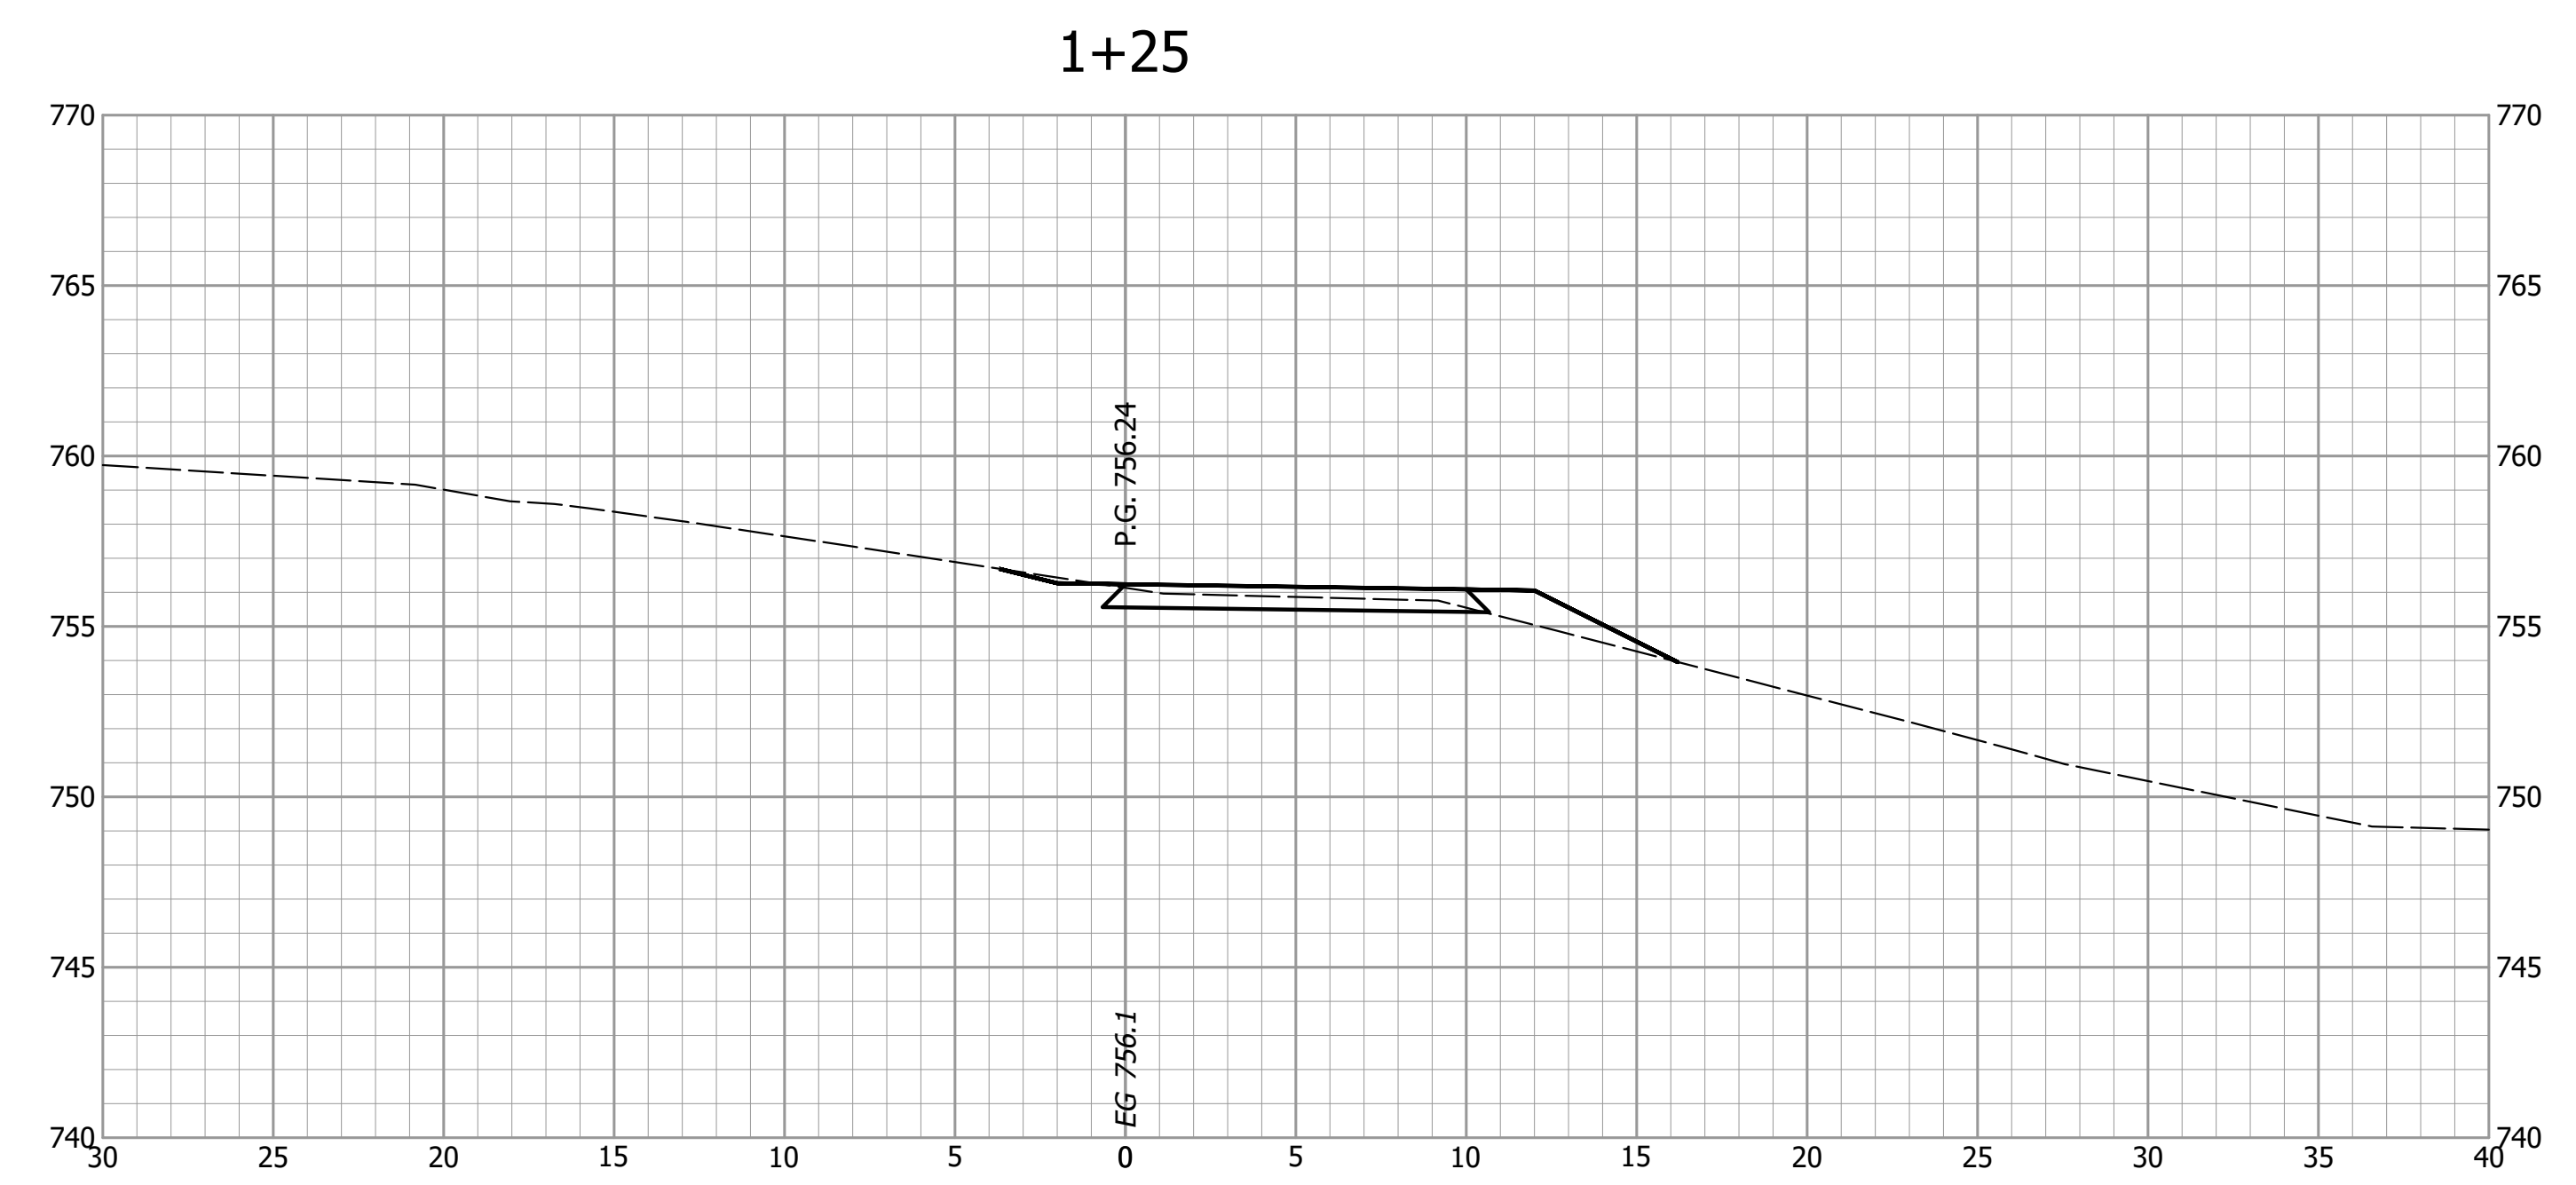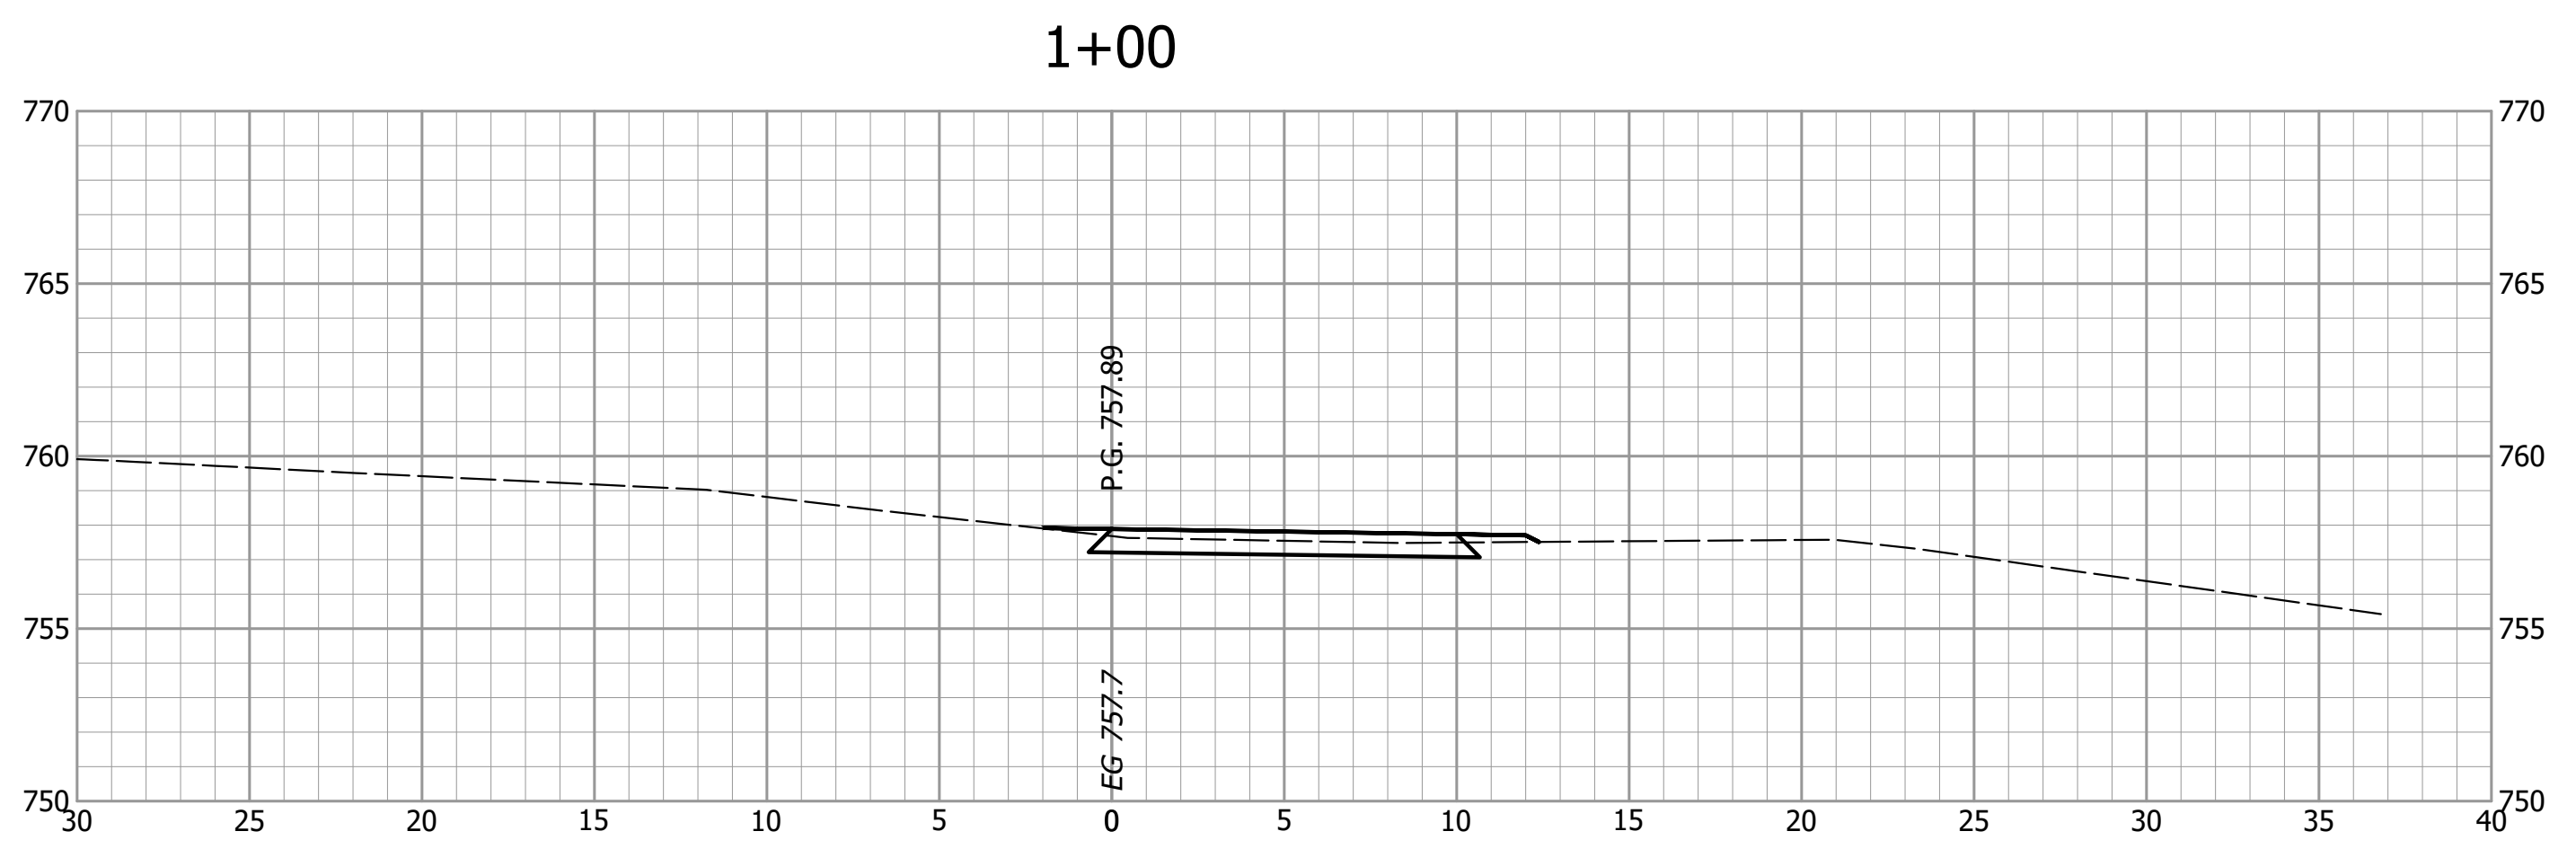

**NOT FOR
CONSTRUCTION**


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CHECKED: KAM	CHECKED: BMA

**INDIANA
DEPARTMENT OF TRANSPORTATION**


**CROSS SECTIONS
ST. MARYS PATHWAY - LINE "P"**

HORIZONTAL SCALE 1" = 5'	BRIDGE FILE ALLEN 358
VERTICAL SCALE 1" = 5'	DESIGNATION 1902834
SURVEY BOOK ----	SHEETS 60 of 63
CONTRACT B-42844	PROJECT 1902834


2+00

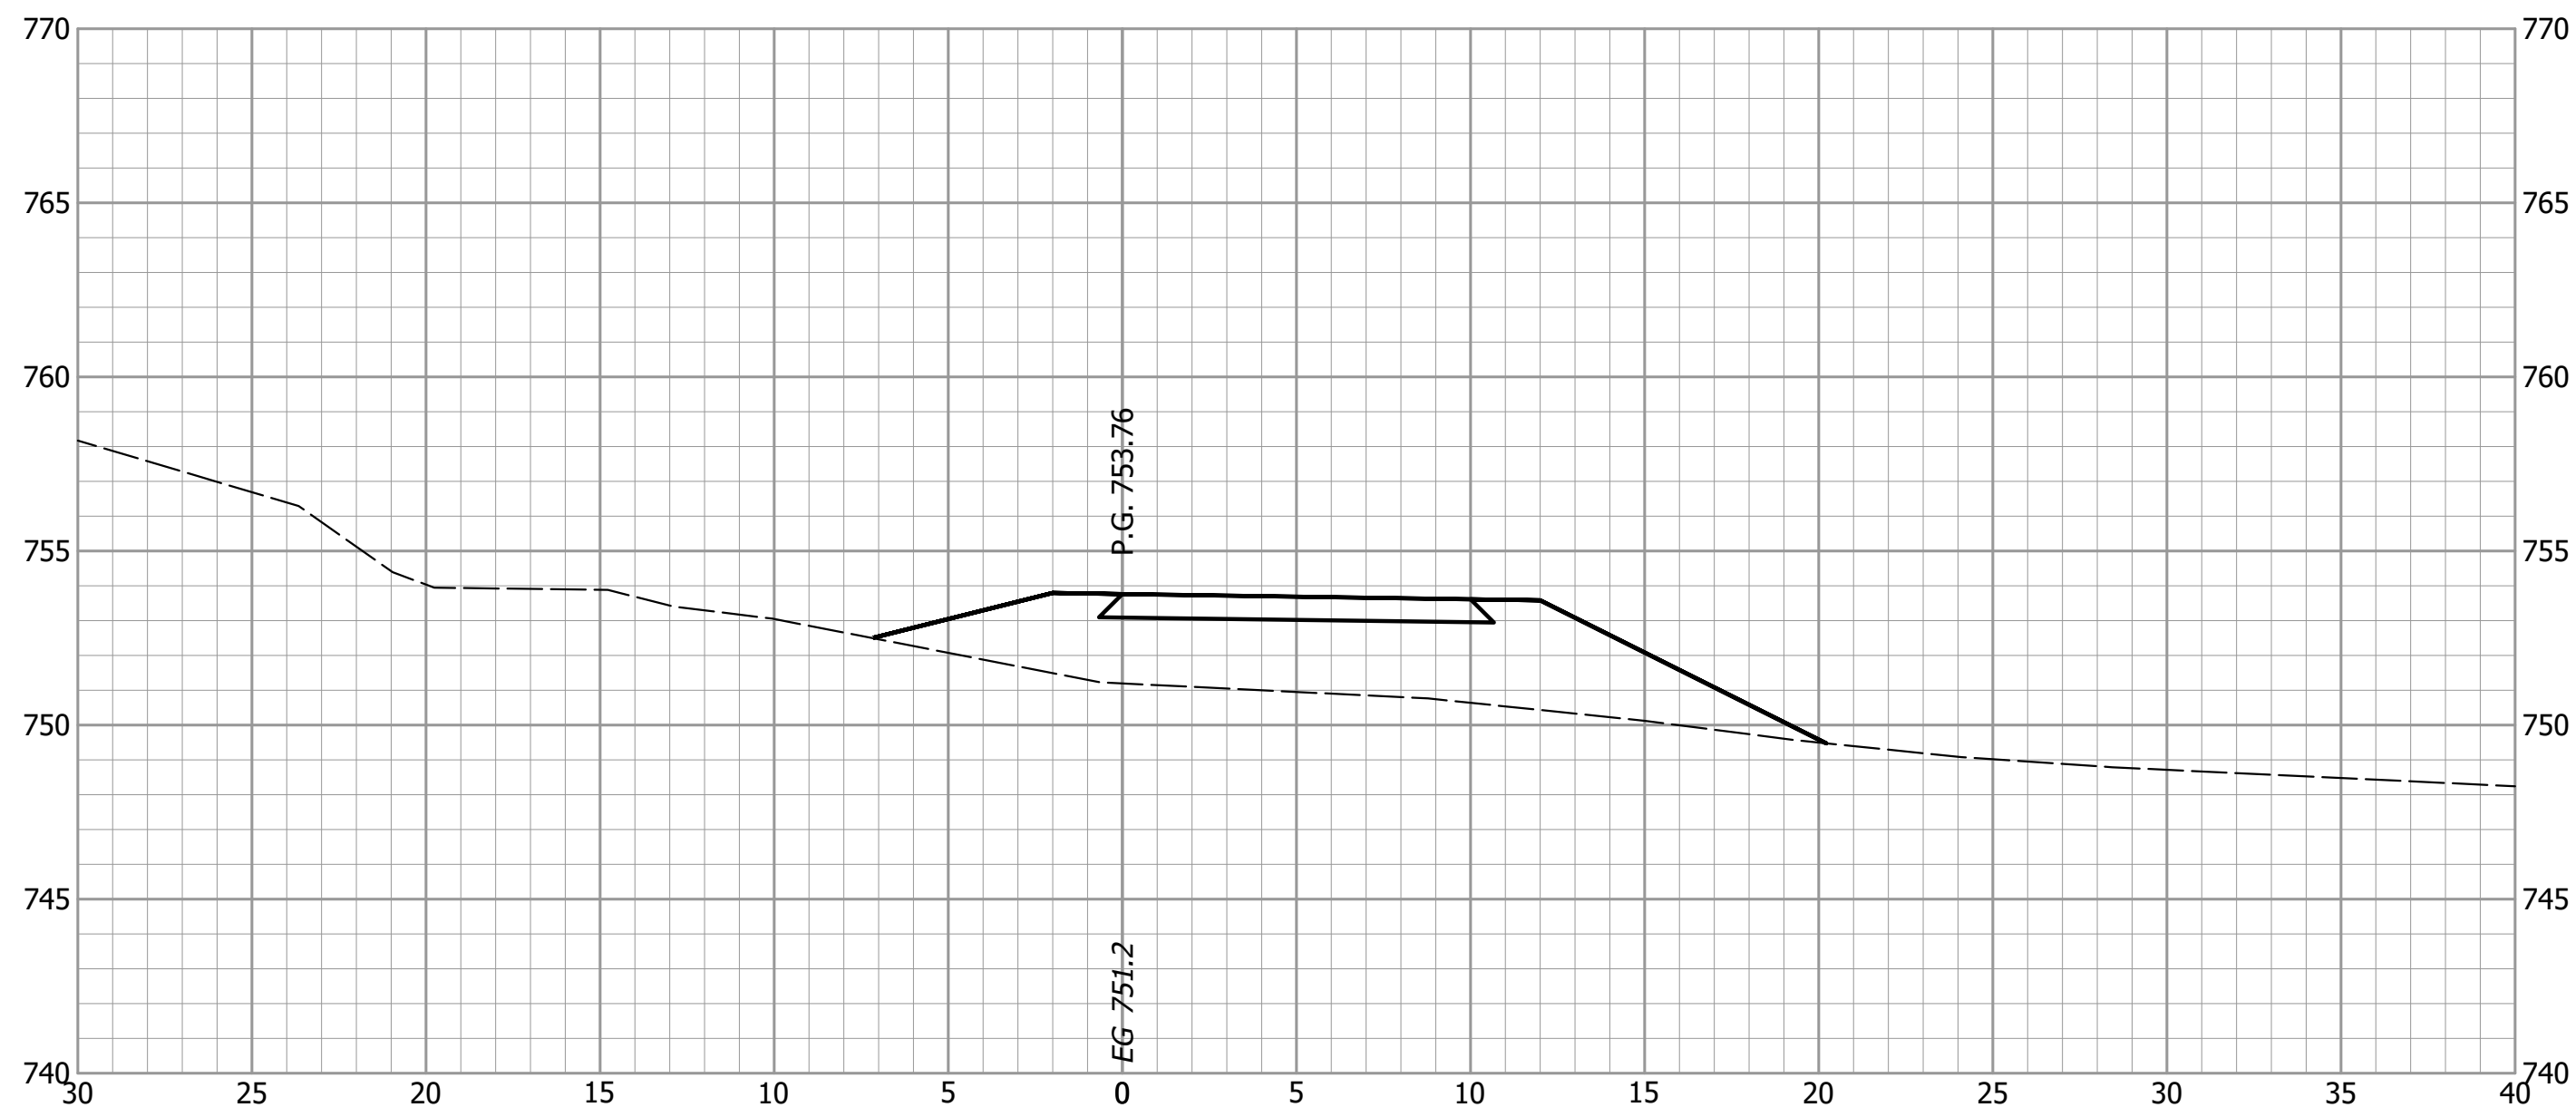


2+25

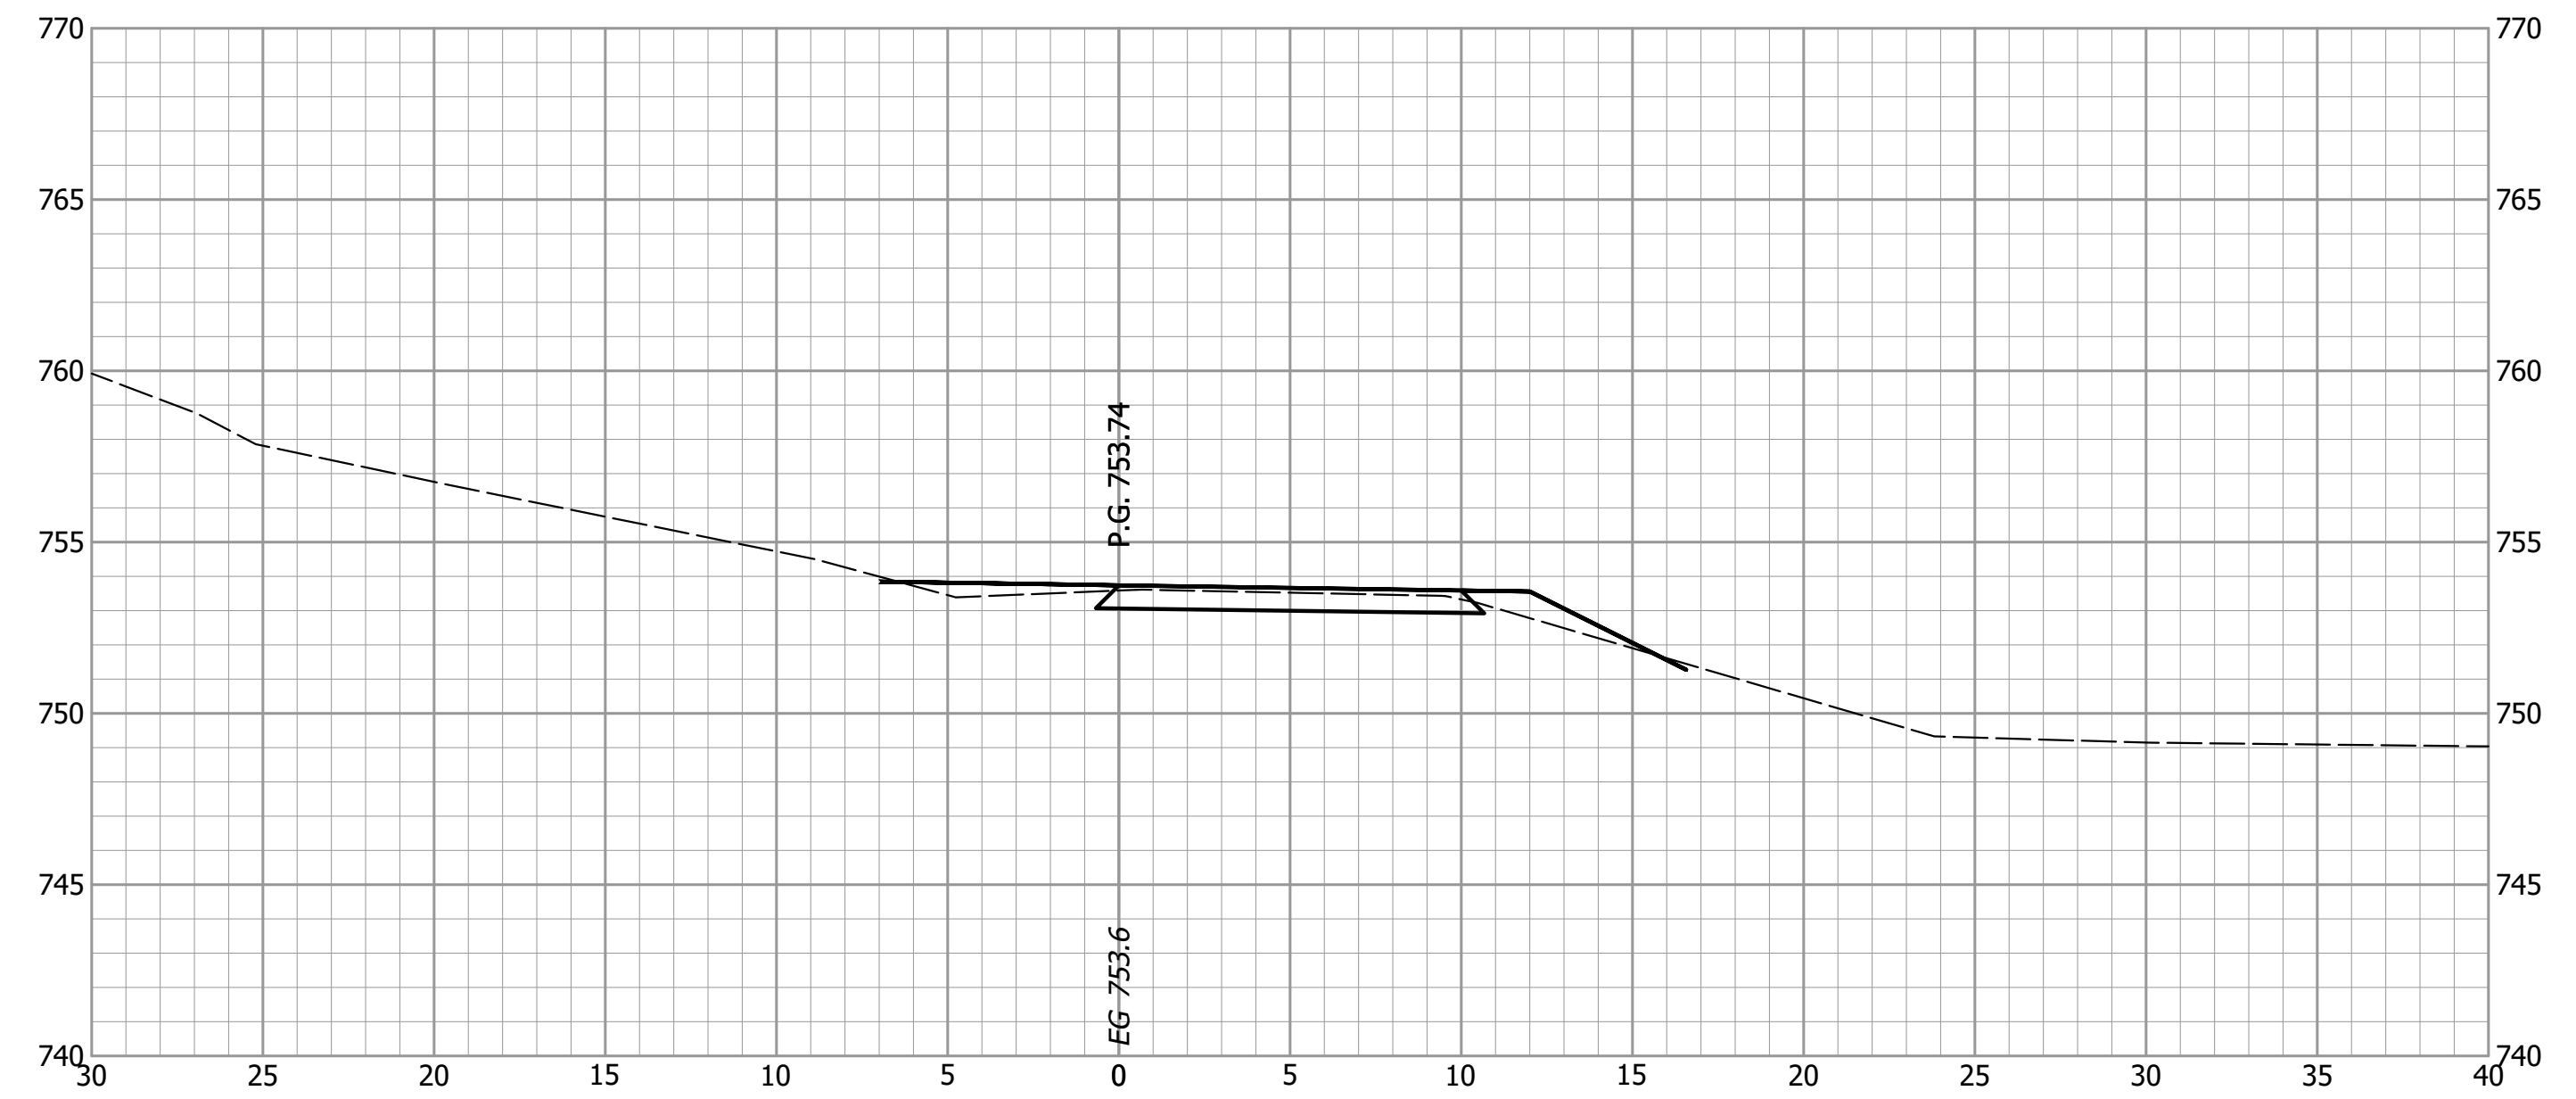

1+50

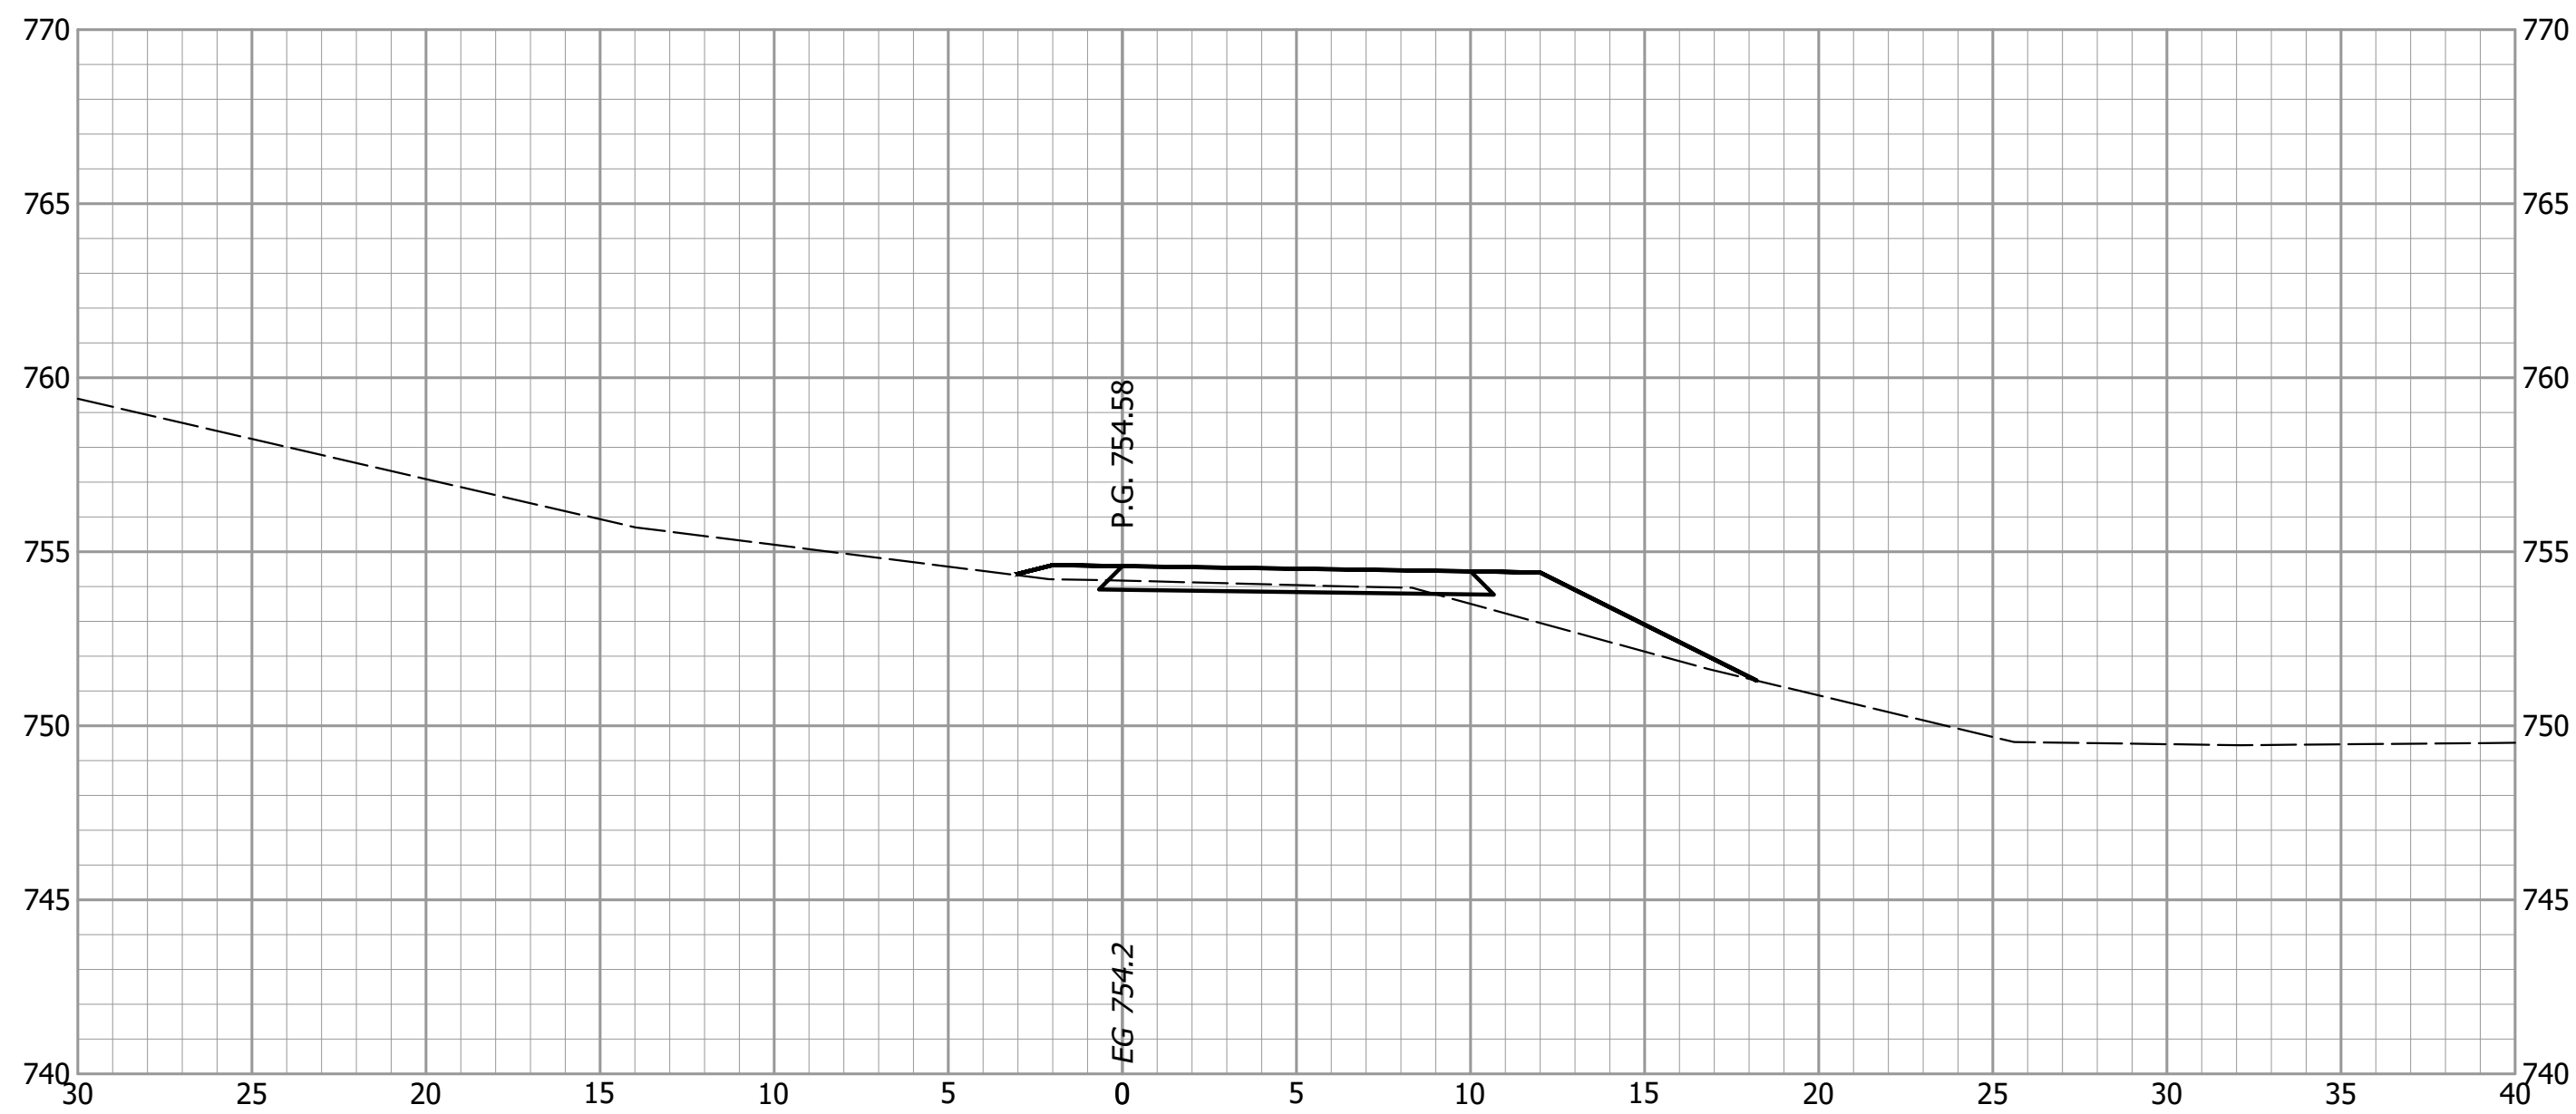

1+75

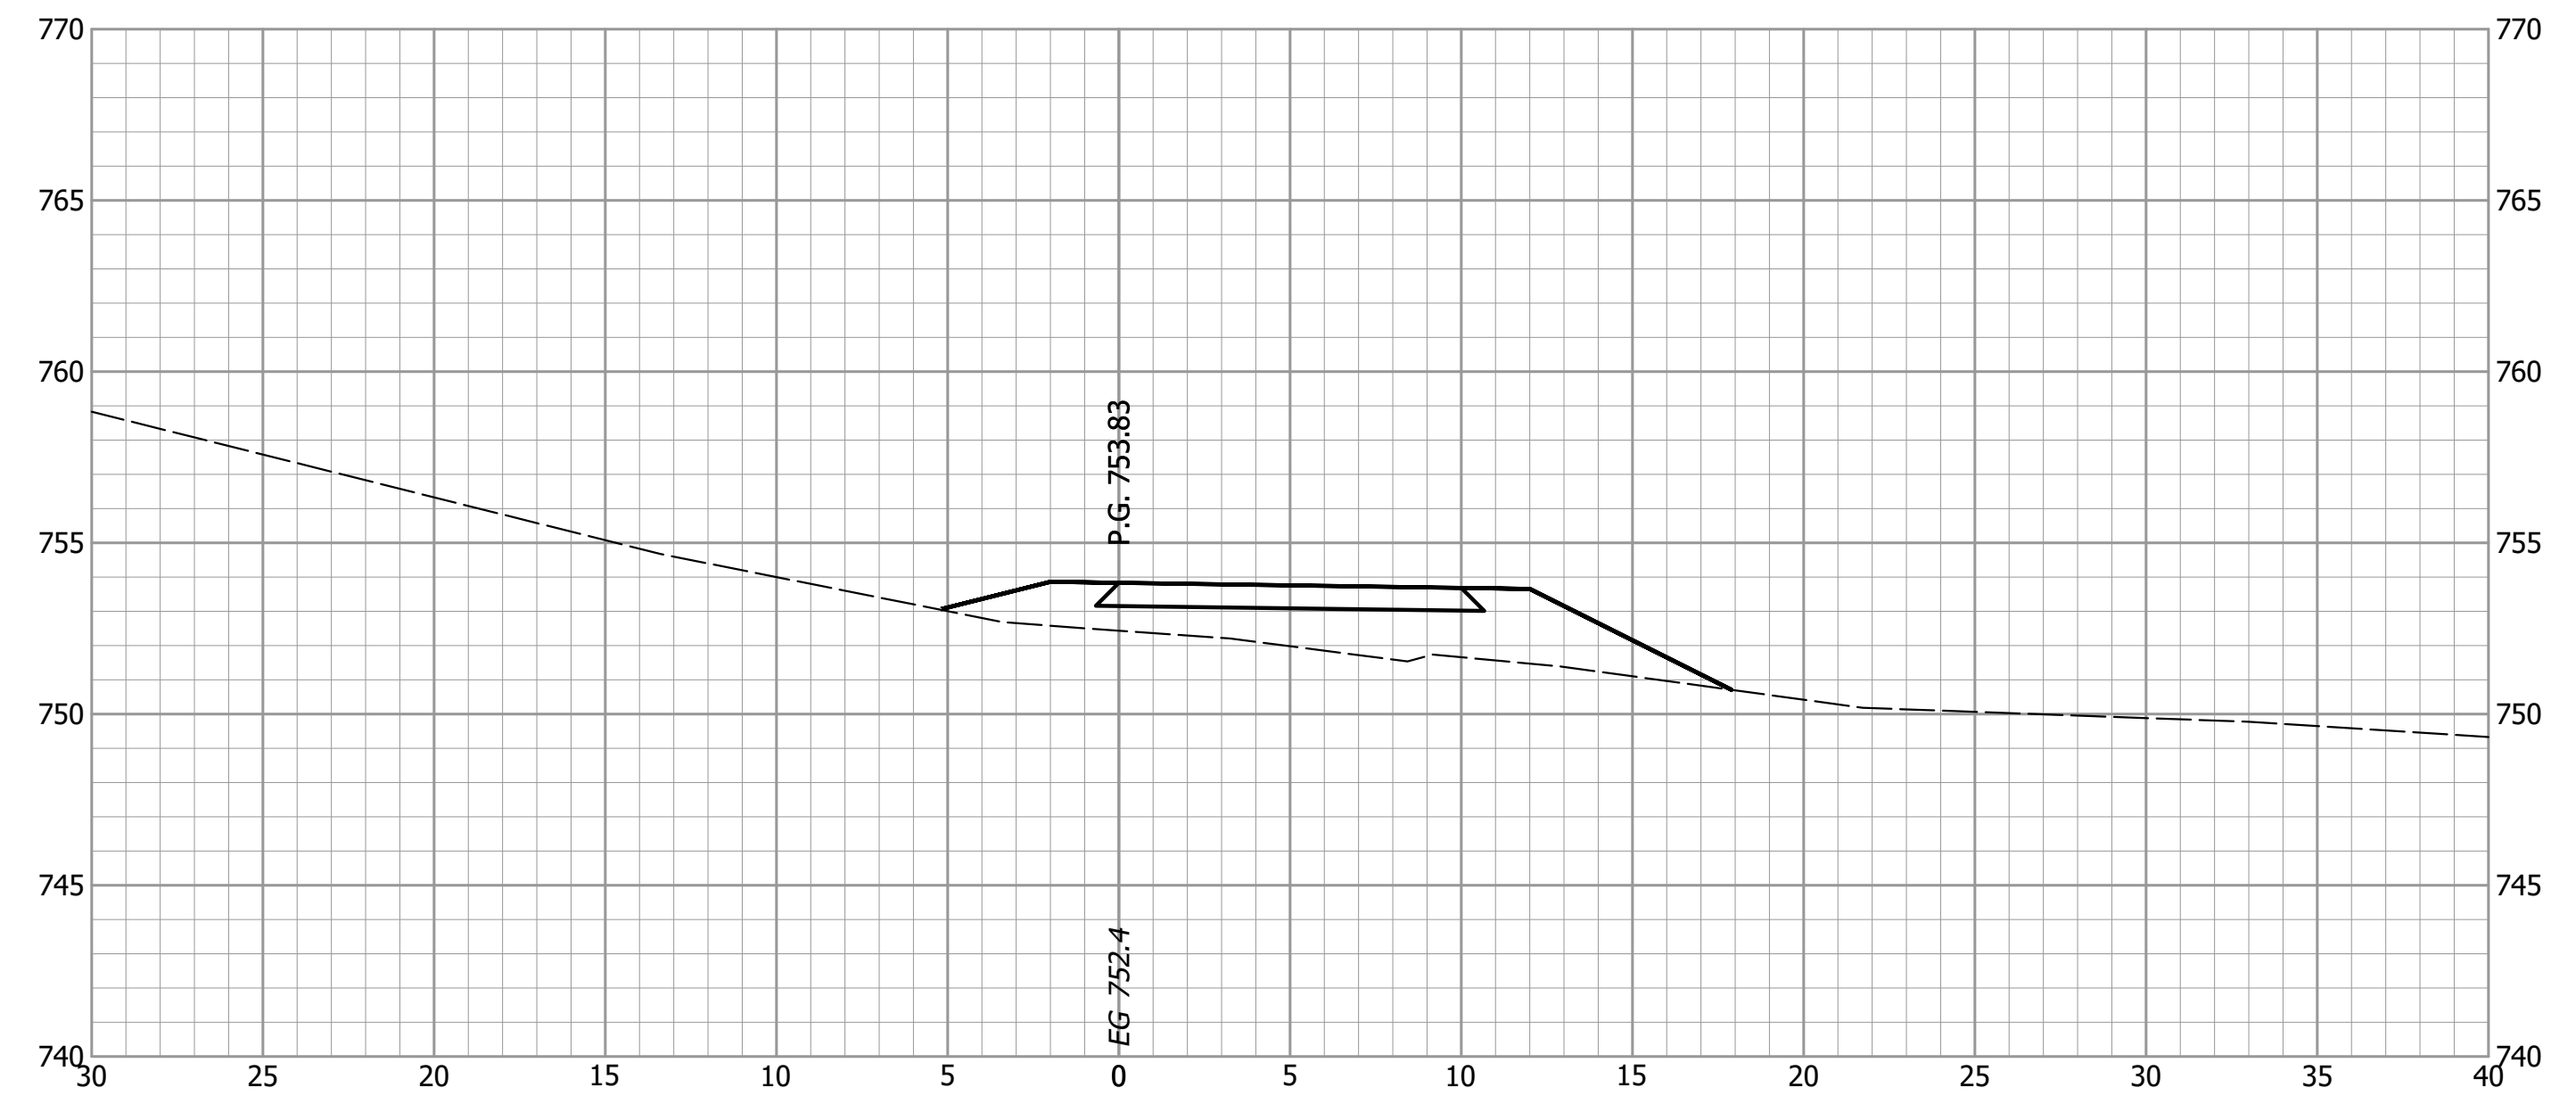


NOT FOR CONSTRUCTION

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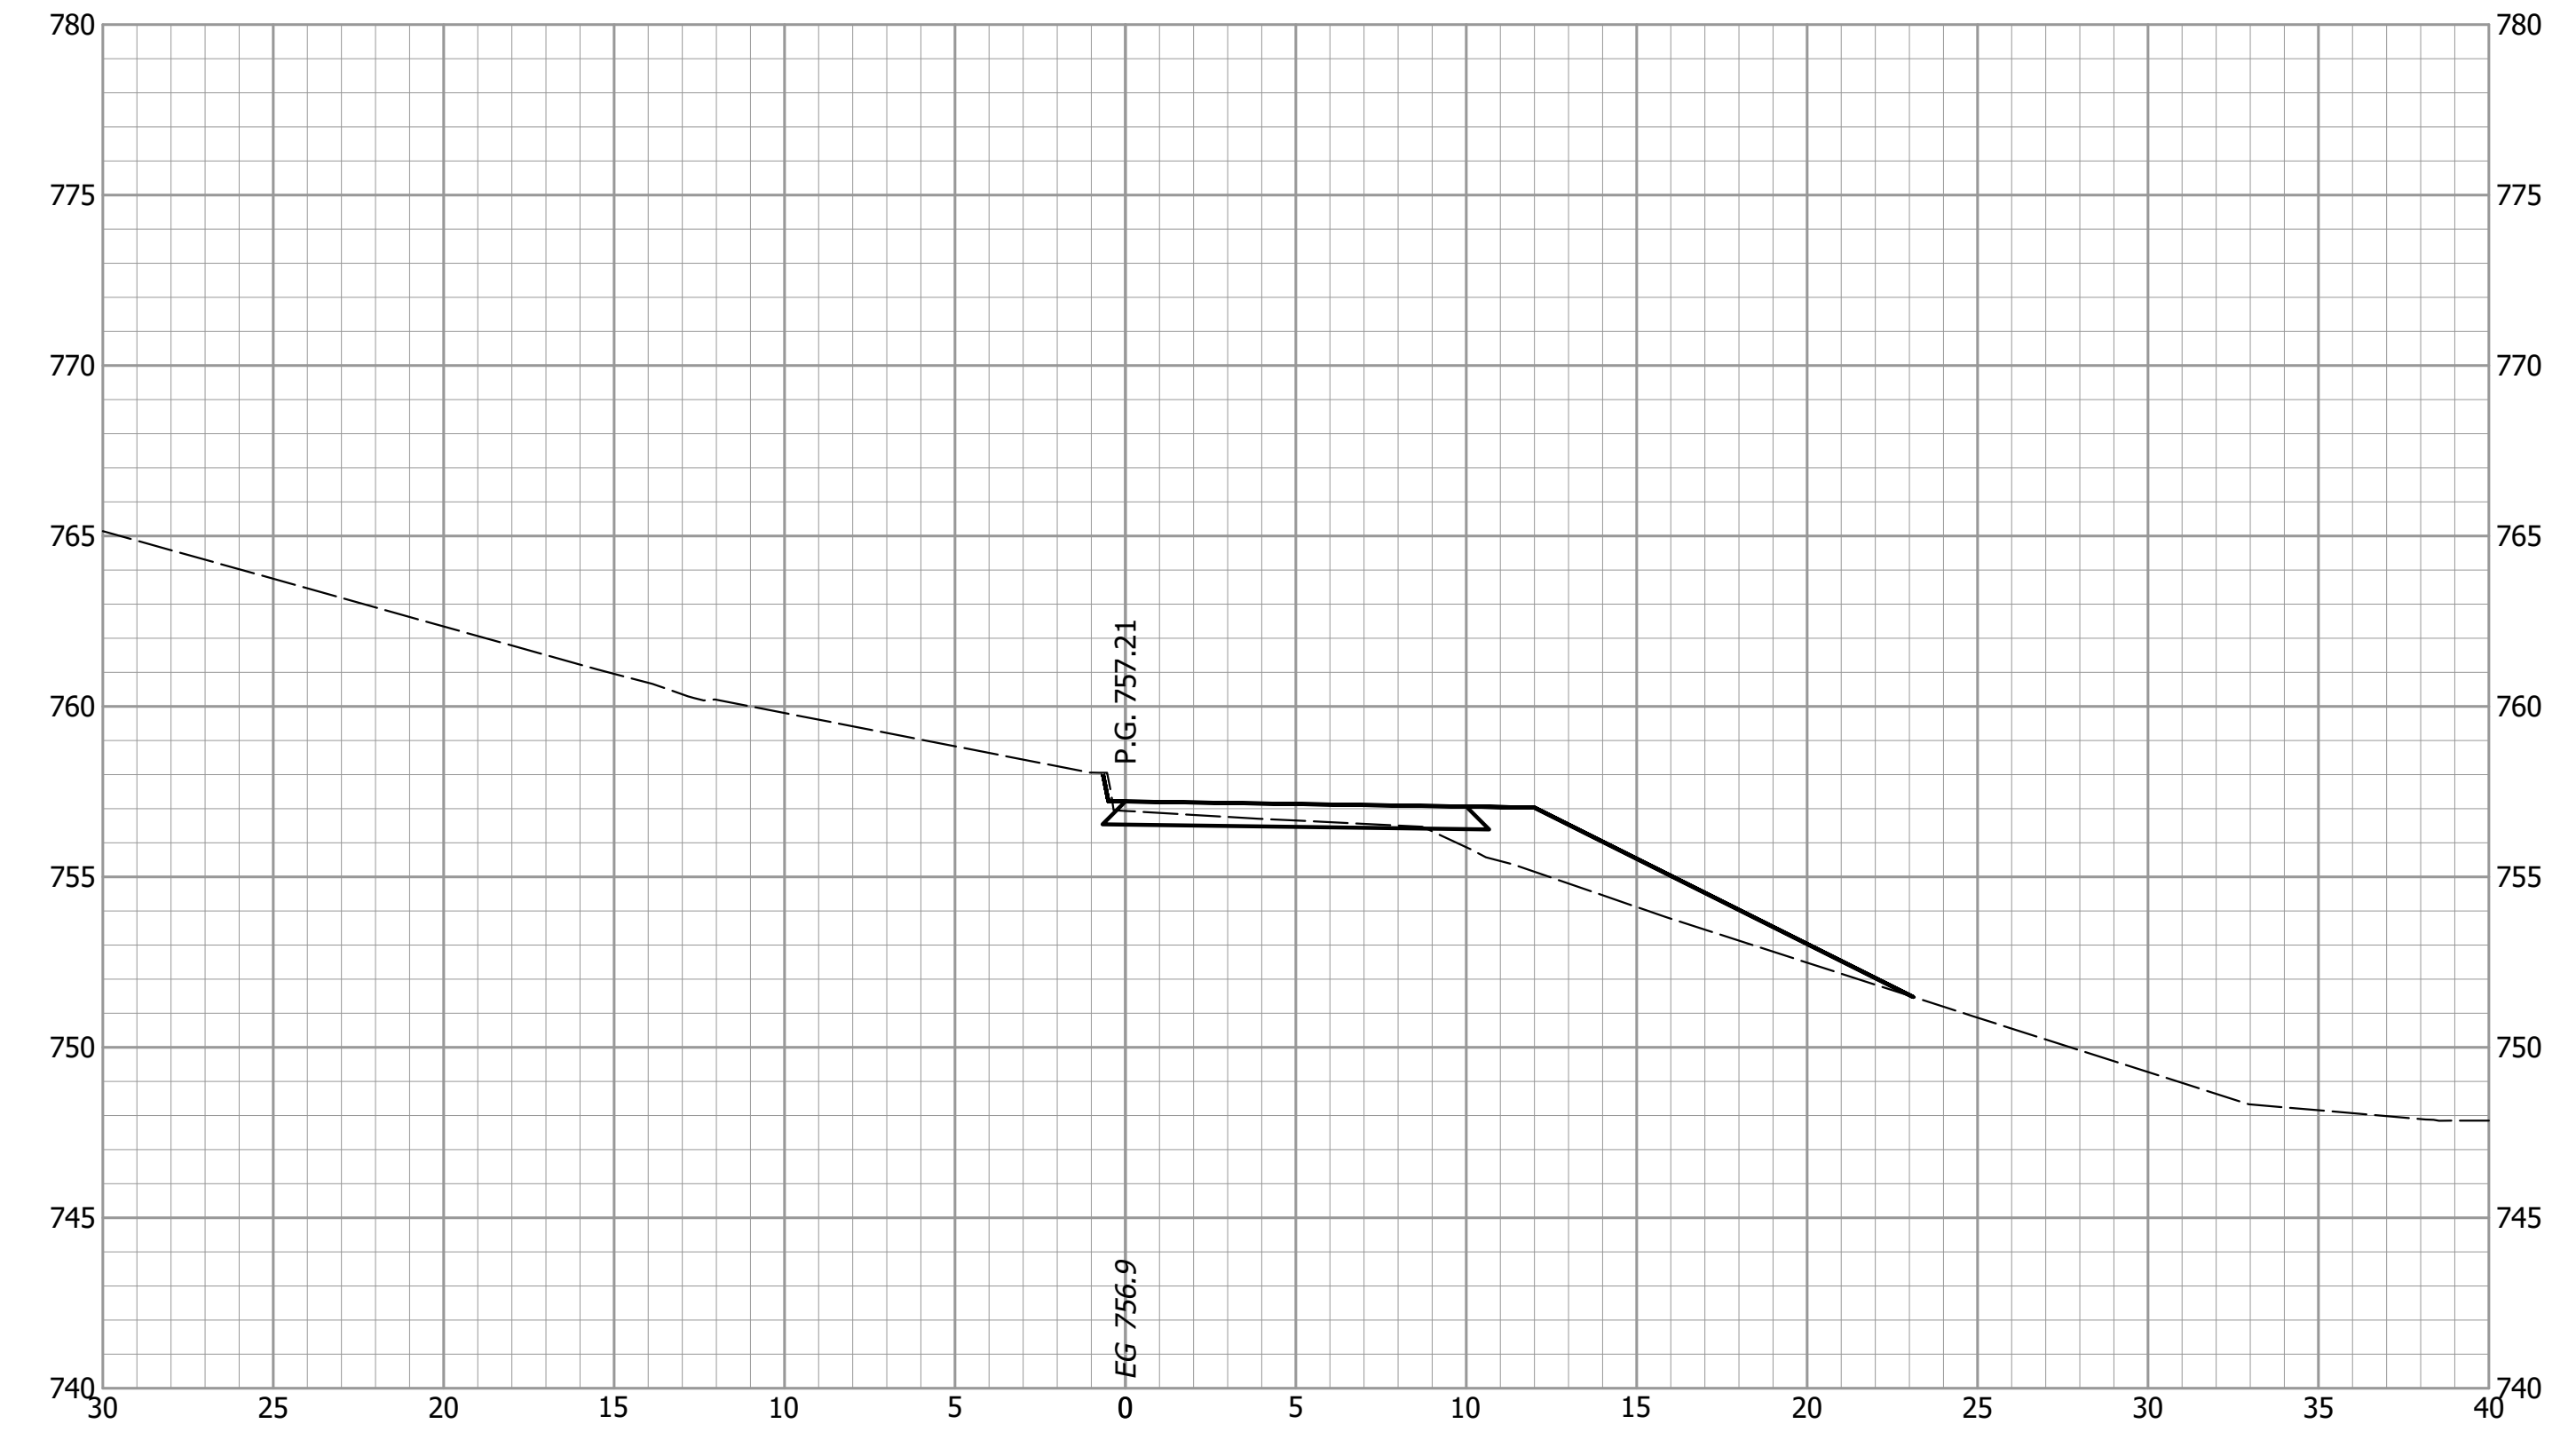
INDIANA
 DEPARTMENT OF TRANSPORTATION
 CROSS SECTIONS
 ST. MARYS PATHWAY - LINE "P"

HORIZONTAL SCALE 1" = 5'	BRIDGE FILE ALLEN 358
VERTICAL SCALE 1" = 5'	DESIGNATION 1902834
SURVEY BOOK ----	SHEETS 61 of 63
CONTRACT B-42844	PROJECT 1902834


3+00

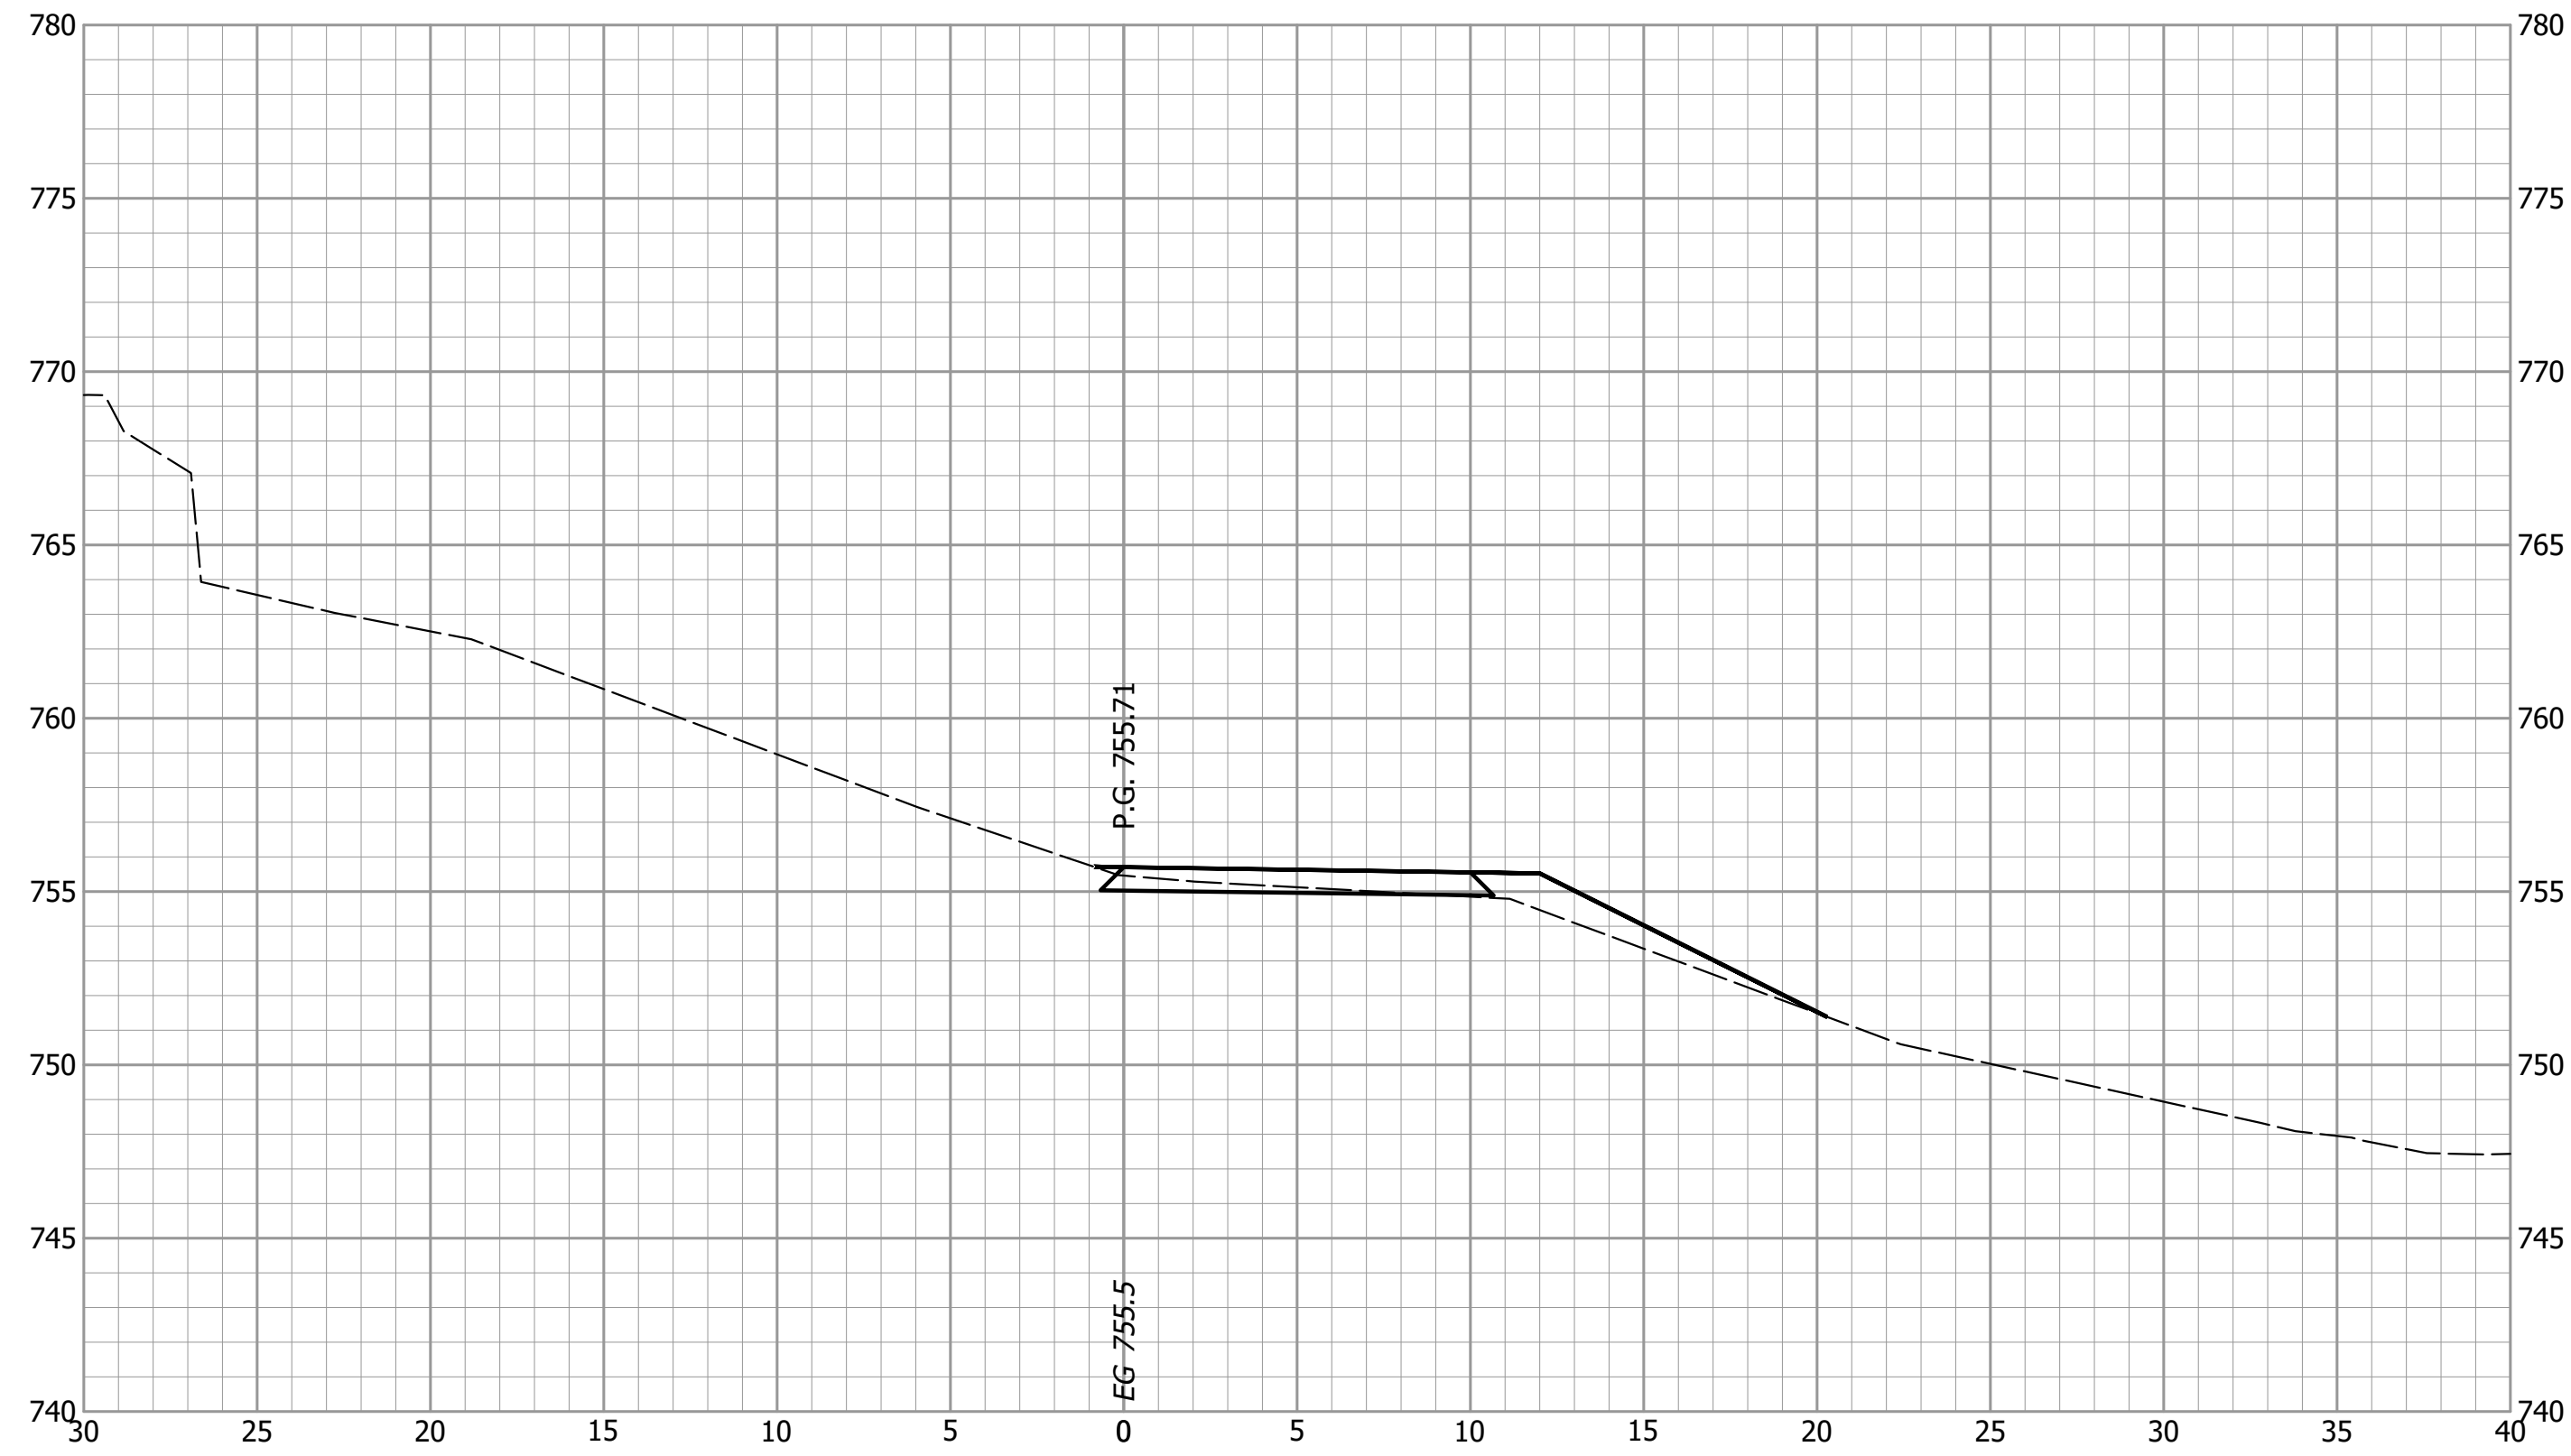


3+25



2+50

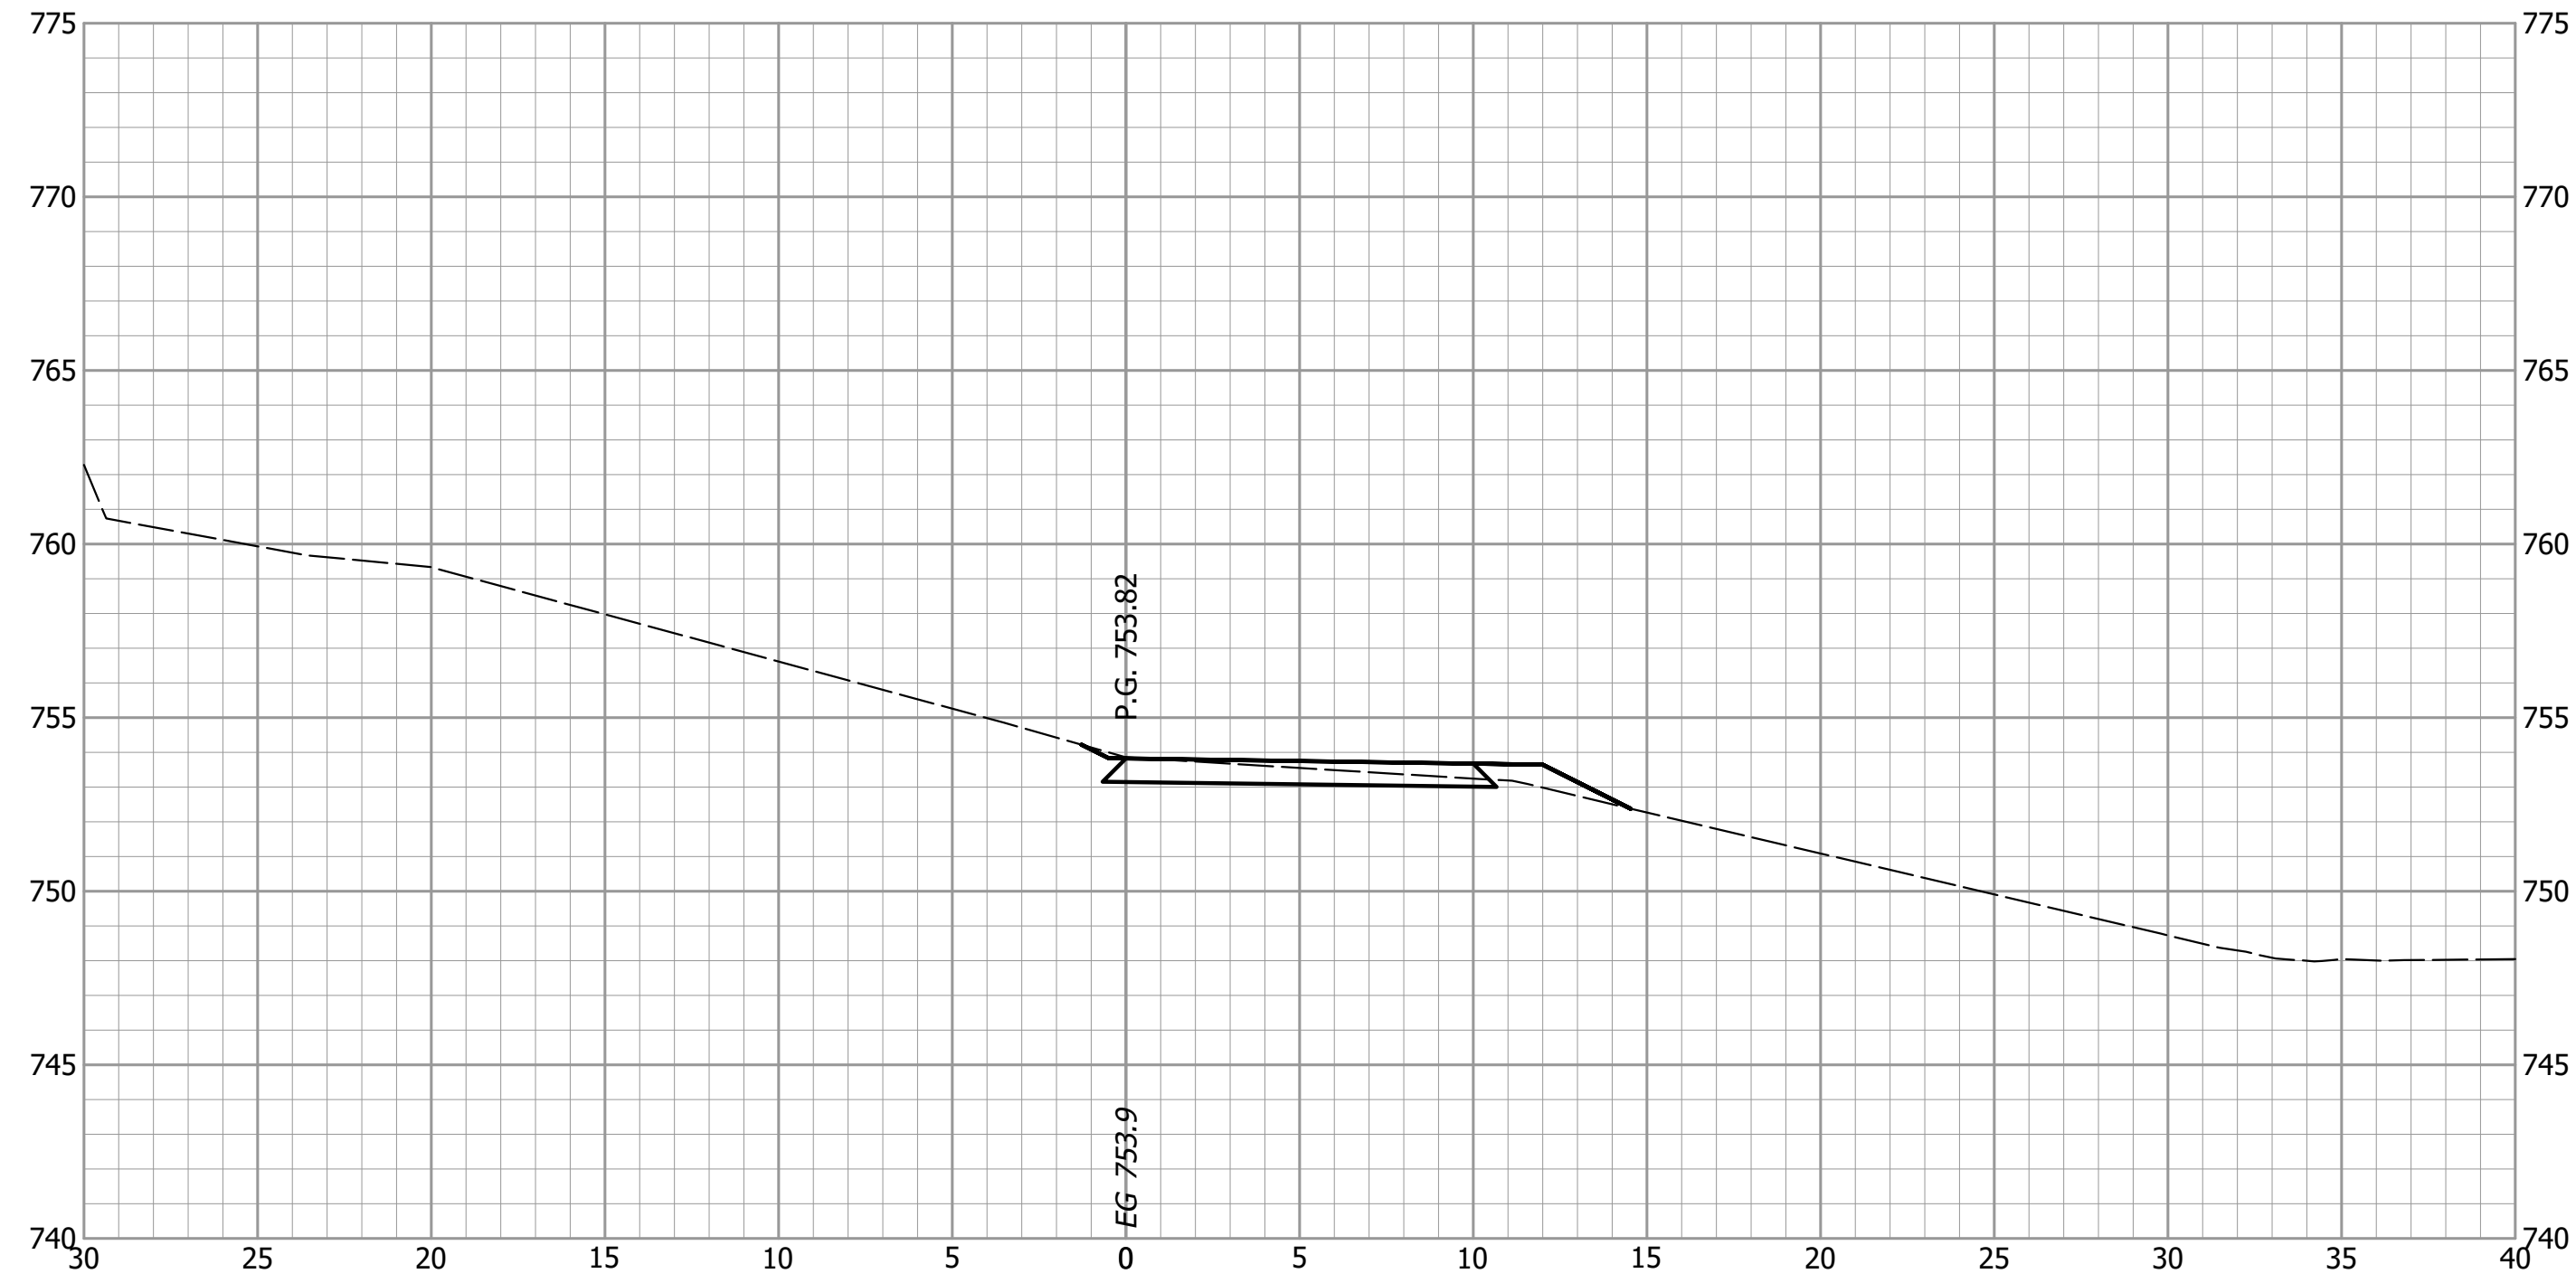

2+75

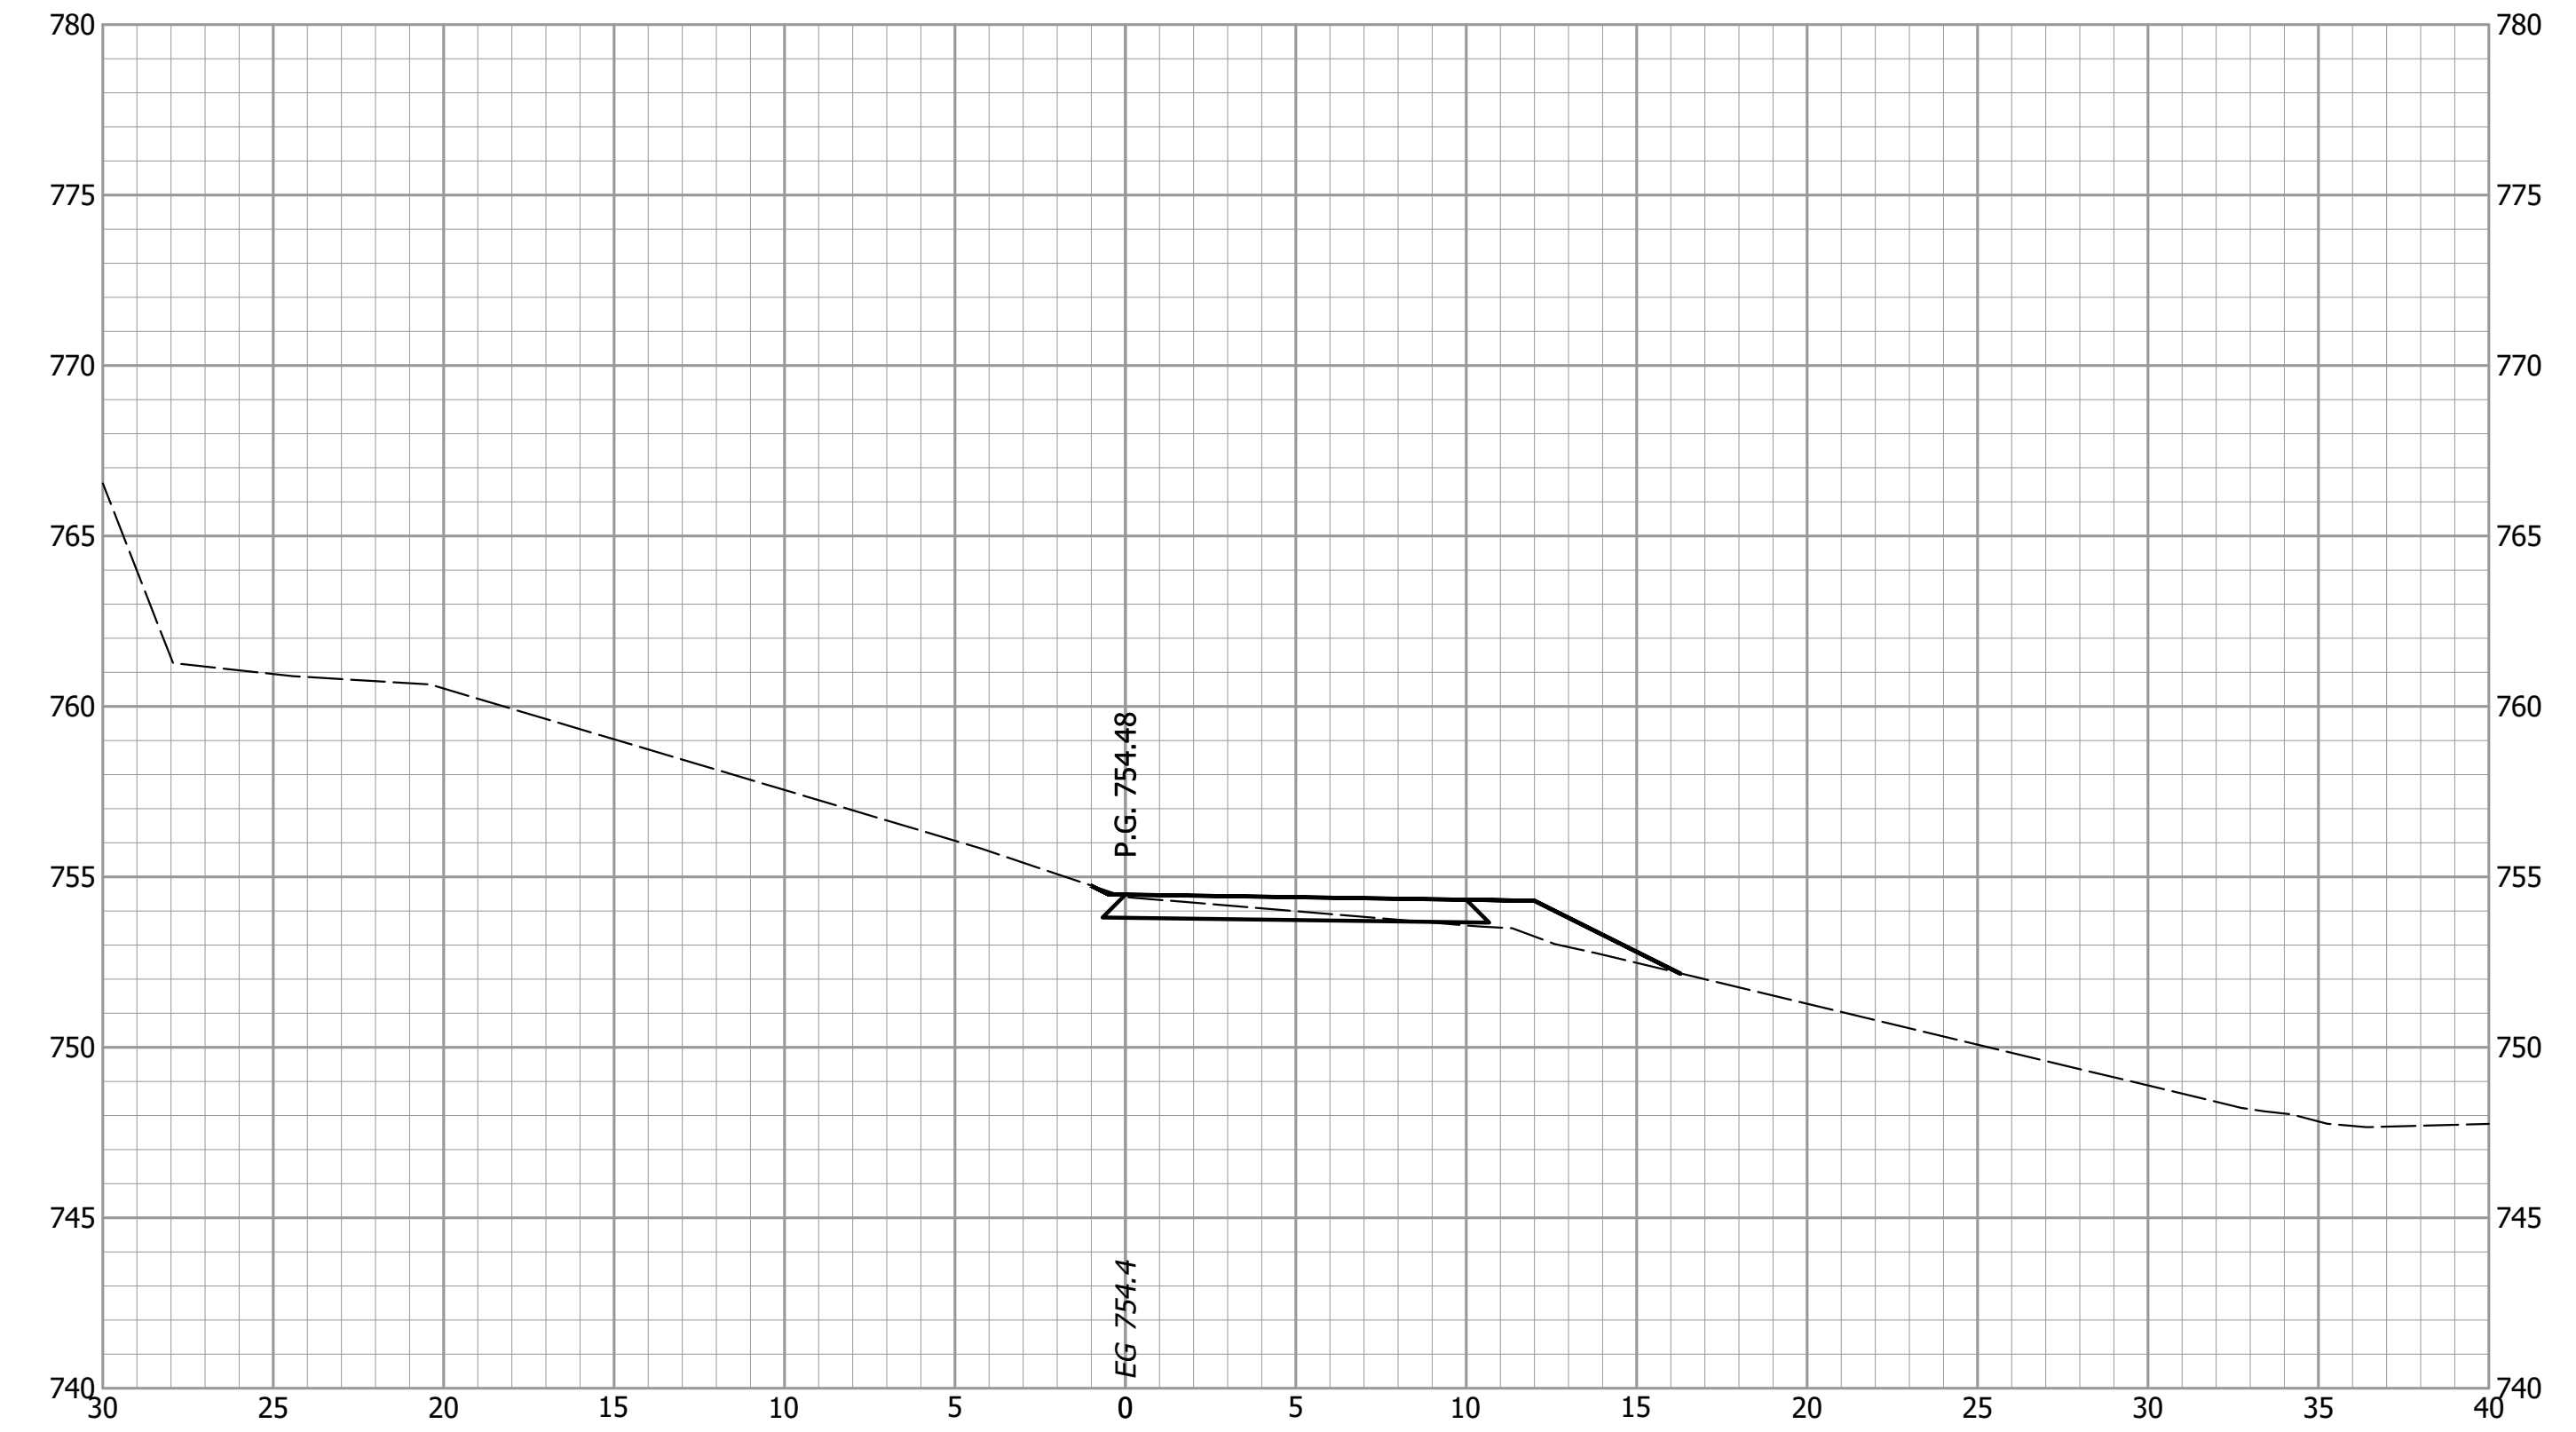

NOT FOR
CONSTRUCTION

DESIGNED: BMA DRAWN: CNC
CHECKED: KAM CHECKED: BMA


INDIANA
DEPARTMENT OF TRANSPORTATION

CROSS SECTIONS
ST. MARYS PATHWAY - LINE "P"


HORIZONTAL SCALE 1" = 5'	BRIDGE FILE ALLEN 358
VERTICAL SCALE 1" = 5'	DESIGNATION 1902834
SURVEY BOOK ----	SHEETS 62 of 63
CONTRACT B-42844	PROJECT 1902834

BEGIN CONSTRUCTION
STA. 4+07 "P"


4+00

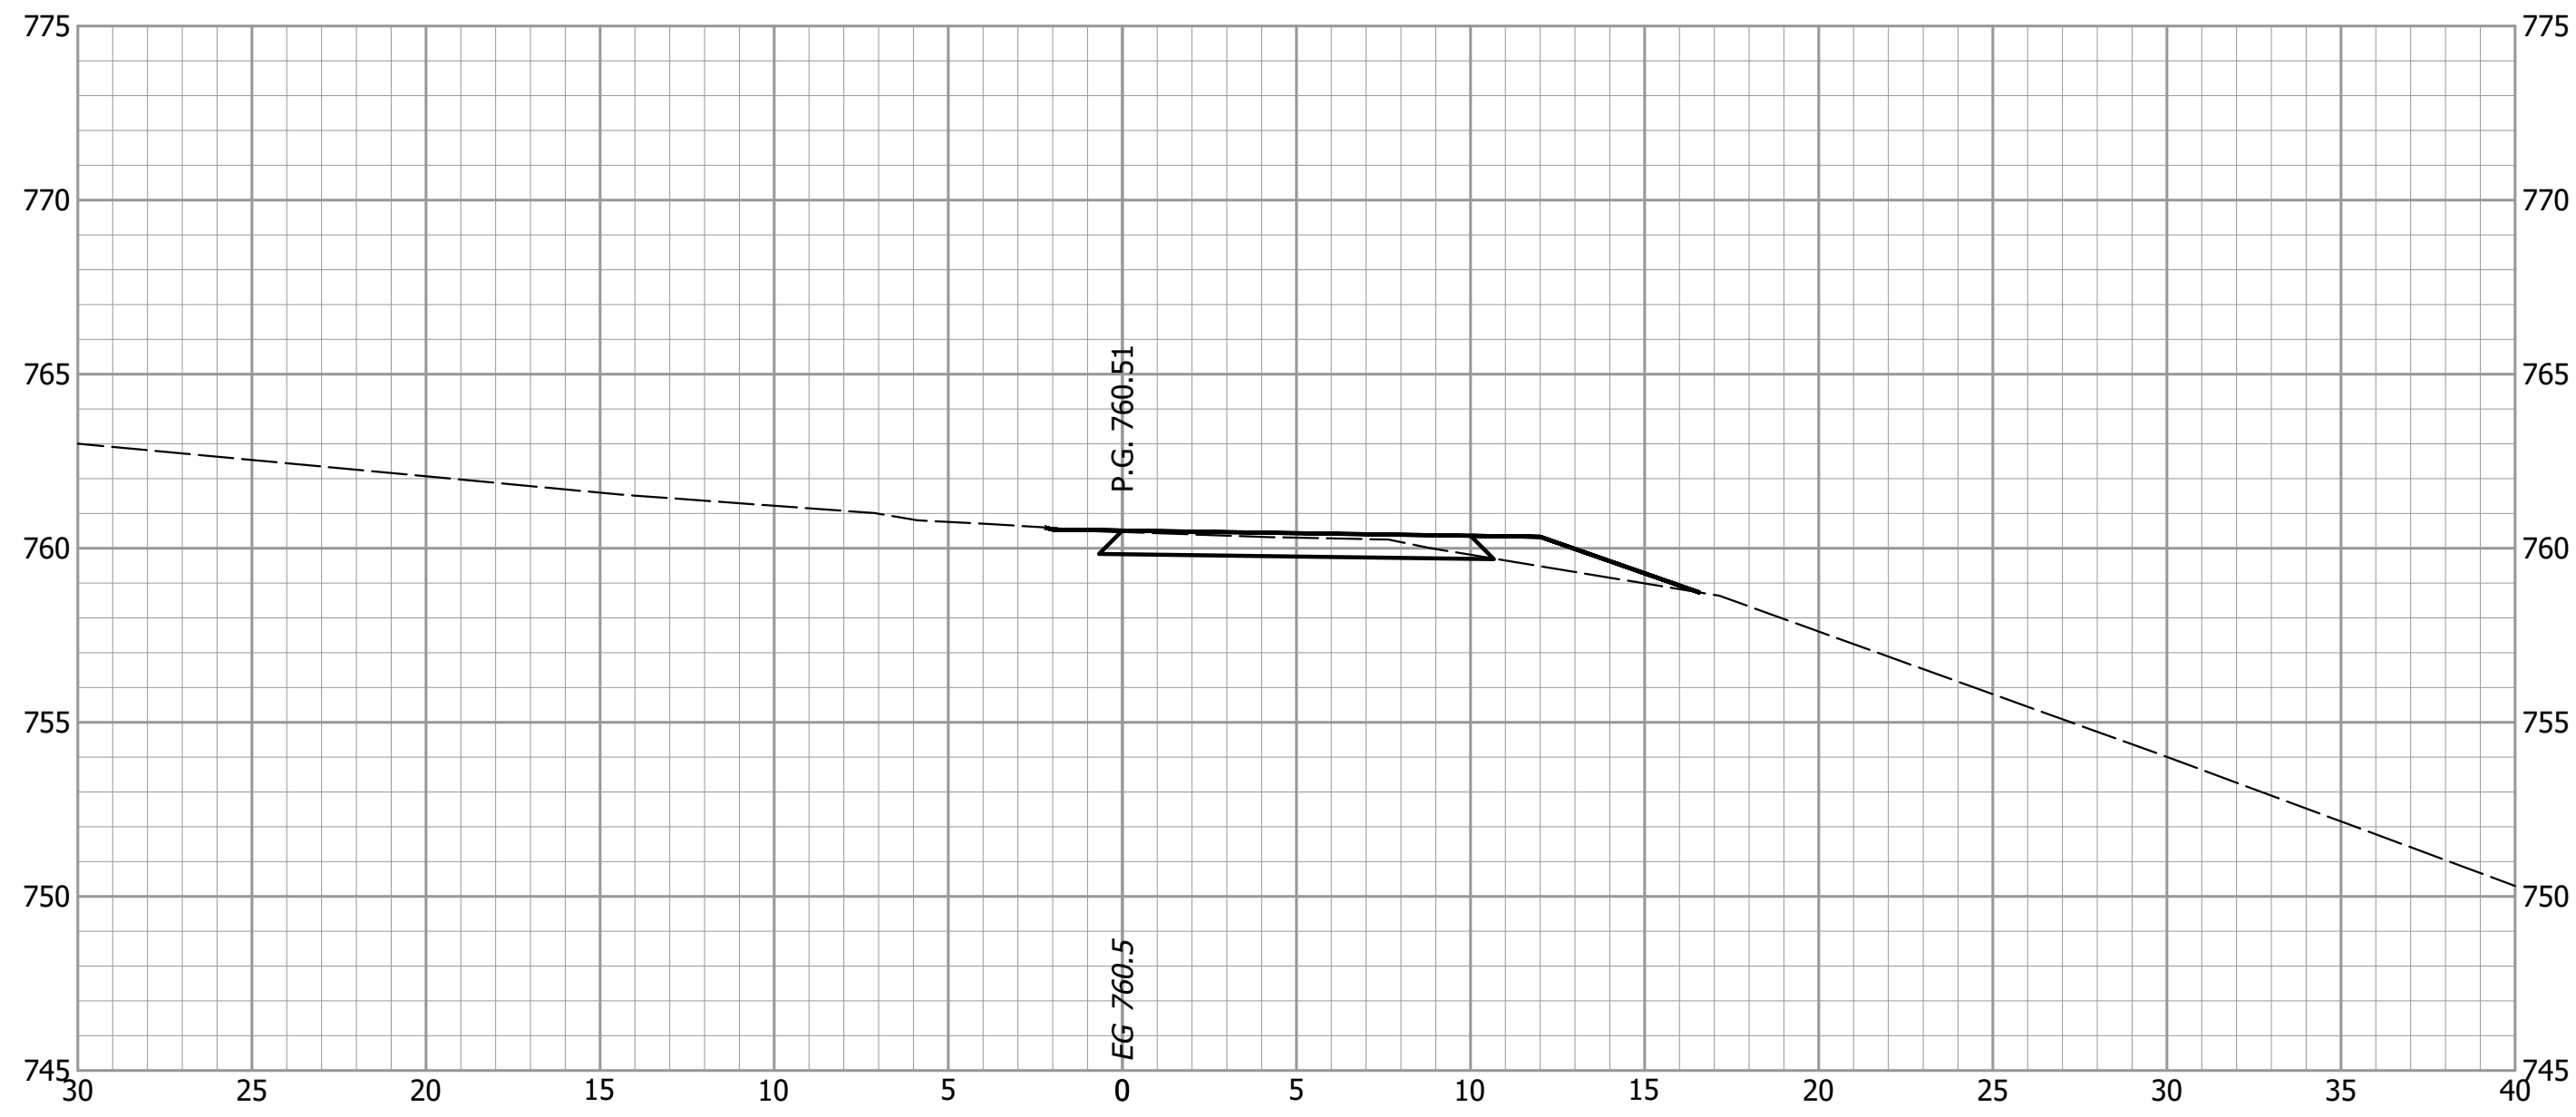

3+50

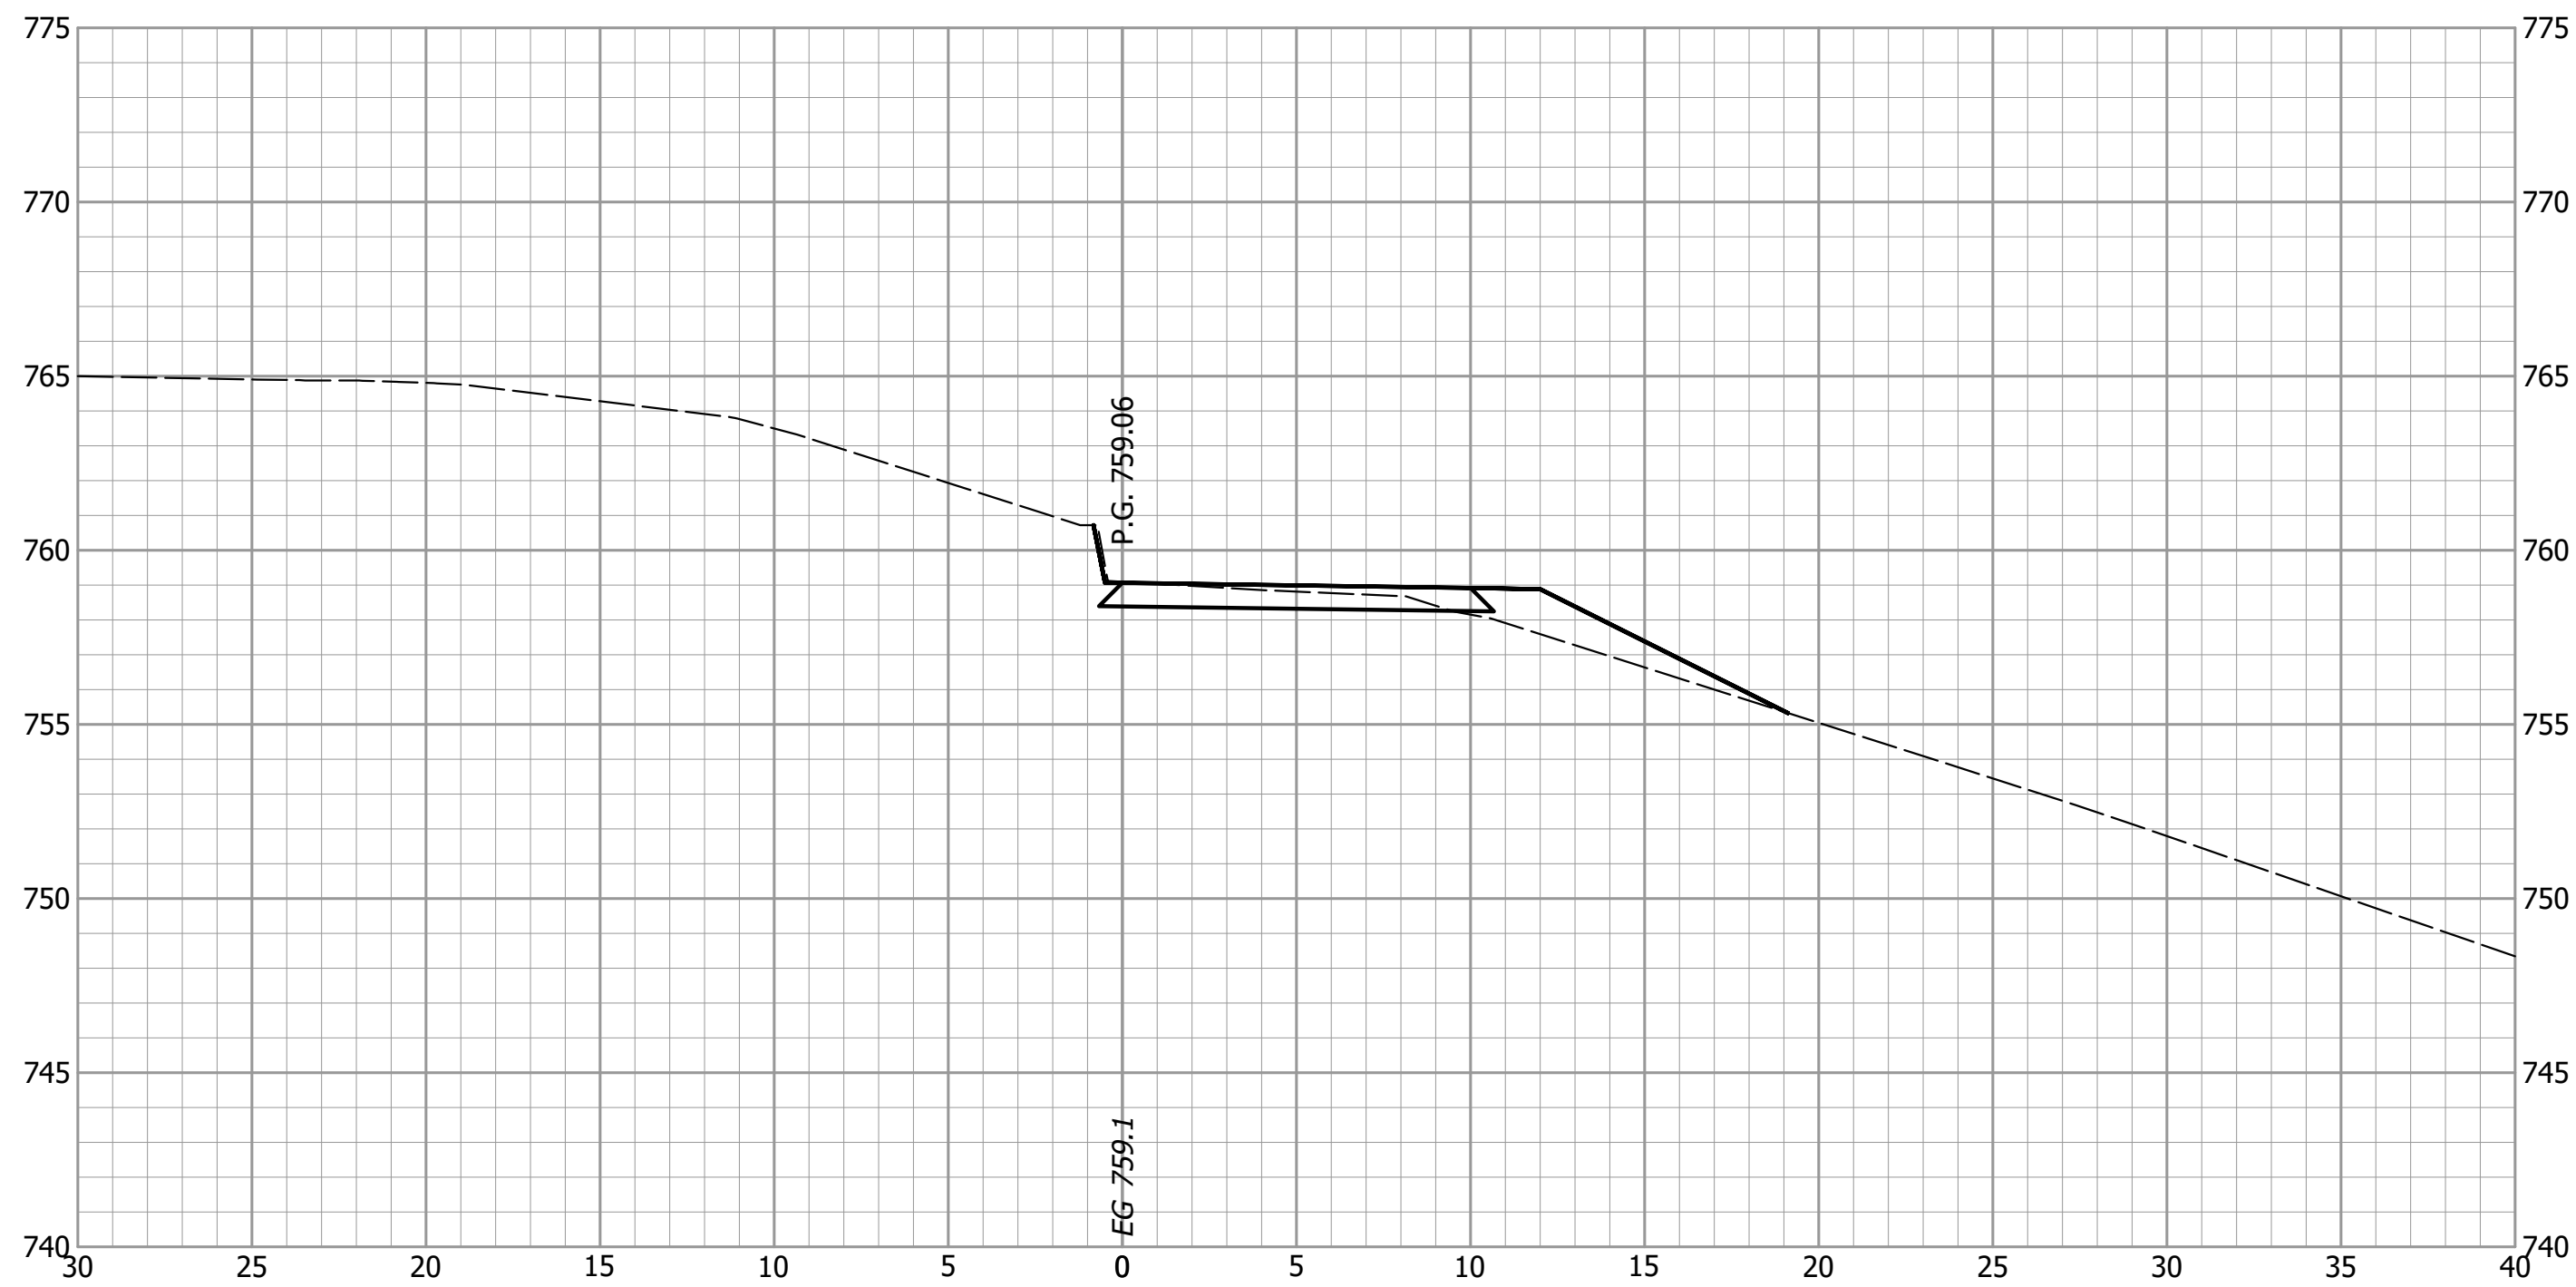

3+75

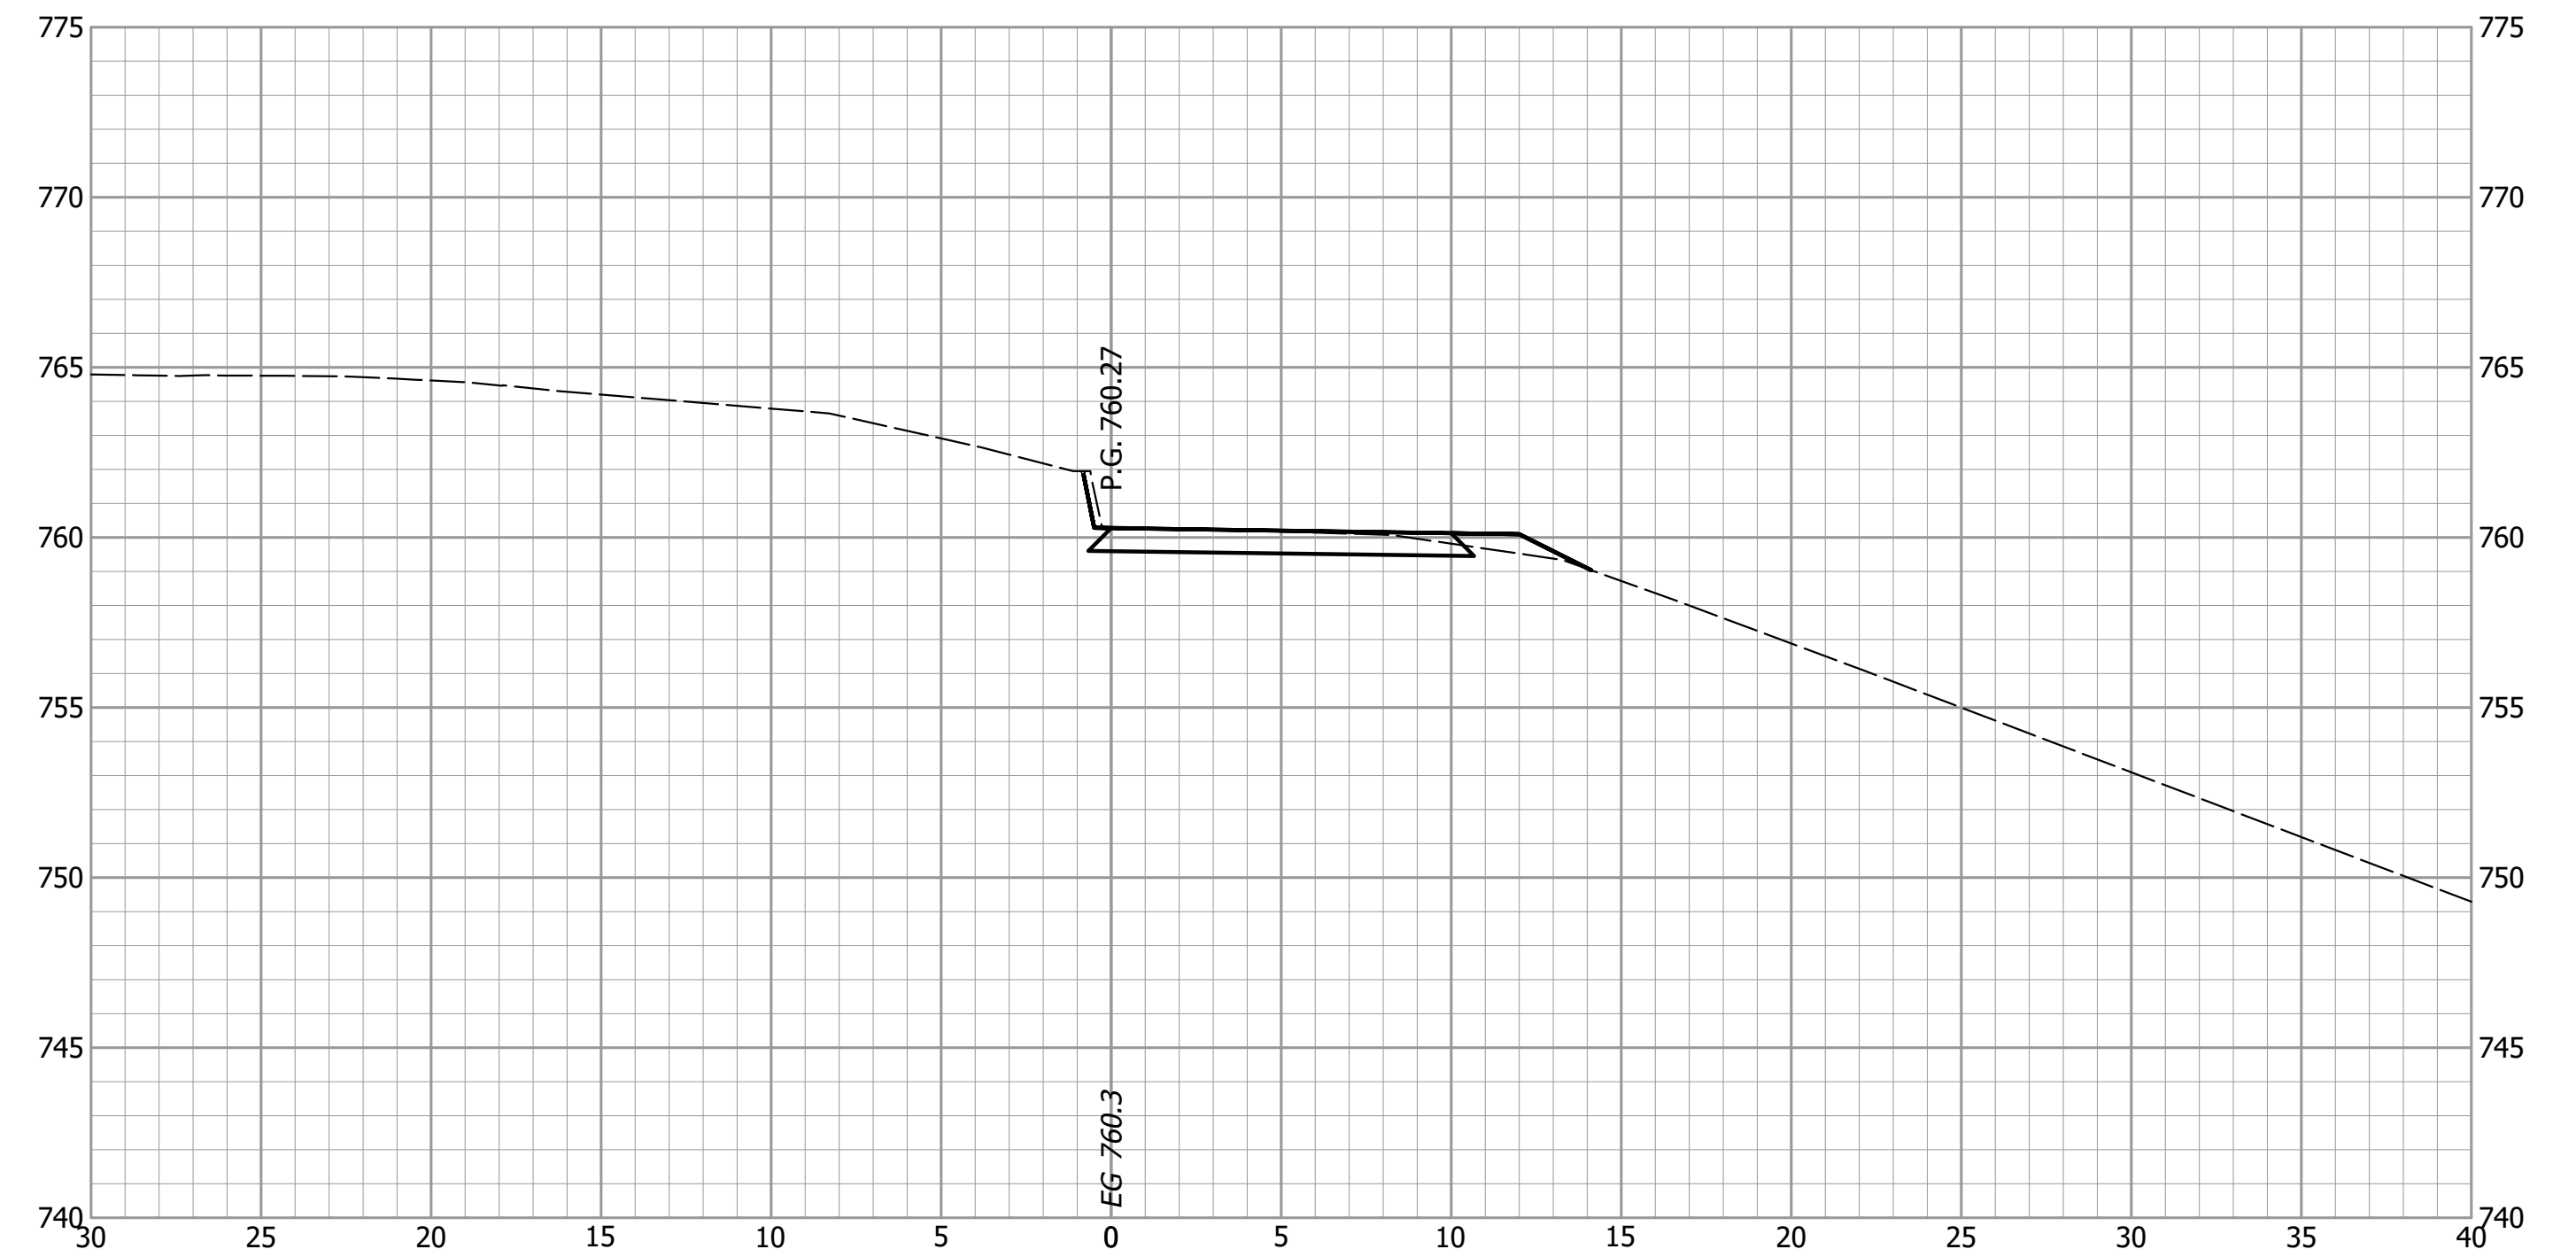

NOT FOR
CONSTRUCTION

DESIGNED: BMA	DRAWN: CNC
CHECKED: KAM	CHECKED: BMA

INDIANA
DEPARTMENT OF TRANSPORTATION

CROSS SECTIONS
ST. MARYS PATHWAY - LINE "P"

HORIZONTAL SCALE 1" = 5'	BRIDGE FILE ALLEN 358
VERTICAL SCALE 1" = 5'	DESIGNATION 1902834
SURVEY BOOK ----	SHEETS 63 of 63
CONTRACT B-42844	PROJECT 1902834